

BUILDING AREA PER UNIT SHEET INDEX ARCHITECTURAL **GROSS** FIRST FLOOR TITLE SHEET UNIT 101 - STUDIO. AFFORDABLE SURVEY UNIT 102 - STUDIO, AFFORDABLE 543 SITE PLAN UNIT 103 - STUDIO 746 OVERALL FIRST FLOOR PLAN UNIT 104 - ONE BEDROOM 730 786 UNIT 105 - STUDIO LEVEL 1, BLDG. A **UNIT 106 - ONE BEDROOM** 800 LEVEL 1. BLDG B UNIT 107 - ONE BEDROOM 795 LEVEL 1. BLDG C **UNIT 108 - ONE BEDROOM** 694 A3.1D LEVEL 1, BLDG D 756 **UNIT 109 - ONE BEDROOM** OVERALL SECOND FLOOR PLAN UNIT 110 - ONE BEDROOM 1,029 LEVEL 2, BLDG A 7,364 SUBTOTAL LEVEL 2, BLDG B LEVEL 2, BLDG C SECOND FLOOR **GROSS** A3.2D LEVEL 2, BLDG D UNIT 201 - TWO BEDROOM 1,343 1,453 OVERALL THIRD FLOOR PLAN 1,152 1,246 UNIT 202 - TWO BEDROOM, AFFORDABLE A3.3A LEVEL 3, BLDG A 574 637 UNIT 203 - STUDIO LEVEL 3, BLDG B UNIT 204 - STUDIO 574 637 LEVEL 3, BLDG C UNIT 205 - STUDIO 617 UNIT 206 - TWO BEDROOM 1.084 LEVEL 3. BLDG D UNIT 207 - ONE BEDROOM 793 OVERALL FOURTH FLOOR AND ROOF DECK PLANS 555 UNIT 208 - STUDIO A3.4A LEVEL 4, BLDG A 1,067 UNIT 209 - TWO BEDROOM 980 A3.4B ROOF DECK, BLDG A 629 697 UNIT 210 - ONE BEDROOM UNIT 211 - TWO BEDROOM 1,015 1,089 LEVEL 4, BLDG C UNIT 212 - TWO BEDROOM 1,029 1,106 OVERALL ROOF PLAN UNIT 213 - ONE BEDROOM 726 795 **BUILDING AREAS** APT. RETAIL AND OFFICE SUITES AREA PLANS SUBTOTAL 10,779 11,778 OVERALL EXTERIOR ELEVATIONS **GROSS** THIRD FLOOR A5.1A NORTH ELEVATION BLDG A 1/4" NORTH ELEVATION BLDG B 1/4" UNIT 301 - TWO BEDROOM 1,343 OVERALL EXTERIOR ELEVATIONS UNIT 302 - TWO BEDROOM 1,152 UNIT 303 - STUDIO 574 EAST ELEVATION BLDG B 1/4' 574 UNIT 304 - STUDIO, AFFORDABLE EAST ELEVATION BLDG C 1/4" UNIT 305 - STUDIO OVERALL COURTYARD EXT. ELEVATIONS UNIT 306 - TWO BEDROOM SOUTH ELEVATION BLDG C 1/4" UNIT 307 - ONE BEDROOM 499 SOUTH ELEVATION BLDG D 1/4" UNIT 308 - STUDIO UNIT 309 - TWO BEDROOM OVERALL COURTYARD EXTERIOR ELEVATIONS UNIT 310 - ONE BEDROOM 628 A5.4A WEST ELEVATION BLDG A 1/4" UNIT 311 - TWO BEDROOM WEST ELEVATION BLDG D 1/4" 1,029 **UNIT 312 - TWO BEDROOM EXTERIOR FINISHES** UNIT 313 - ONE BEDROOM EXTERIOR FINISHES 10,769 SUBTOTAL EXTERIOR FINISHES EXTERIOR FINISHES FOURTH FLOOR **BLDG A SECTION BLDG B SECTION** UNIT 401 - TWO BEDROOM **BLDG C SECTION** UNIT 402 - ONE BEDROOM UNIT 403 - STUDIO BLDG D SECTIONS DOOR WINDOW SCHEDULE BLDG A **SUBTOTAL** DOOR WINDOW SCHEDULE BLDG B DOOR WINDOW SCHEDULE BLDG C **TOTAL RESIDENTIAL AREA** 30,481 DOOR WINDOW SCHEDULE BLDG D COMMERCIAL UNIT STATISTICS FINISHES. MATERIALS A10.1 ARCHITECTURAL DETAILS FIRST FLOOR A10.2 ARCHITECTURAL DETAILS

A10.3

A10.4

A10.8

A10.9

C-0.2

A10.10

ARCHITECTURAL DETAILS

ARCHITECTURAL DETAILS

ARCHITECTURAL DETAILS

FIRE RATED WALL DETAILS

ARCHITECTURAL DETAILS

ARCHITECTURAL DETAILS

ARCHITECTURAL DETAILS

ARCHITECTURAL DETAILS

ARCHITECTURAL DETAILS

PRELIMINARY IRRIGATION PLAN

PRELIMINARY HYDROZONE PLAN

PRELIMINARY HYDRO-ZONE PLAN

PRELIMINARY PLANTING PLAN

PRELIMINARY LIGHTING PLAN

GRADING AND DRAINAGE PLAN

TITLE SHEET

NOTES SHEET

UTILITY SHEET

DETAIL SHEET

PRELIMINARY LANDSCAPE LAYOUT PLAN

LANDSCAPE

CIVIL

1,453 1.248 637 637 617 1.084 793 1.067 697 1,089 1,106 795 11,778 **GROSS** 1,068 795 555 2,418 33,345 **GROSS** 2,063 2,318 RETAIL/FUTURE RESTAURANT UNIT 1 (BLDG A)

RETAIL/FUTURE RESTAURANT UNIT 2 (BLDG B) 1,715 1,890 1,023 1,172 BUSINESS UNIT 3 (BLDG D) OFFICE 201 (BLDG C) 676 742 OFFICE 202 (BLDG C) 919 984 1,236 OFFICE 203 (BLDG C 1,142 OFFICE 301 (BLDG C 666 742 OFFICE 302 (BLDG C) 917 984 1,236 OFFICE 303 (BLDG C) OFFICE 401 (BLDG C 876 OFFICE 402 (BLDG C) 1.330 1,425 **SUBTOTAL** 13,629 12,403

GMP FLOOR AREA TABLE TO CONSTRUCT PARCEL (E) AREA DEMOLISH CREDIT 037-131-024 FROM LOT MERGER: 11,679 12,486 1,078 11,679 037-131-022 (17 W. ORTEGA ST.) 9,913 1,078

PROJECT DIRECTORY

ARCHITECT **OWNER** Third Generation SB. LLC Tom Meanev 629 State Street, Suite 240 629 State Street, Suite 240 Santa Barbara, CA 93101 Santa Barbara, CA 93101 (805) 966-7668 (805) 966-7668 Lic. No. C14606

CIVIL ENGINEER Ashley Vance Engineering, Inc. 210 East CotA Street Santa Barbara, CA 93101 (805) 962-9966

STRUCTURAL ENGINEER Studio Engineers, Inc. 11 West Figueroa Street Santa Barbara, CA 93101

Bakersfield, CA 93308 (661) 327-1436 ELECTRICAL ENGINEER Alan Noelle Engineering 1616 Anacapa St, Santa Barbara, CA 93101

SURVEYOR

Goleta, CA 93117

3325 Landco Drive

(805) 685-4500

Lic. No. 7643

Gilmore Land Surveying Inc.

GENERAL CONTRACTOR

Wallace & Smith Contractors

7127 Hollister Ave., No. 25A-301

VICINITY MAP

LANDSCAPE ARCHITECT

Santa Barbara, CA 93101

MECH./PLUMB. ENGINEERS

Cantelmi Engineering, Inc.

Bakersfield, CA 93301

1227 De La Vina Street

Earthform Design

(805) 963-2006

2130 F Street

(661) 324-5252





STUDIO - AFFORDABLE 3 UNITS 10 UNITS STUDIO 12 UNITS 1 BEDROOM 2 BEDROOM - AFFORDABLE 1 UNIT 13 UNITS 2 BEDROOM **AVERAGE UNIT SIZE, NET:**

781.6 S.F.

30,481 S.F. **ALL LEVELS: 39 UNITS UNIT TYPE BREAKDOWN SUMMARY**

* CAR PARKING OFFSITE

TOTAL FLOOR AREA, S.F.

COMMERCIAL SPACE

RESIDENTIAL SPACE

UTILITY, STORAGE

PROPOSED FLOOR AREA (PLANNING)


* BIKE PARKING, ELEC. (EXIST. BLDG.)


49,942

13,629

1,936


12,403

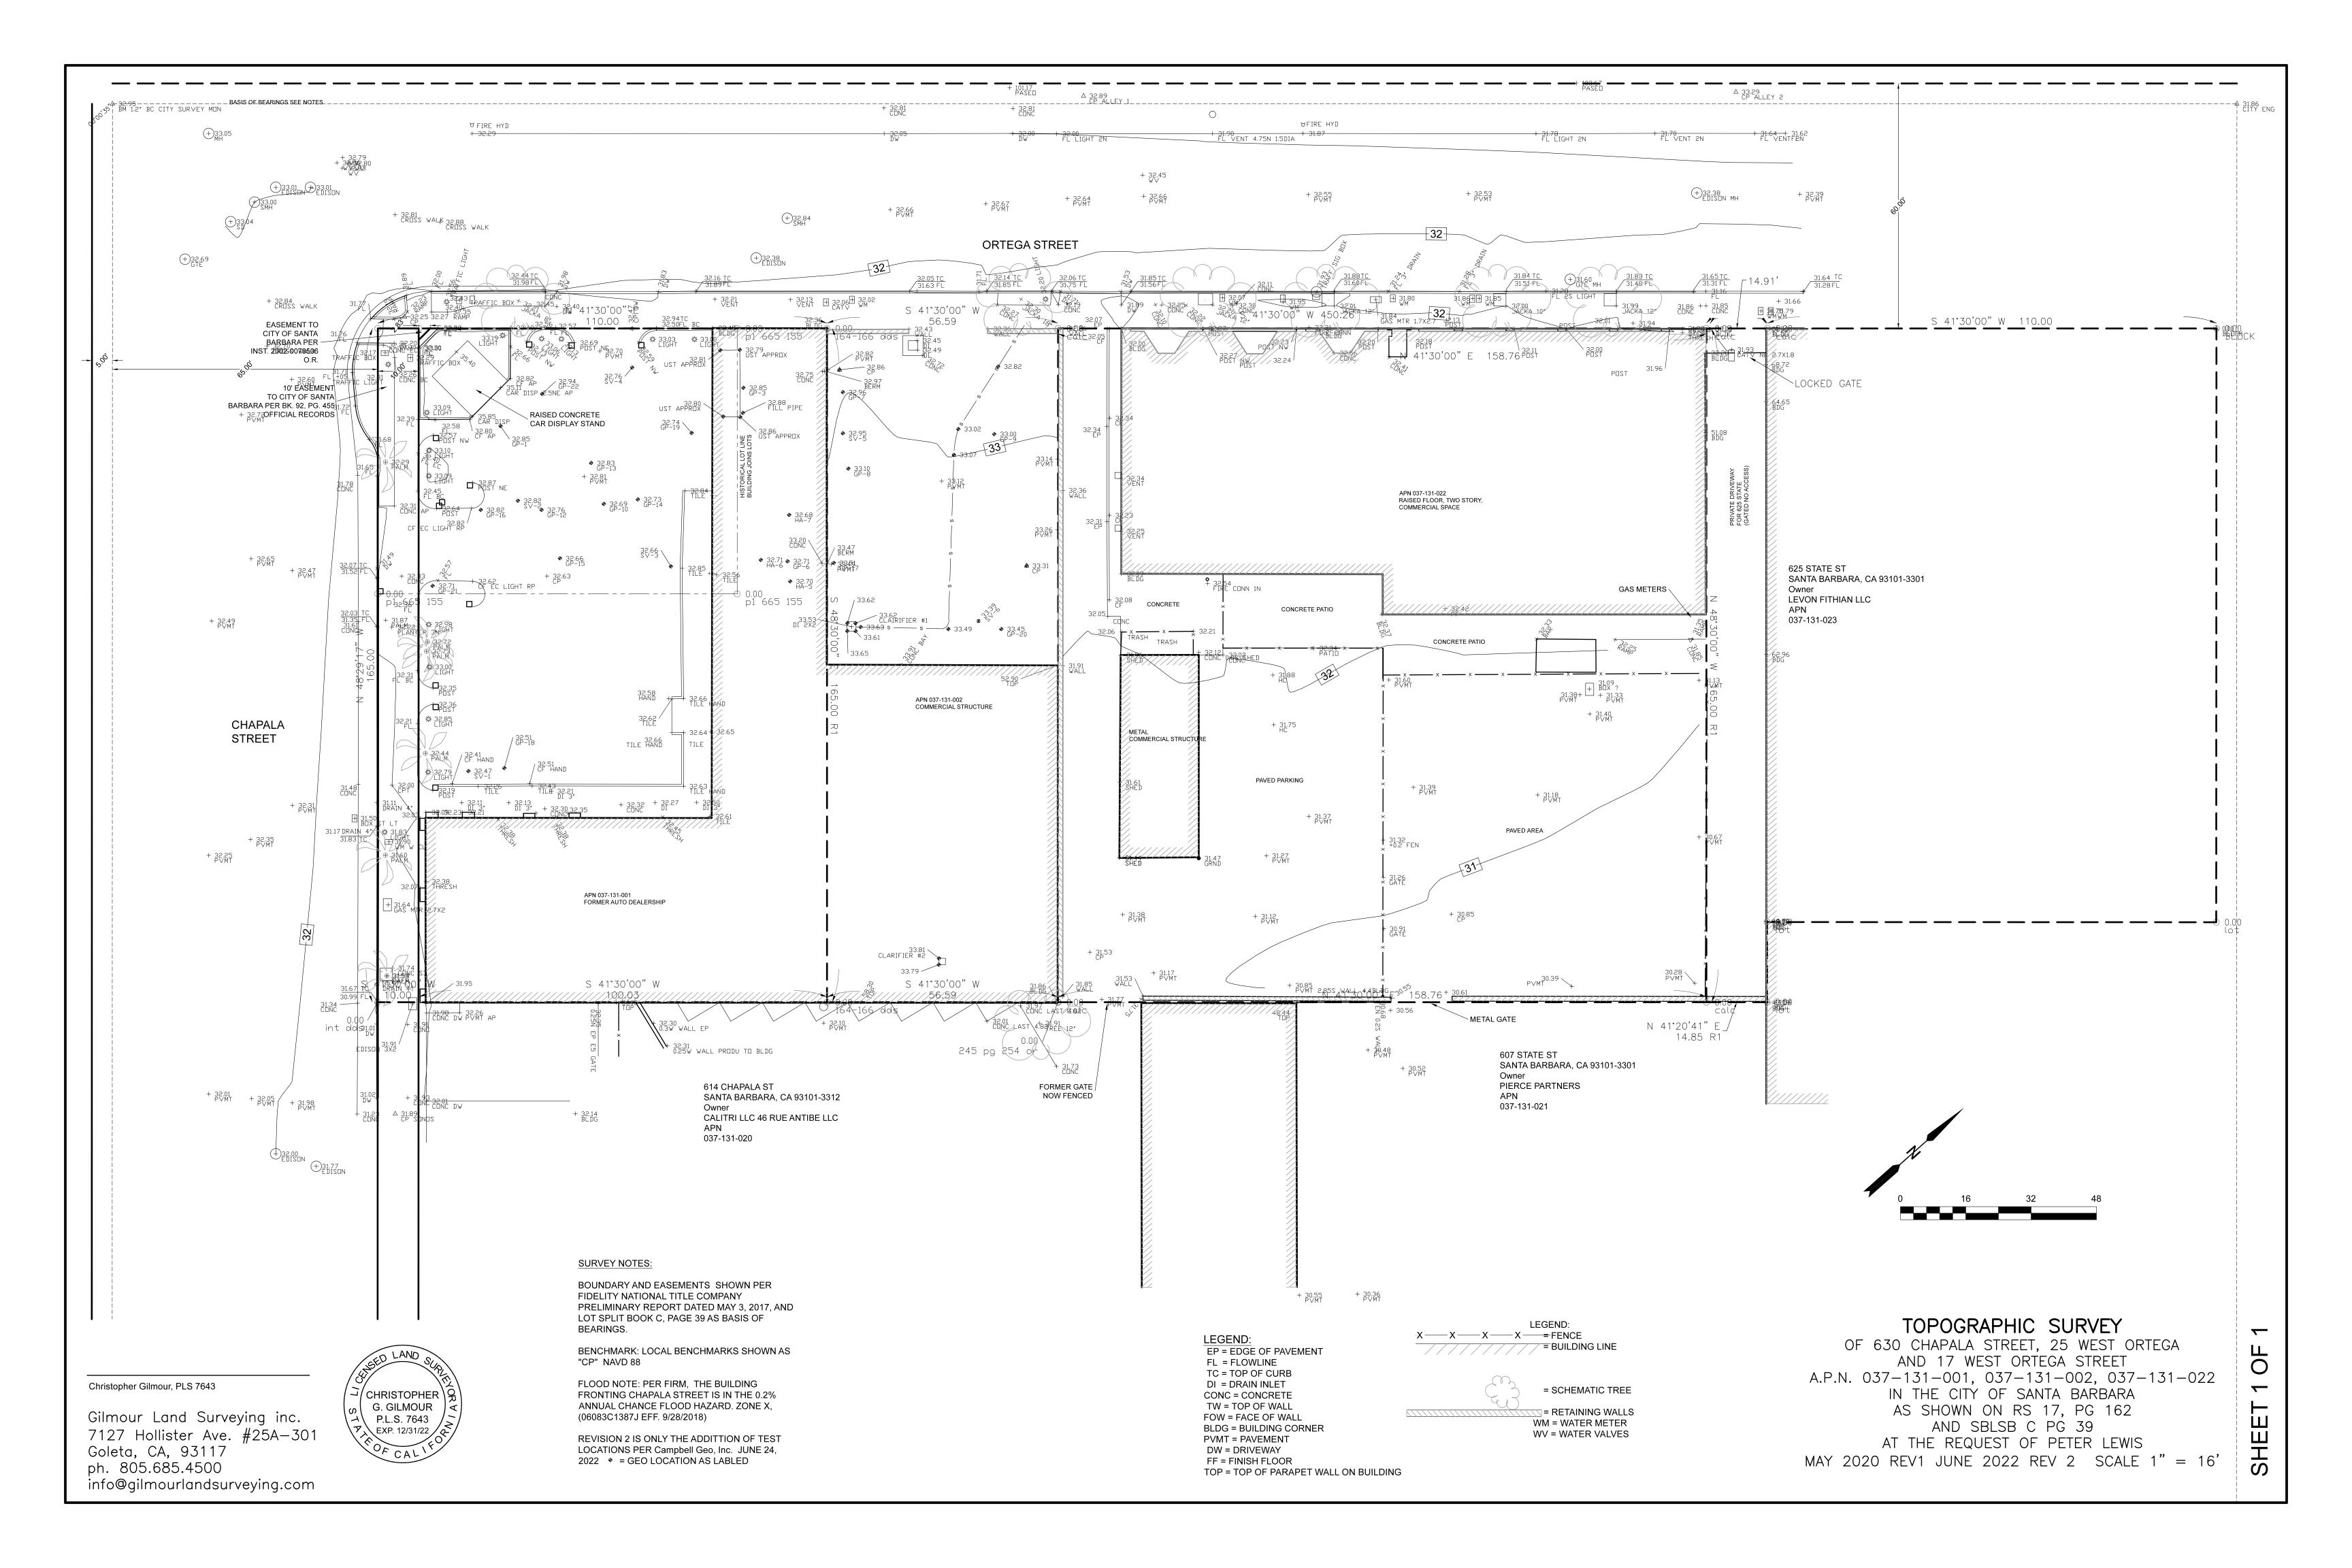

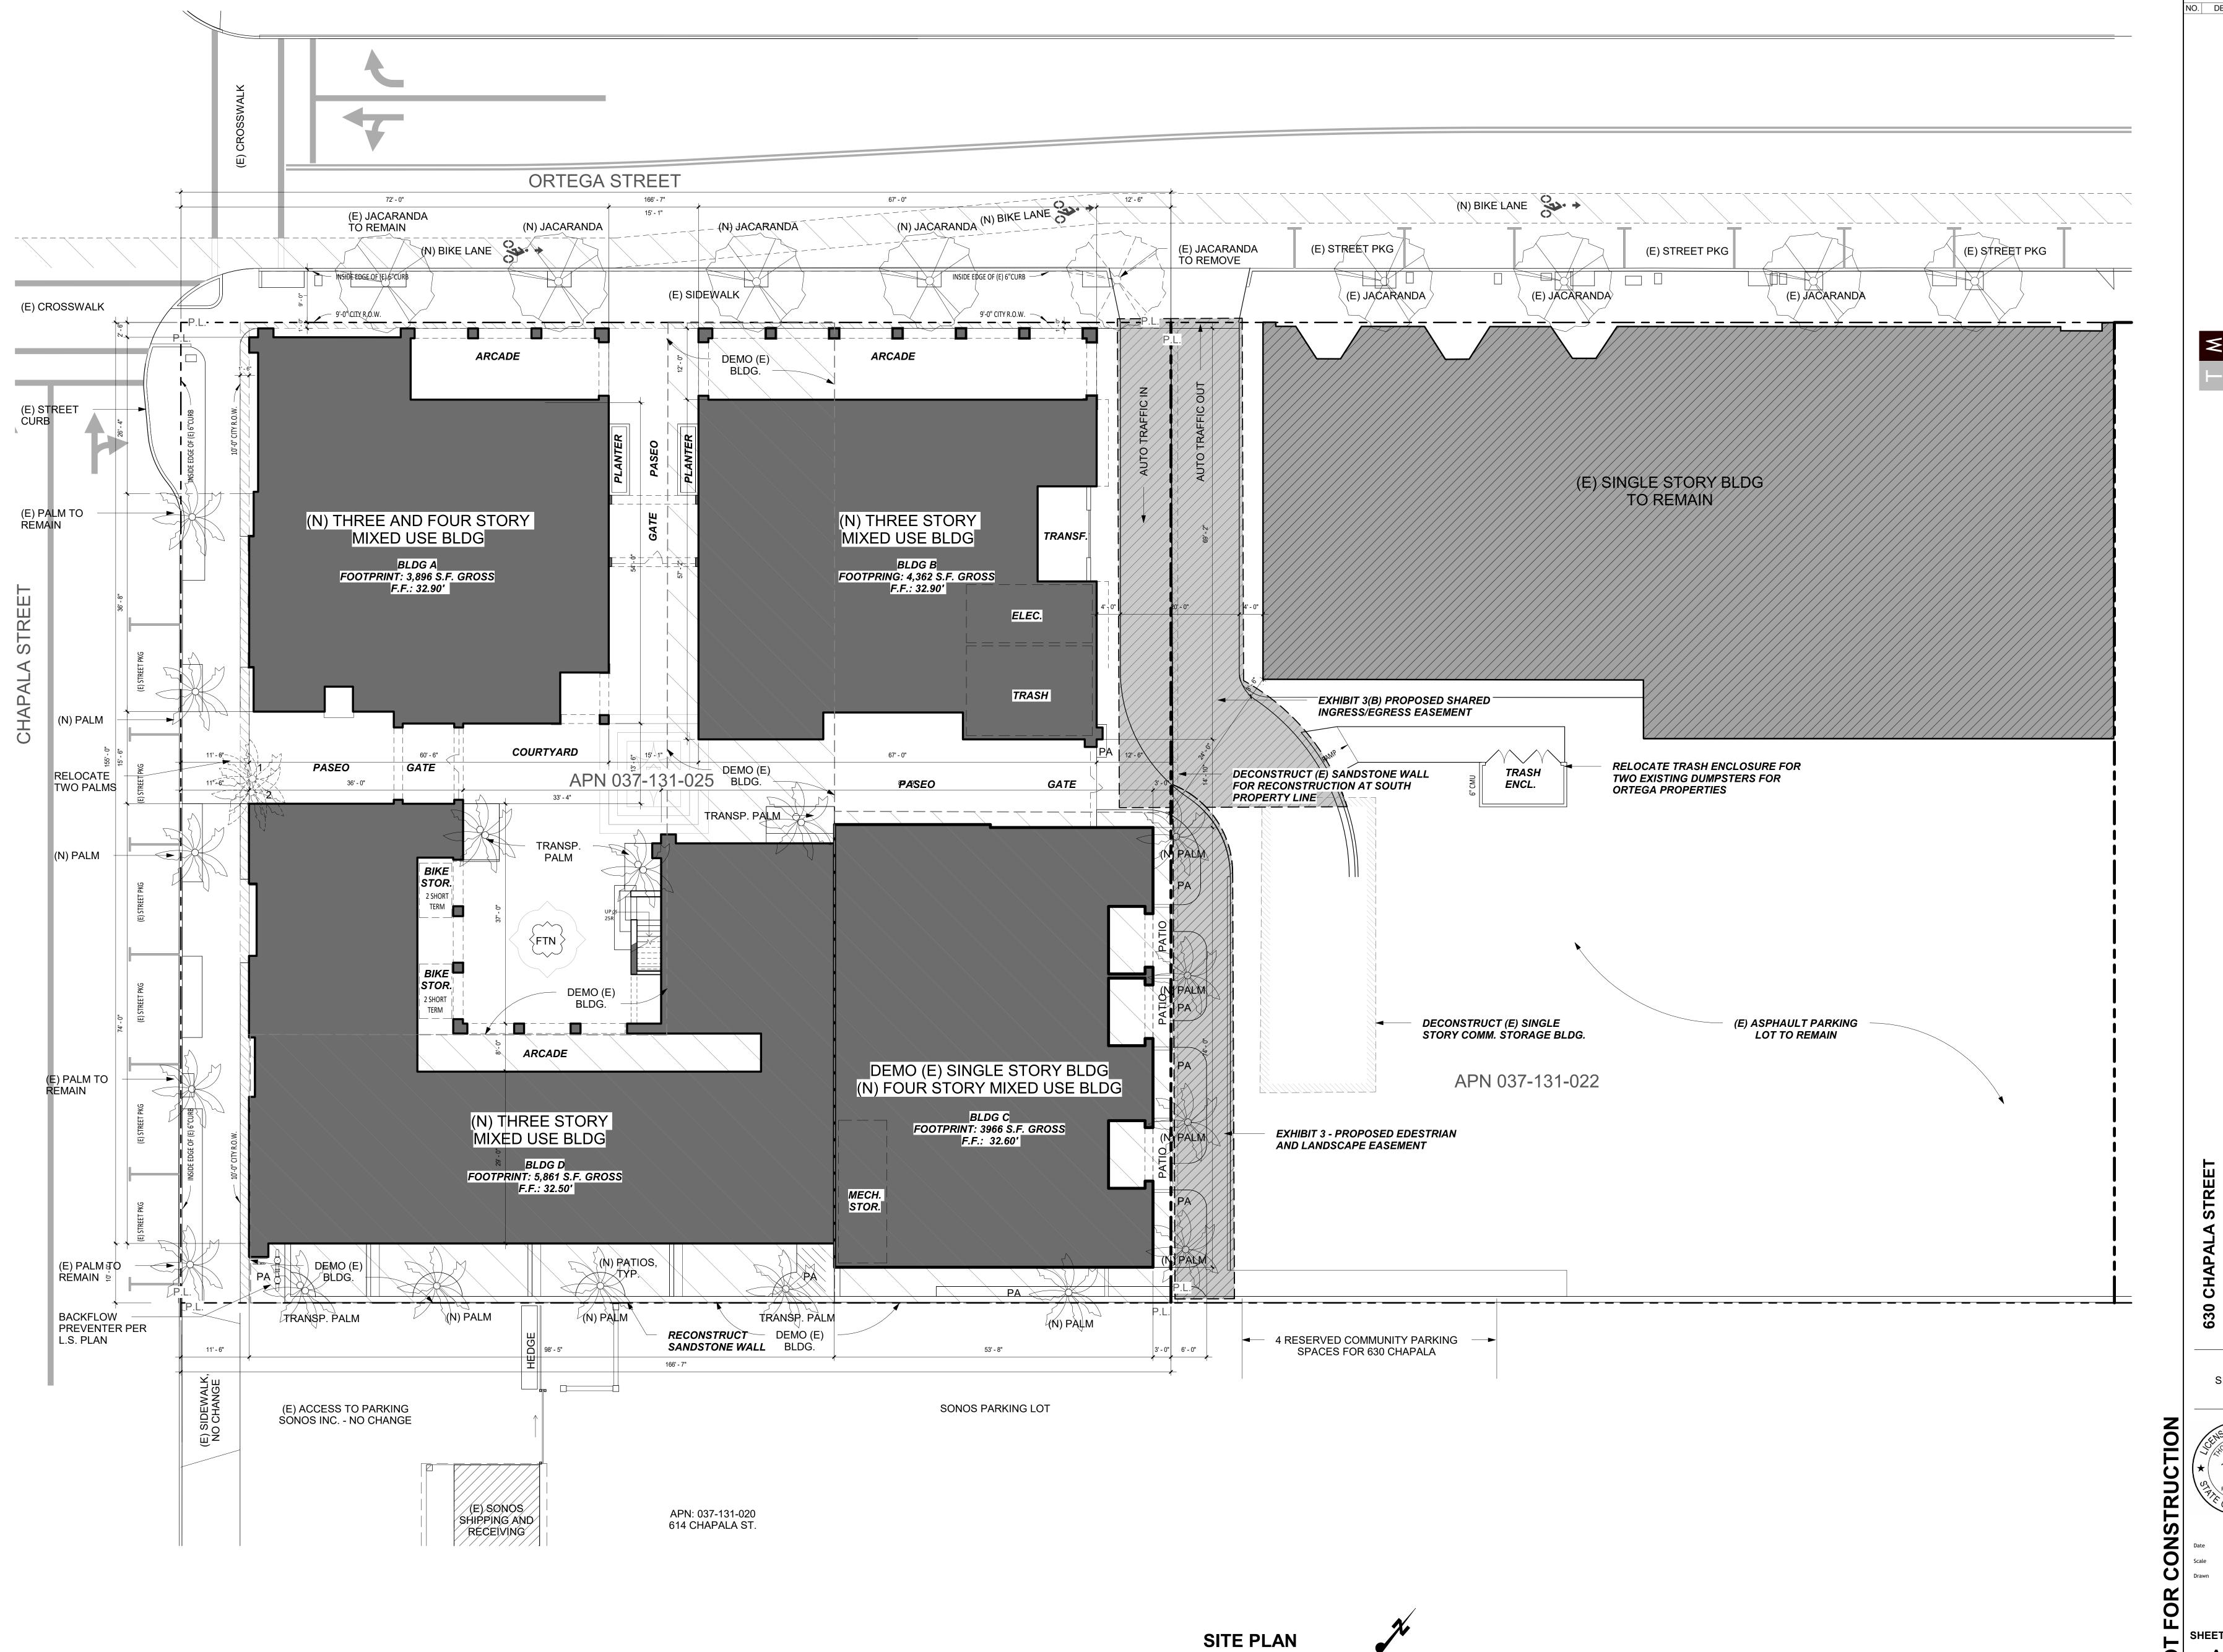

REVISION SCHEDULE NO. DESCRIPTION DATE

SITE PLAN

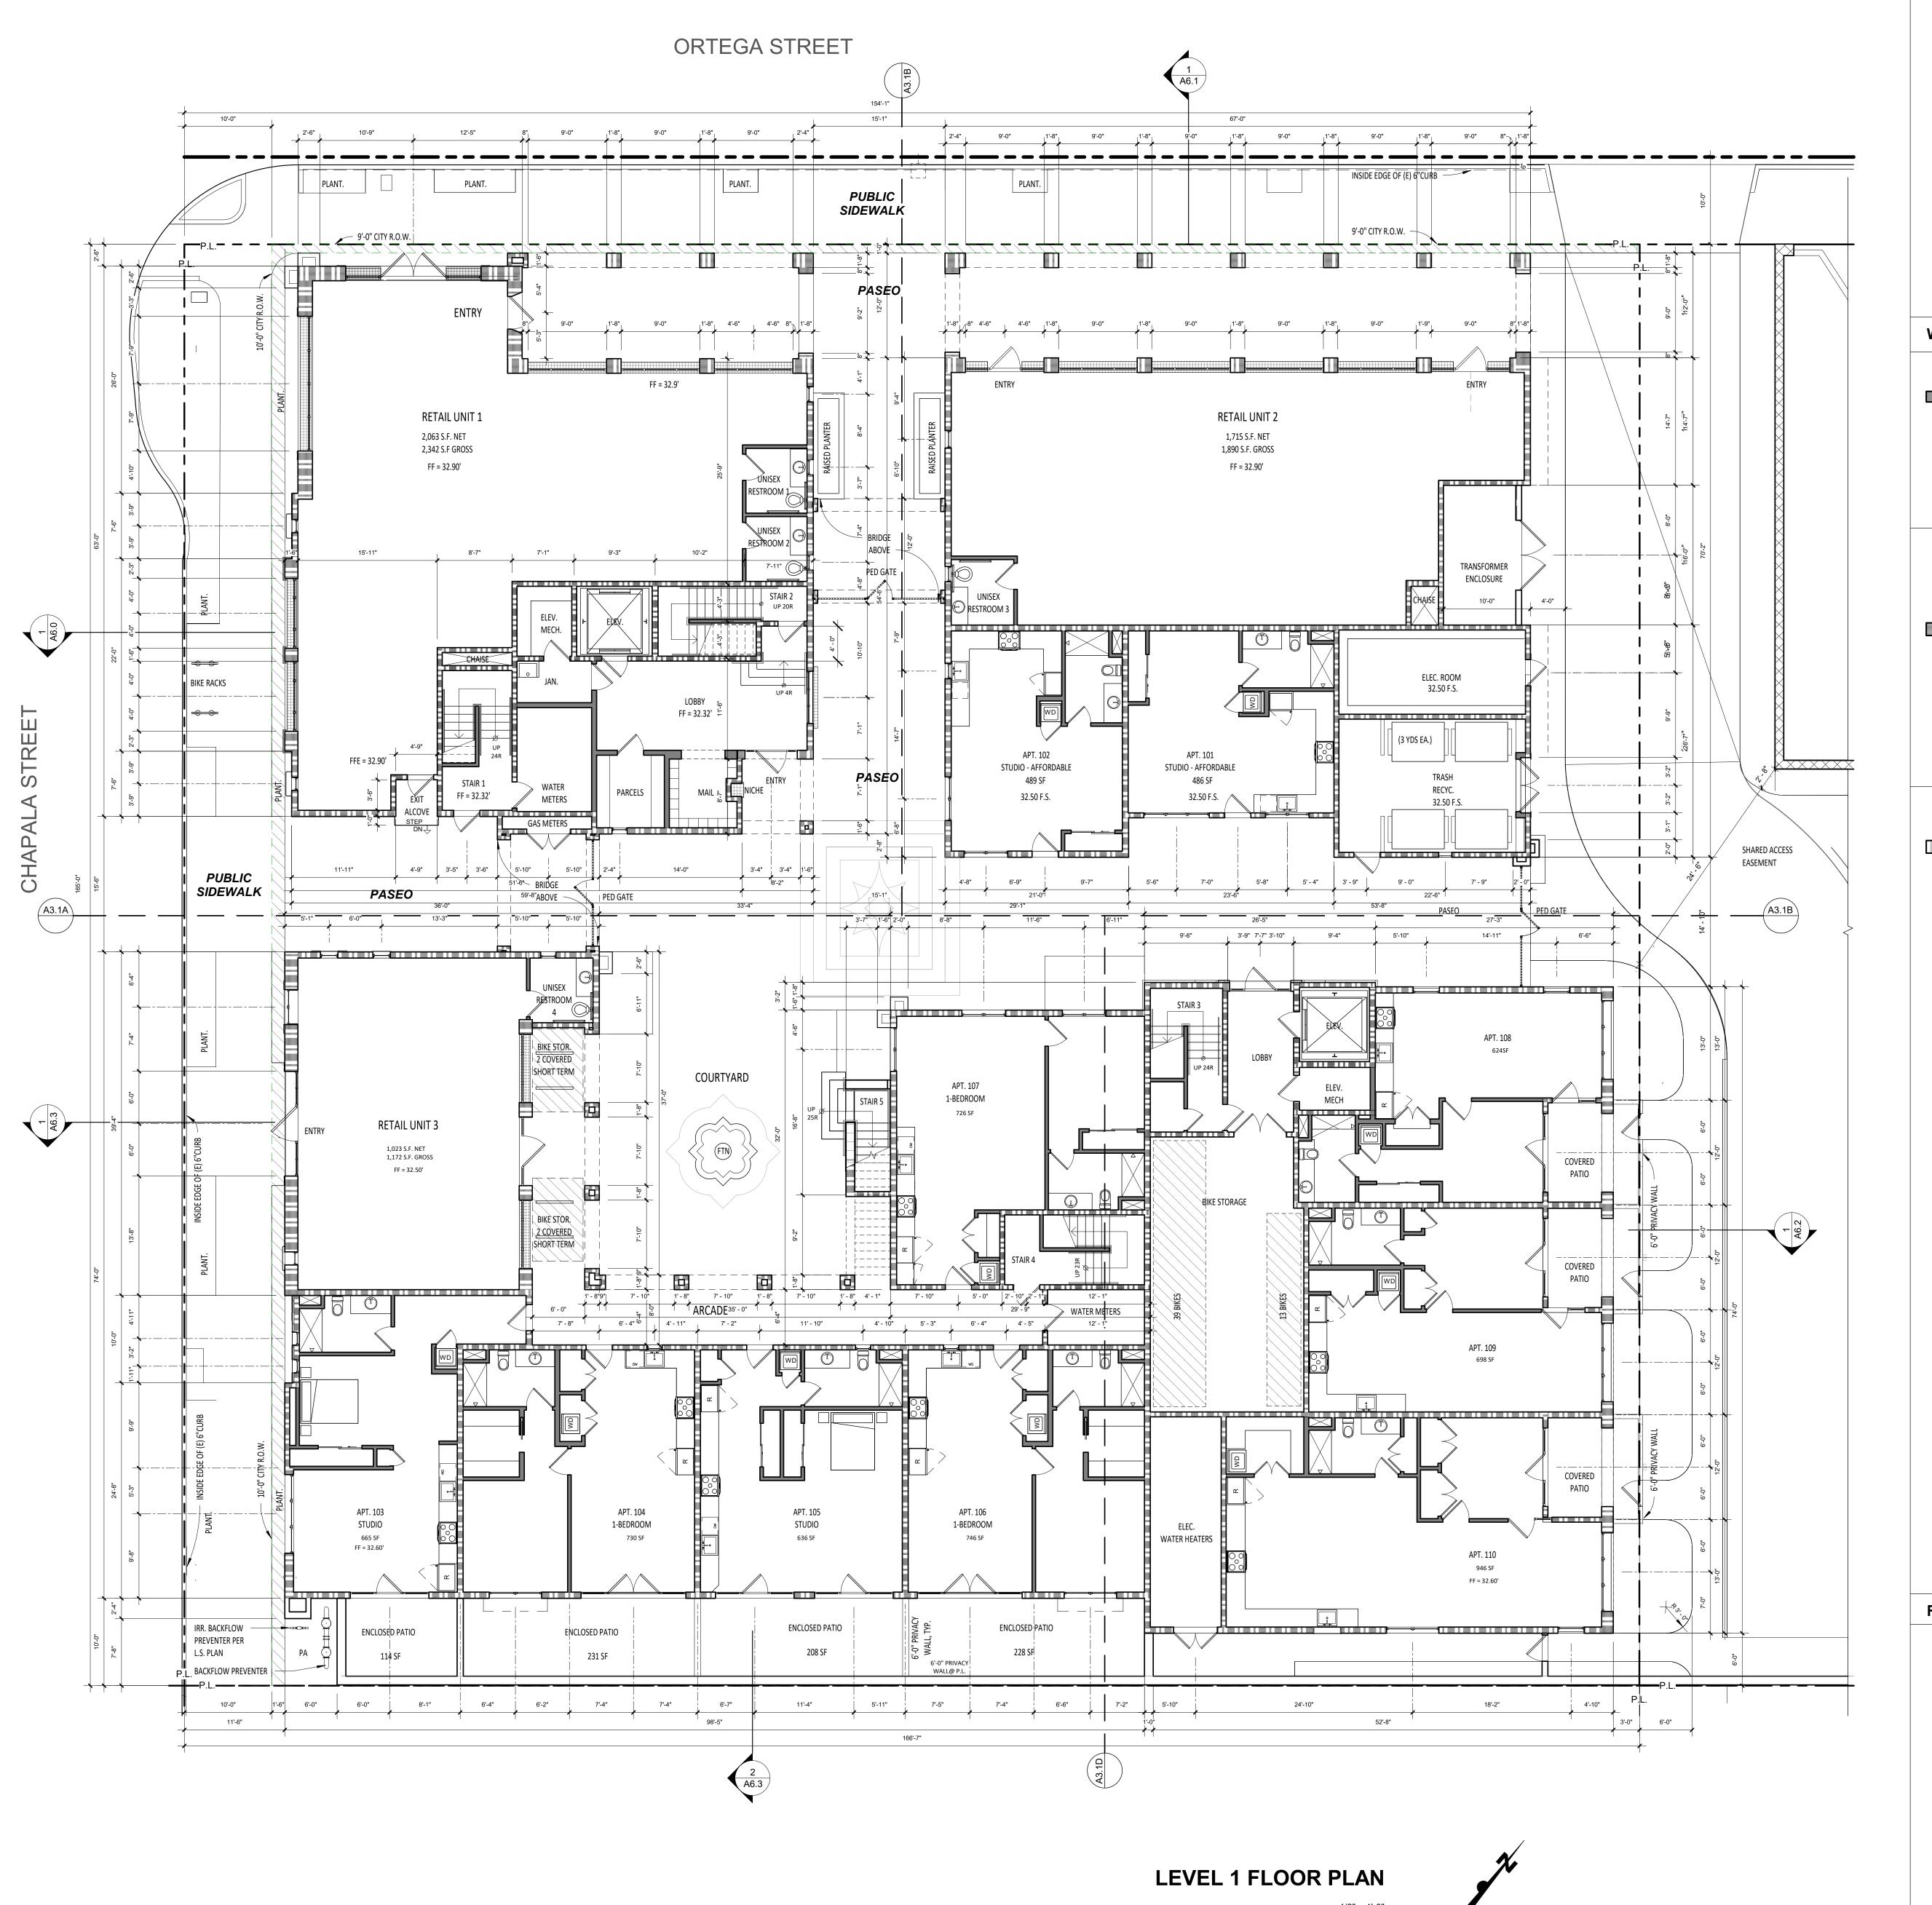

GENERAL NOTES A. REFER TO STRUCTURAL FOR WALL FRAMING INFORMATION, U.N.O. B. ALL DIMENSIONS ARE TO FRAMING, NOT FINISH WALL. EXCEPT AS NOTED PER LEGEND. C. FIRE BLOCKING SHALL BE PROVIDED: 1. IN CONCEALED SPACES OF STUD WALLS AND PARTITIONS, INCLUDING FURRED SPACES, AT THE CEILING AND FLOOR LEVELS@ 10 INTERVALS BOTH HORIZONTAL AND VERTICAL. 2. AT ALL INTERCONNECTIONS BETWEEN CONCEALED VERTICAL & HORIZONTAL SPACES SUCH AS SOFFITS, DROP CEILINGS AND COVE CEILINGS. 3. IN OPENINGS AROUND VENTS, PIPES, DUCTS, CHIMNEYS, FIREPLACES & SIMILAR OPENINGS WHICH AFFORD A PASSAGE FOR FIRE AT CEILING &FLOOR LEVELS, WITH NON-COMBUSTIBLE D. SAFETY GLAZING SHALL BE IN CONFROMANCE WITH THE APPLICABLE UBC CHAPTER IN THE FOLLOWING AREAS: 1. GLAZING WITHIN 24" OF DOORS AND 18" OF FLOORS. 2. WITHIN TUB ENCLOSURES. 3. WITHIN HOT-TUB WHIRLPOOLS, SAUNAS, STEAM ROOMS, GLAZING IN ANY PORTIONS OF SAUNAS, STEAM ROOMS, TUBS AND SHOWERS WHERE THE BOTTOM EDGE OF THE GLAZING IS LESS THAN 60" ABOVE A STANDING SURFACE AND DRAIN INLET. 4. GLAZING IN STAIR LANDING AND WITHIN 5-0" OF THE BOTTOM AND TOP OF THE STAIRWAY AND WITHIN 5-0" OF POOL EDGES. 5. PROVIDE SAFETY GLAZING AT ALL SWINGING AND SLIDING DOORS. E. ALL FINISHES TO BE SPECIFIED BY OWNER. VERIFY WITH ARCHITECT. F. REFER TO CAL GREEN NOTES WHERE APPLICABLE RESILIENT MATTING TO BE INSTALLED UNDER THE FLOOR FINISH FLOORING TO REDUCE LATERAL IMPACT NOISE TO ADJACENT UNITS AND IMPACT NOISE TO RESIDENTIAL/COMMECIAL SPACES BELOW RESIDENTAIL UNITS. VERIFY WITH ARCHITECT. WALL LEGEND **NON-RATED** INTERIOR 2X6 WALL, DETAIL 46 INTERIOR 2X4 WALL, DETAIL 46 EXTERIOR BLOCK WALL WITH PLASTER OR STONE' THICKNESS PER PLAN, DETAIL __ 1 HOUR-RATED EXTERIOR DOUBLE STUD WALL, DETAIL 49 EXTERIOR 2X8 WALL WITH PLASTER OR STONE, DETAIL 48 EXTERIOR 2x6 STUD WALL, DETAIL 48 INTERIOR 2X4 WALL, DETAIL 47 INTERIOR 2X6 WALL, DETAIL 47 INTERIOR DOUBLE STUD WALL, DETAIL 52 2 HOUR-RATED INTERIOR 2X6 WALL, DETAIL 50 N-8 INTERIOR DOUBLE STUD WALL, DETAIL 51 INTERIOR DOUBLE STUD SHAFT WALL, DETAIL 51 INTERIOR 2X STUD SHAFT WALL, DETAIL 50 EXTERIOR 2X6 WALL, DETAIL 53 EXTERIOR DOUBLE STUD WALL, DETAIL 54 EXTERIOR 2x6 STUD SHAFT WALL, DETAIL 53 X WINDOW TAG NUMBER X DOOR TAG DETAIL CALLOUT X KEYNOTE TAG × ELEVATION (x) ASSEMBLY TAG SECTION SHEET X REVISION TAG SHEET NUMBER X LIGHT TAG REFERENCE NOTES


Date 2024-04-1
Scale As indicated
Drawn AV


OVERALL FIRST FLOOR PLAN

REVISION SCHEDULE

NO. DESCRIPTION DATE

SHEET NO. **A3.1**

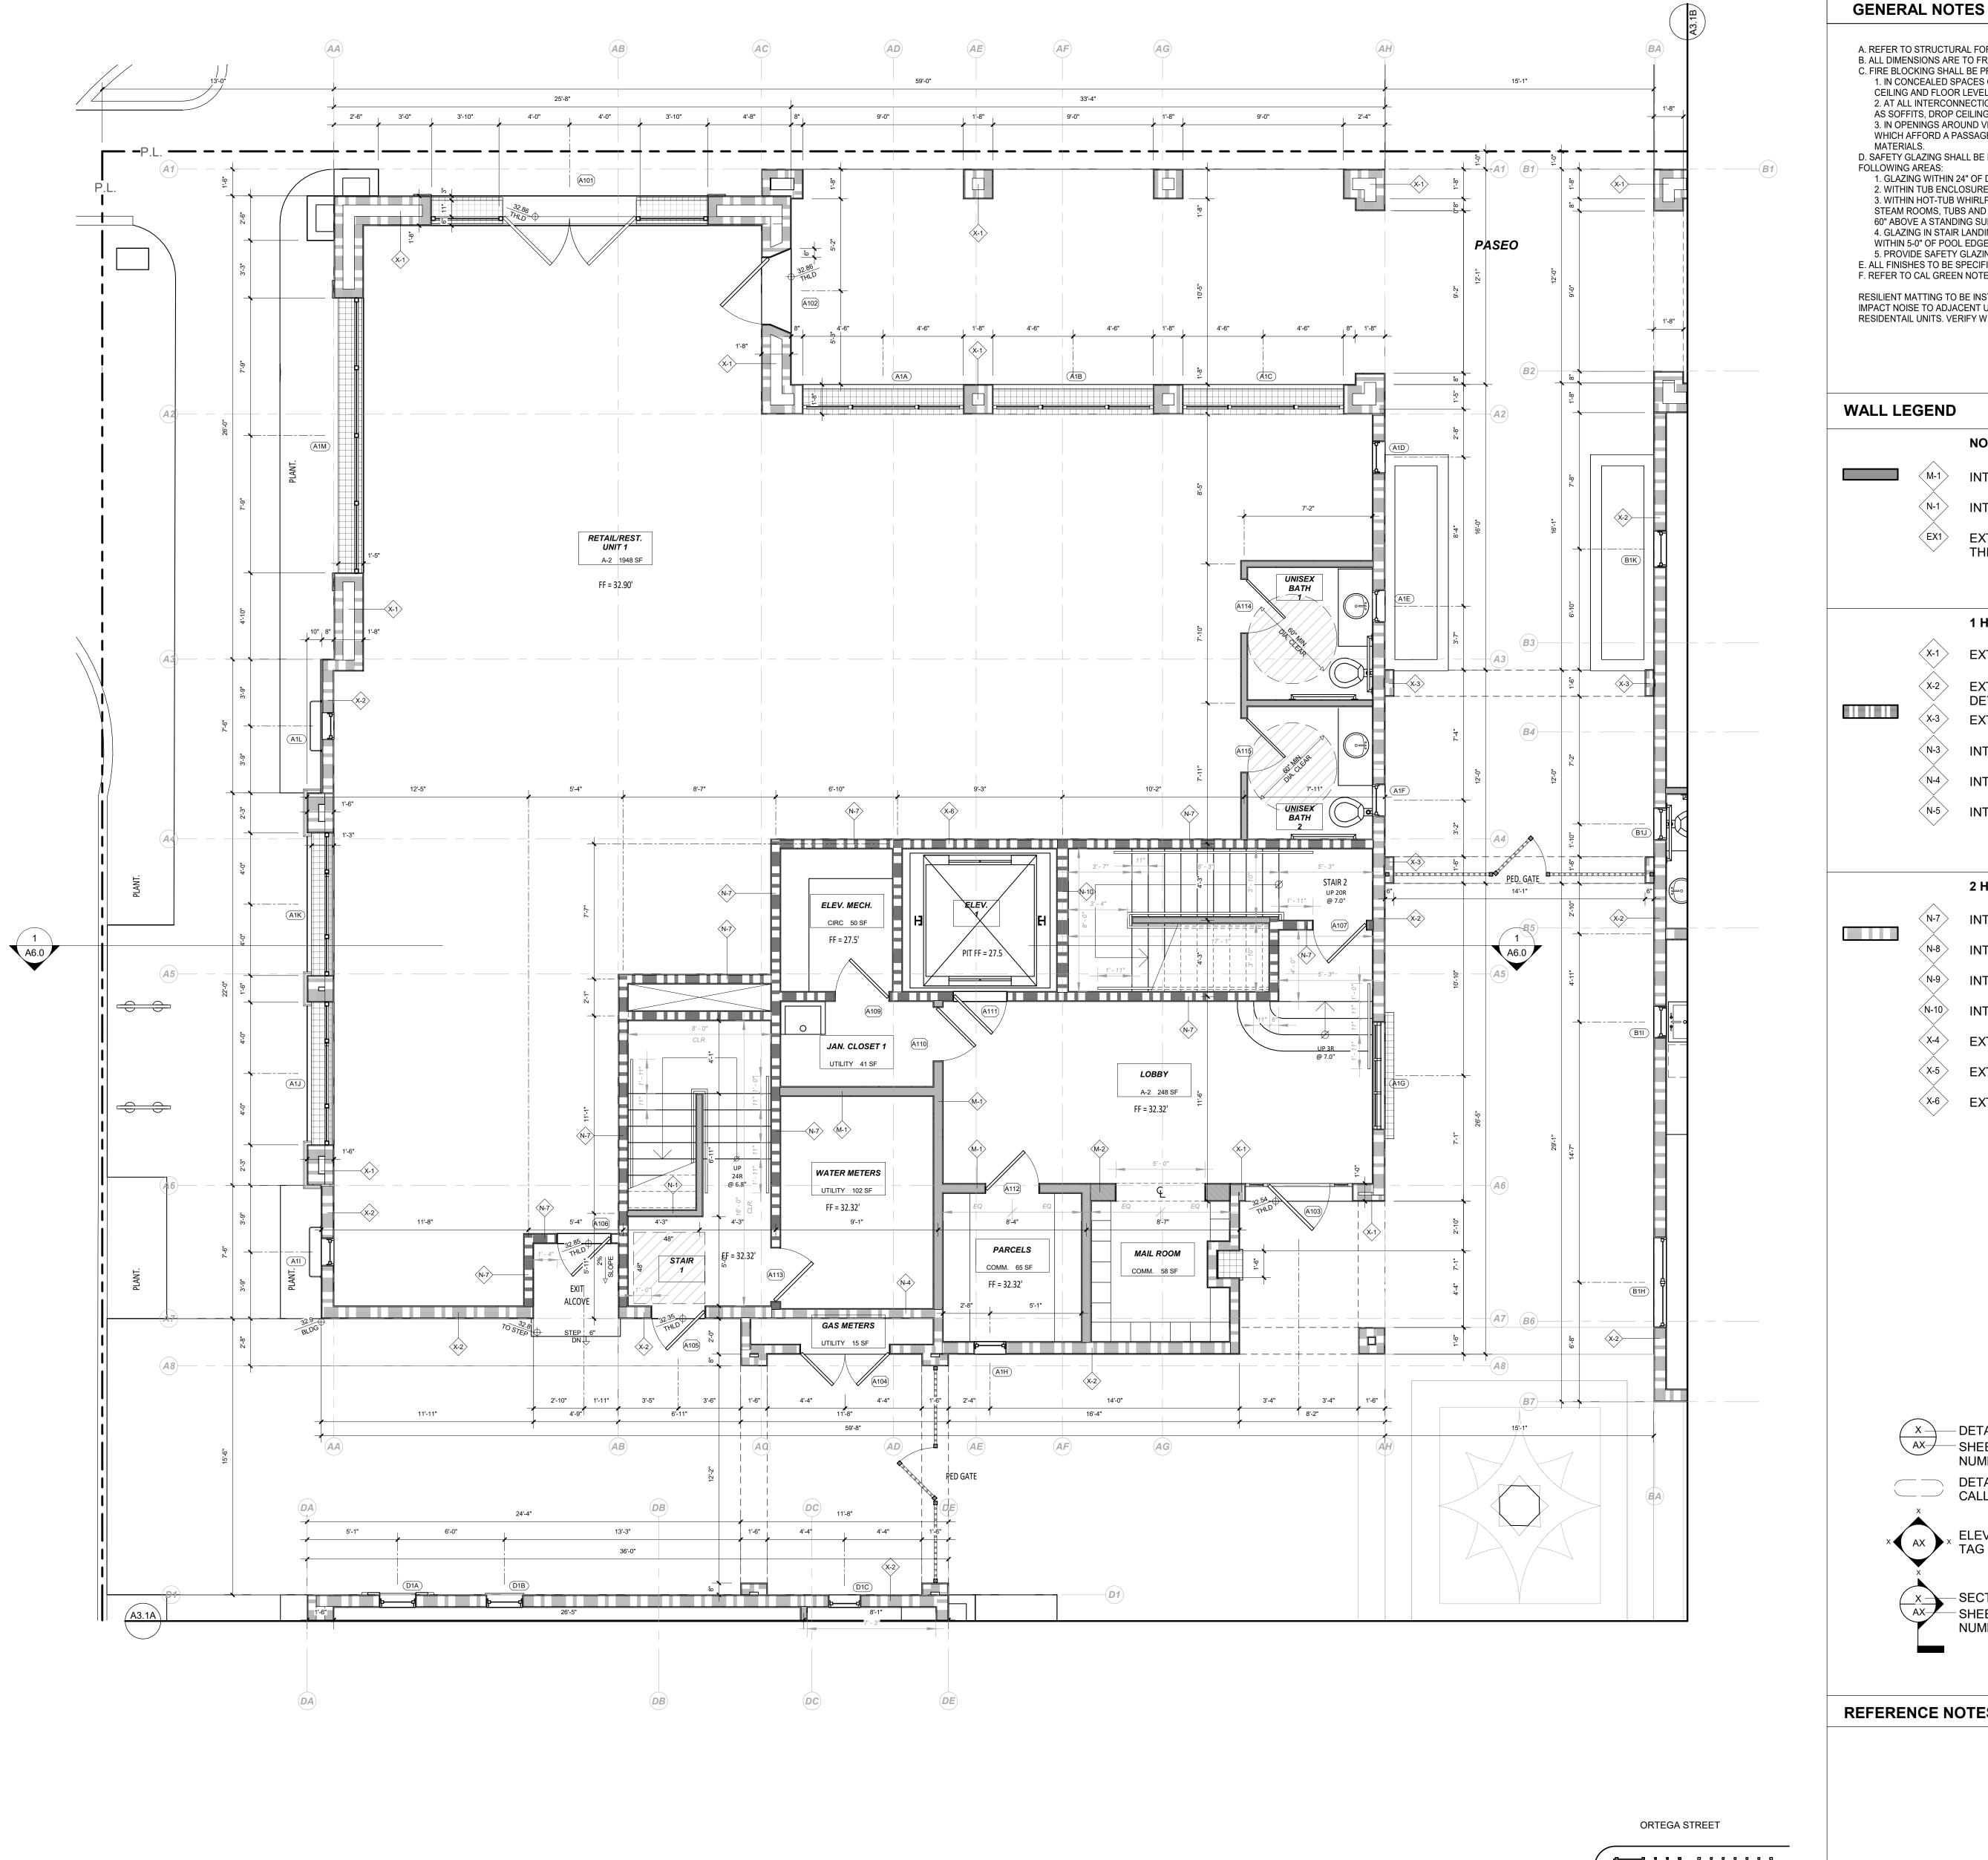

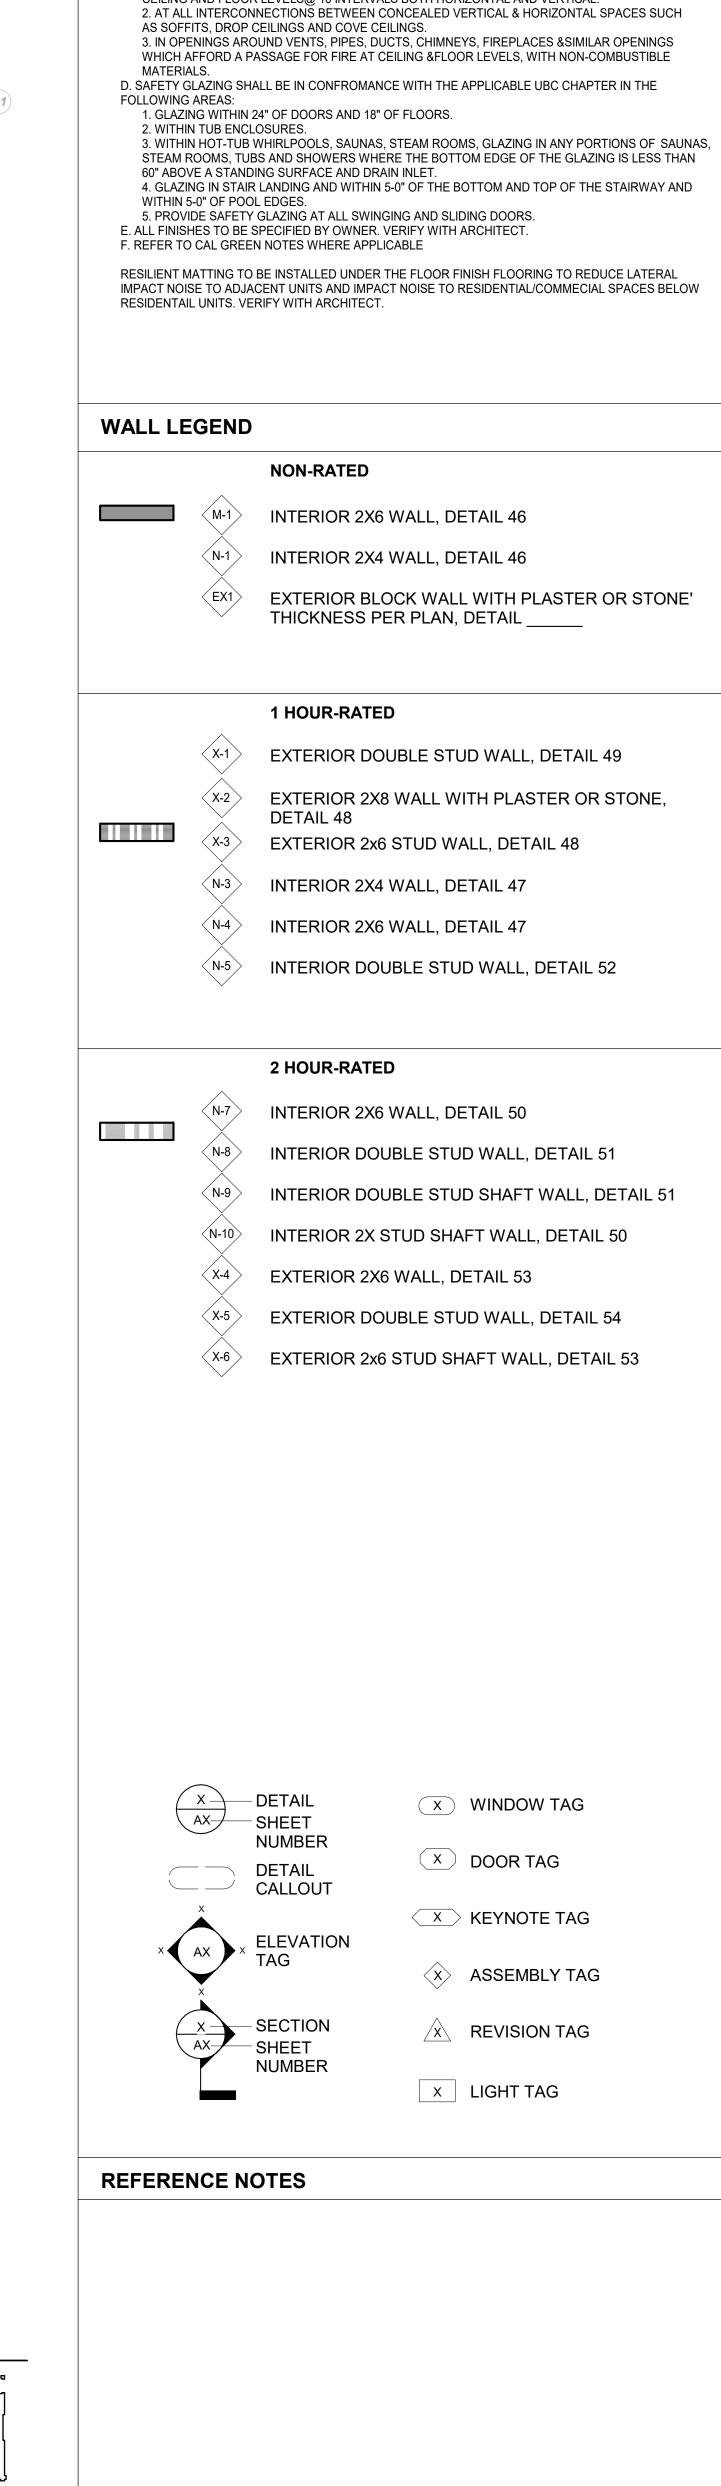

C. FIRE BLOCKING SHALL BE PROVIDED:

REVISION SCHEDULE NO. DESCRIPTION DATE A. REFER TO STRUCTURAL FOR WALL FRAMING INFORMATION, U.N.O. B. ALL DIMENSIONS ARE TO FRAMING, NOT FINISH WALL. EXCEPT AS NOTED PER LEGEND. 1. IN CONCEALED SPACES OF STUD WALLS AND PARTITIONS, INCLUDING FURRED SPACES, AT THE CEILING AND FLOOR LEVELS@ 10 INTERVALS BOTH HORIZONTAL AND VERTICAL. EXTERIOR BLOCK WALL WITH PLASTER OR STONE' EXTERIOR DOUBLE STUD WALL, DETAIL 49 EXTERIOR 2X8 WALL WITH PLASTER OR STONE, INTERIOR DOUBLE STUD WALL, DETAIL 52 INTERIOR DOUBLE STUD WALL, DETAIL 51 INTERIOR DOUBLE STUD SHAFT WALL, DETAIL 51 INTERIOR 2X STUD SHAFT WALL, DETAIL 50 EXTERIOR DOUBLE STUD WALL, DETAIL 54 EXTERIOR 2x6 STUD SHAFT WALL, DETAIL 53

X WINDOW TAG

X DOOR TAG


X KEYNOTE TAG

X ASSEMBLY TAG


REVISION TAG


X LIGHT TAG

LEVEL 1, BLDG. A

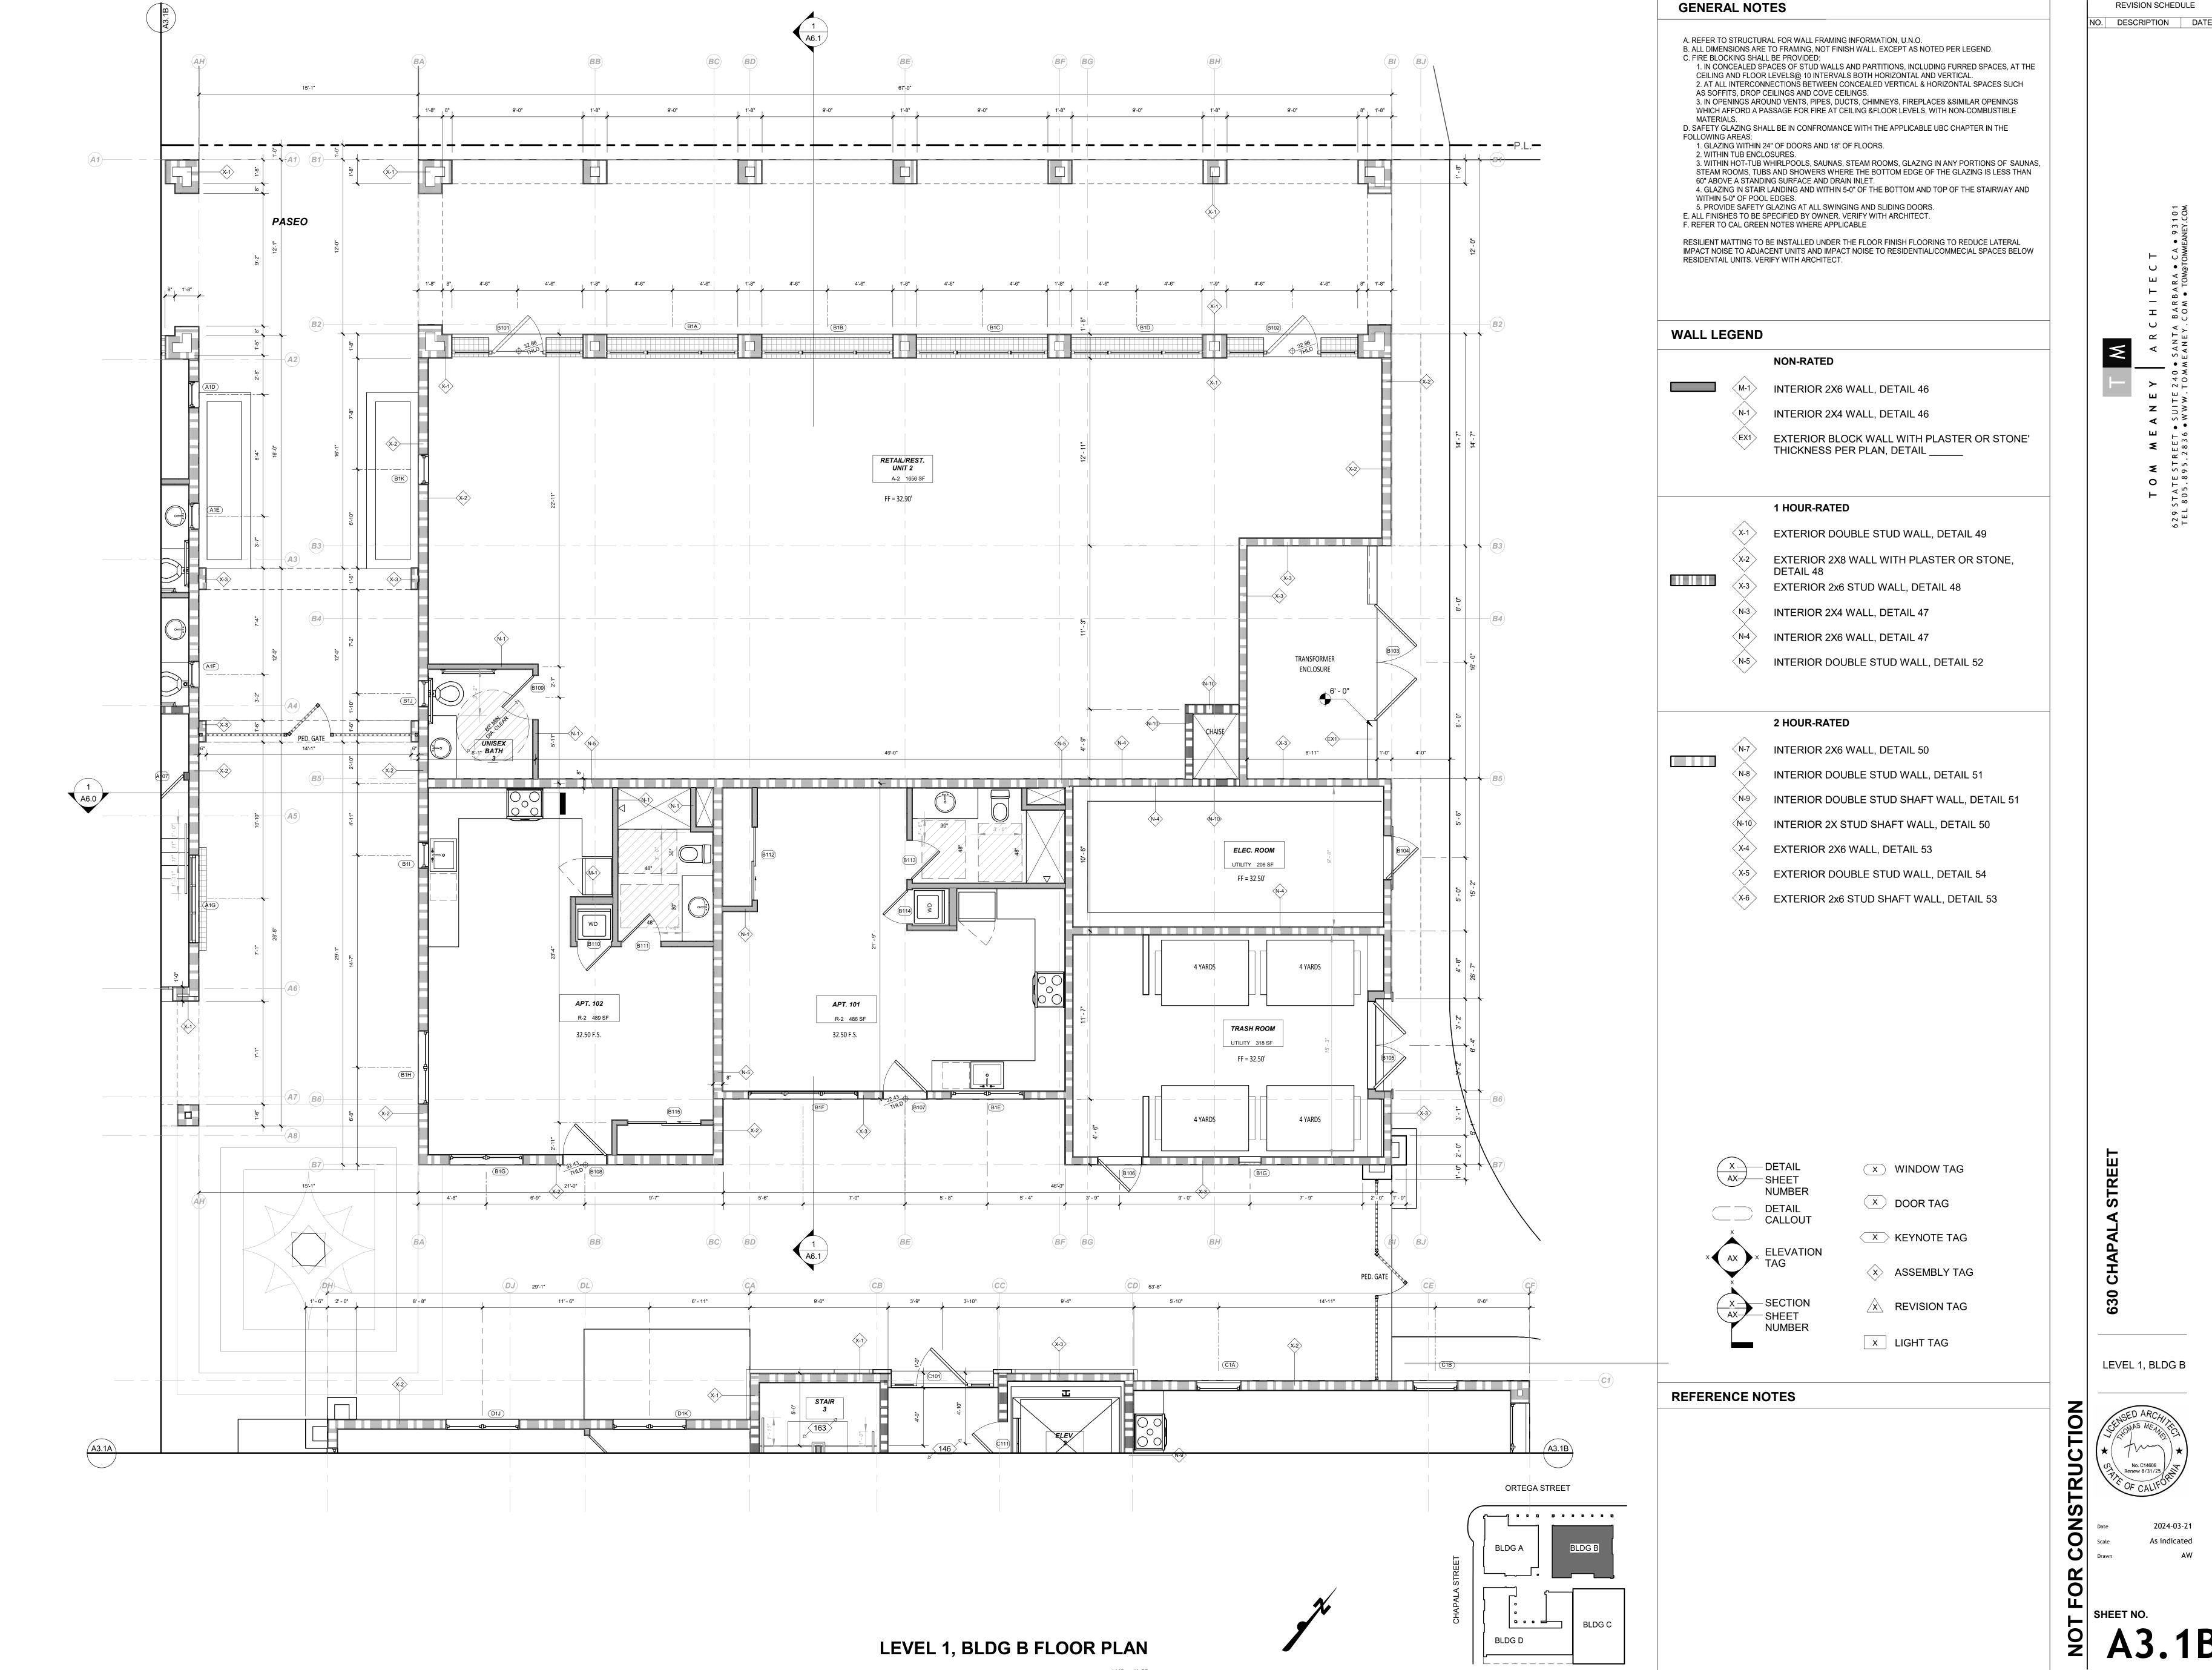



REVISION SCHEDULE NO. DESCRIPTION DATE

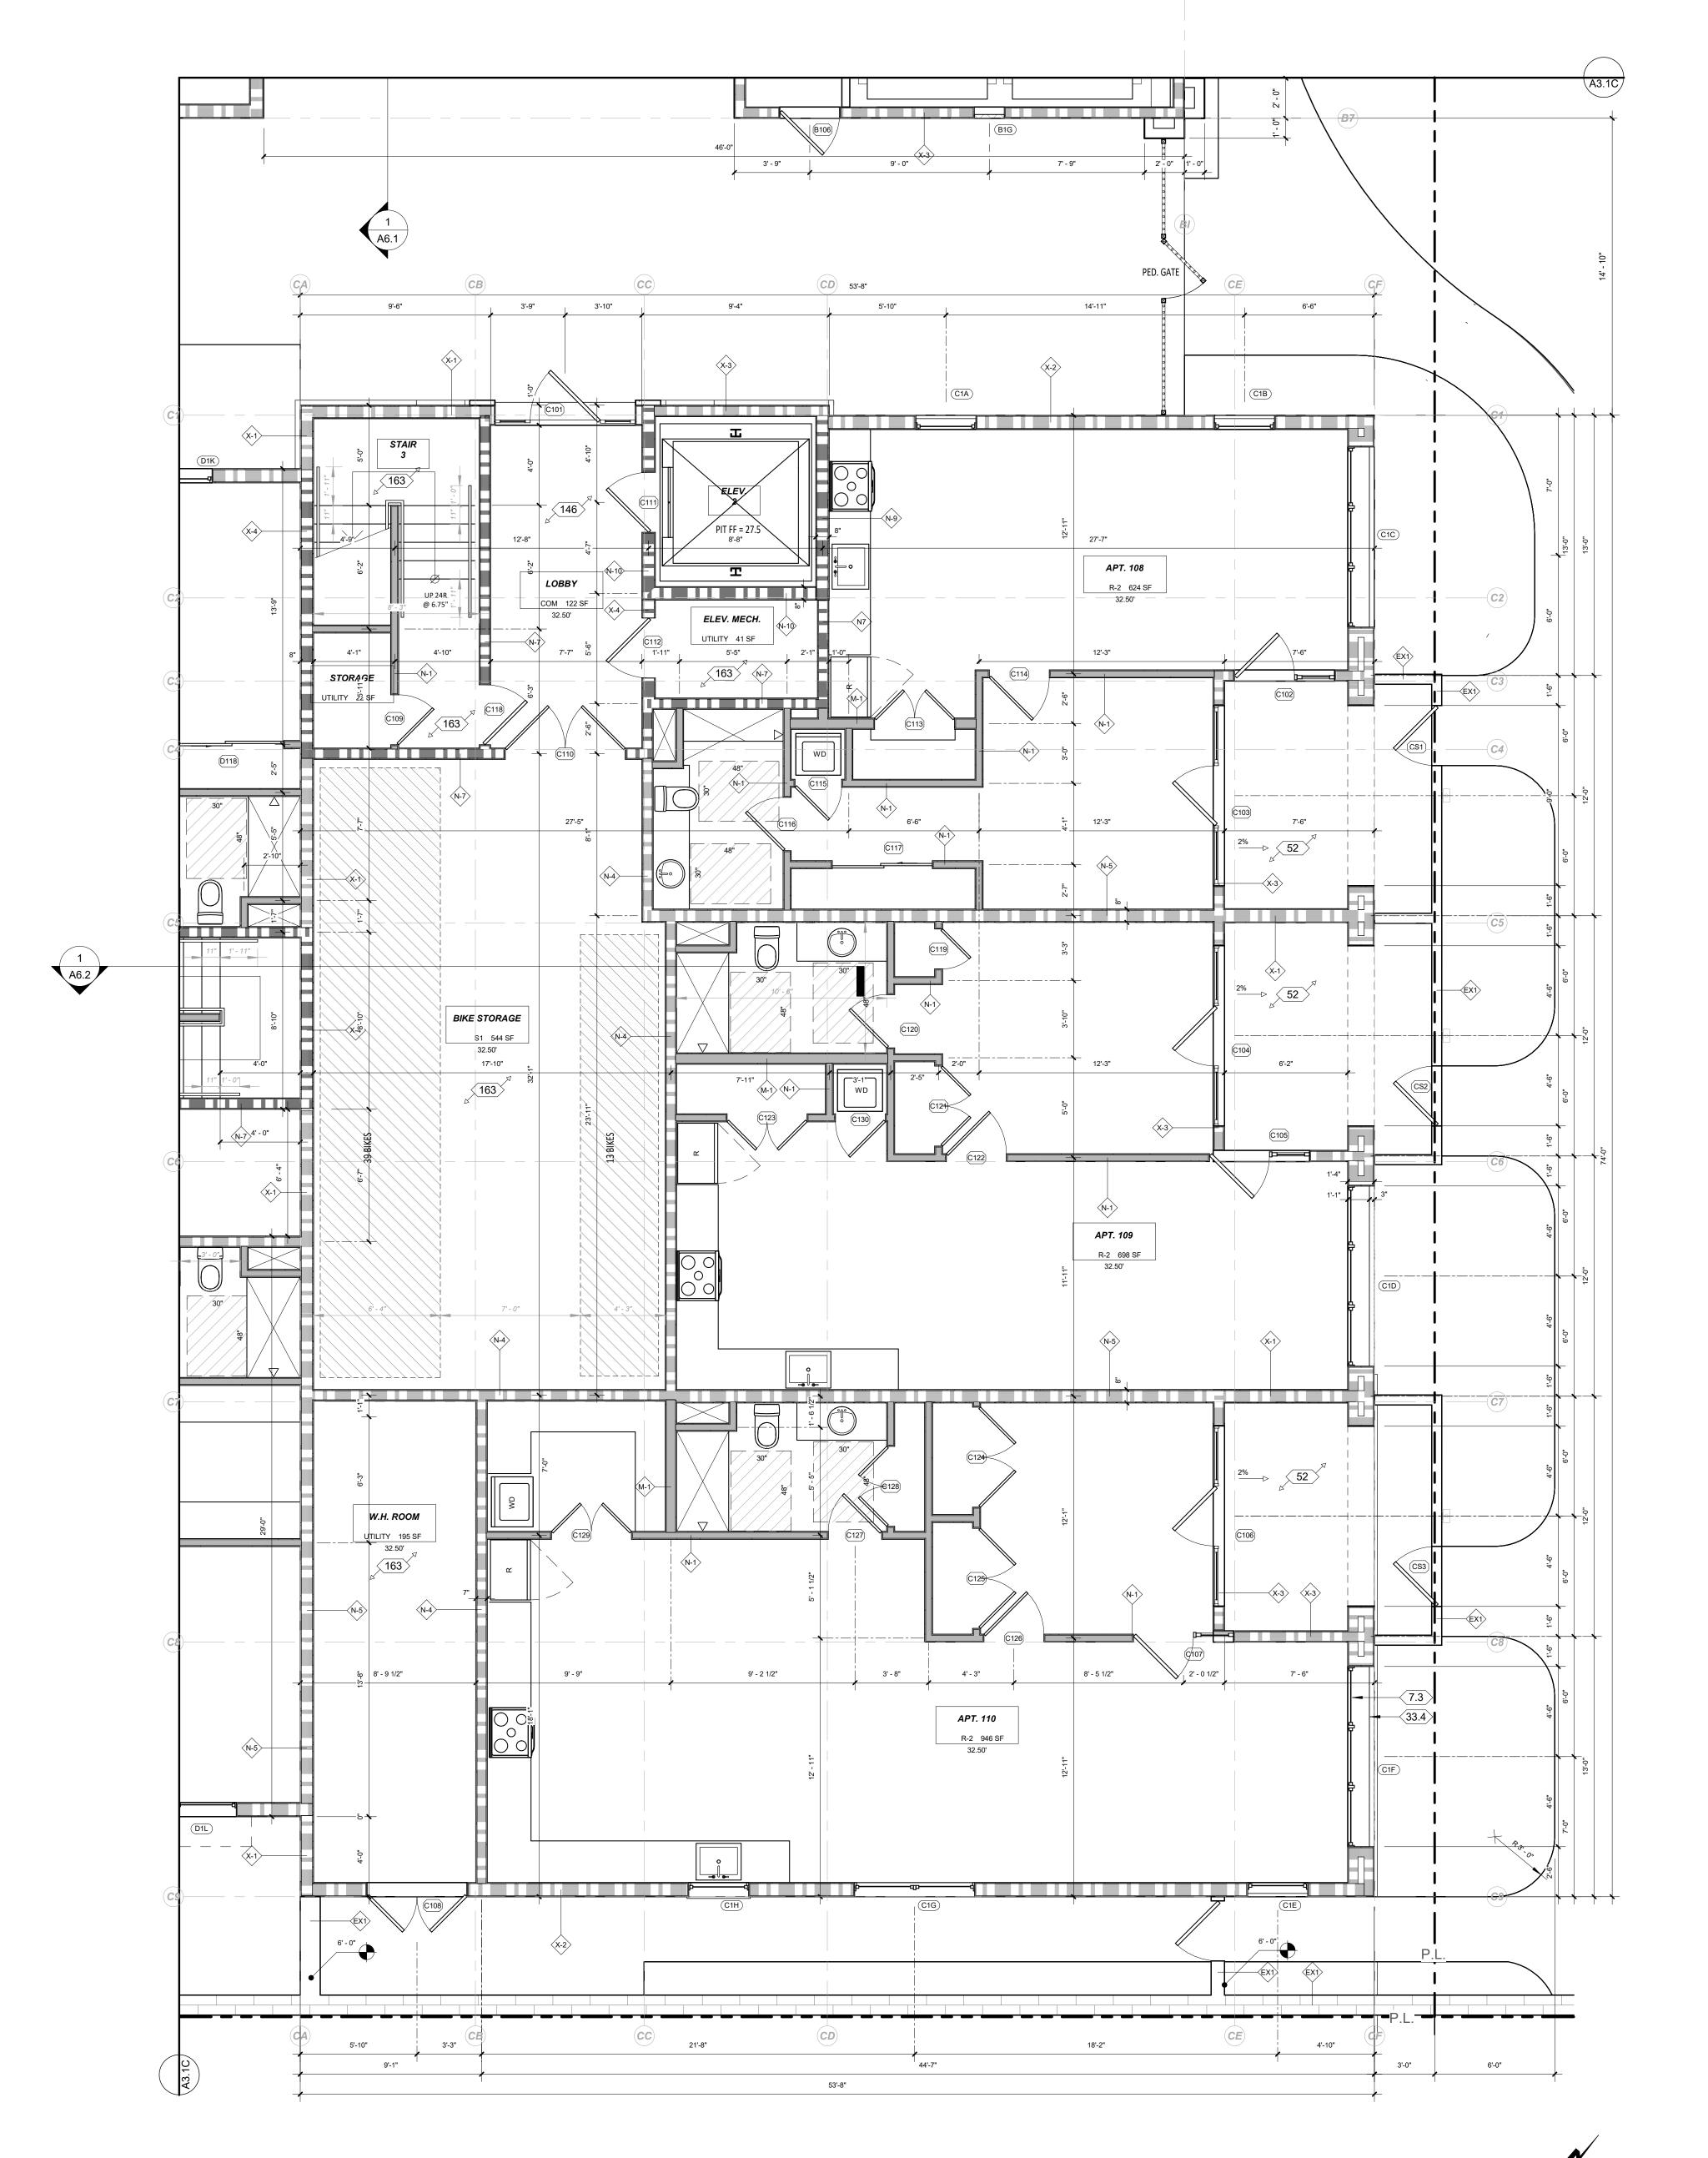


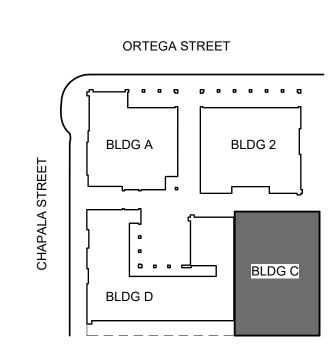


LEVEL 1, BLDG C FLOOR PLAN

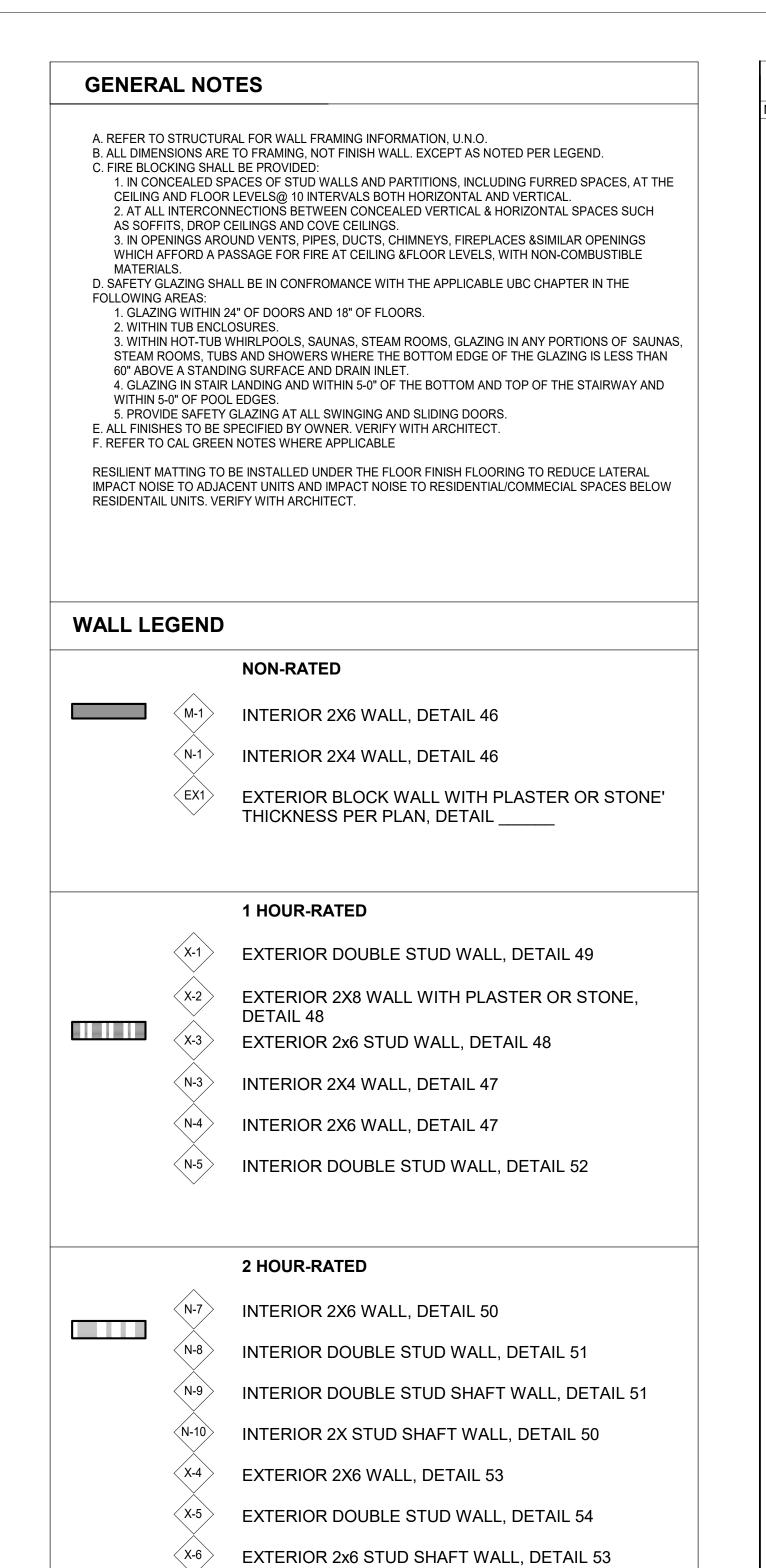

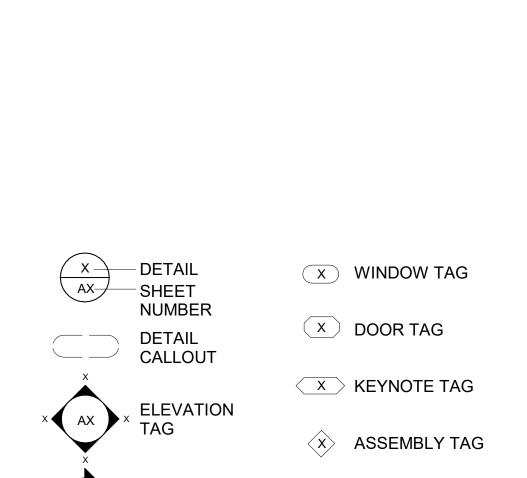

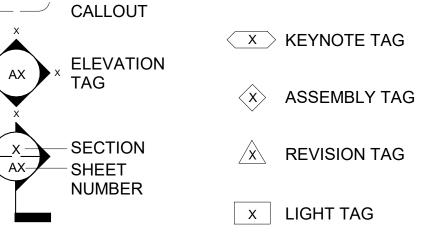




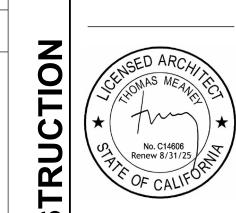


REVISION SCHEDULE


NO. DESCRIPTION DATE

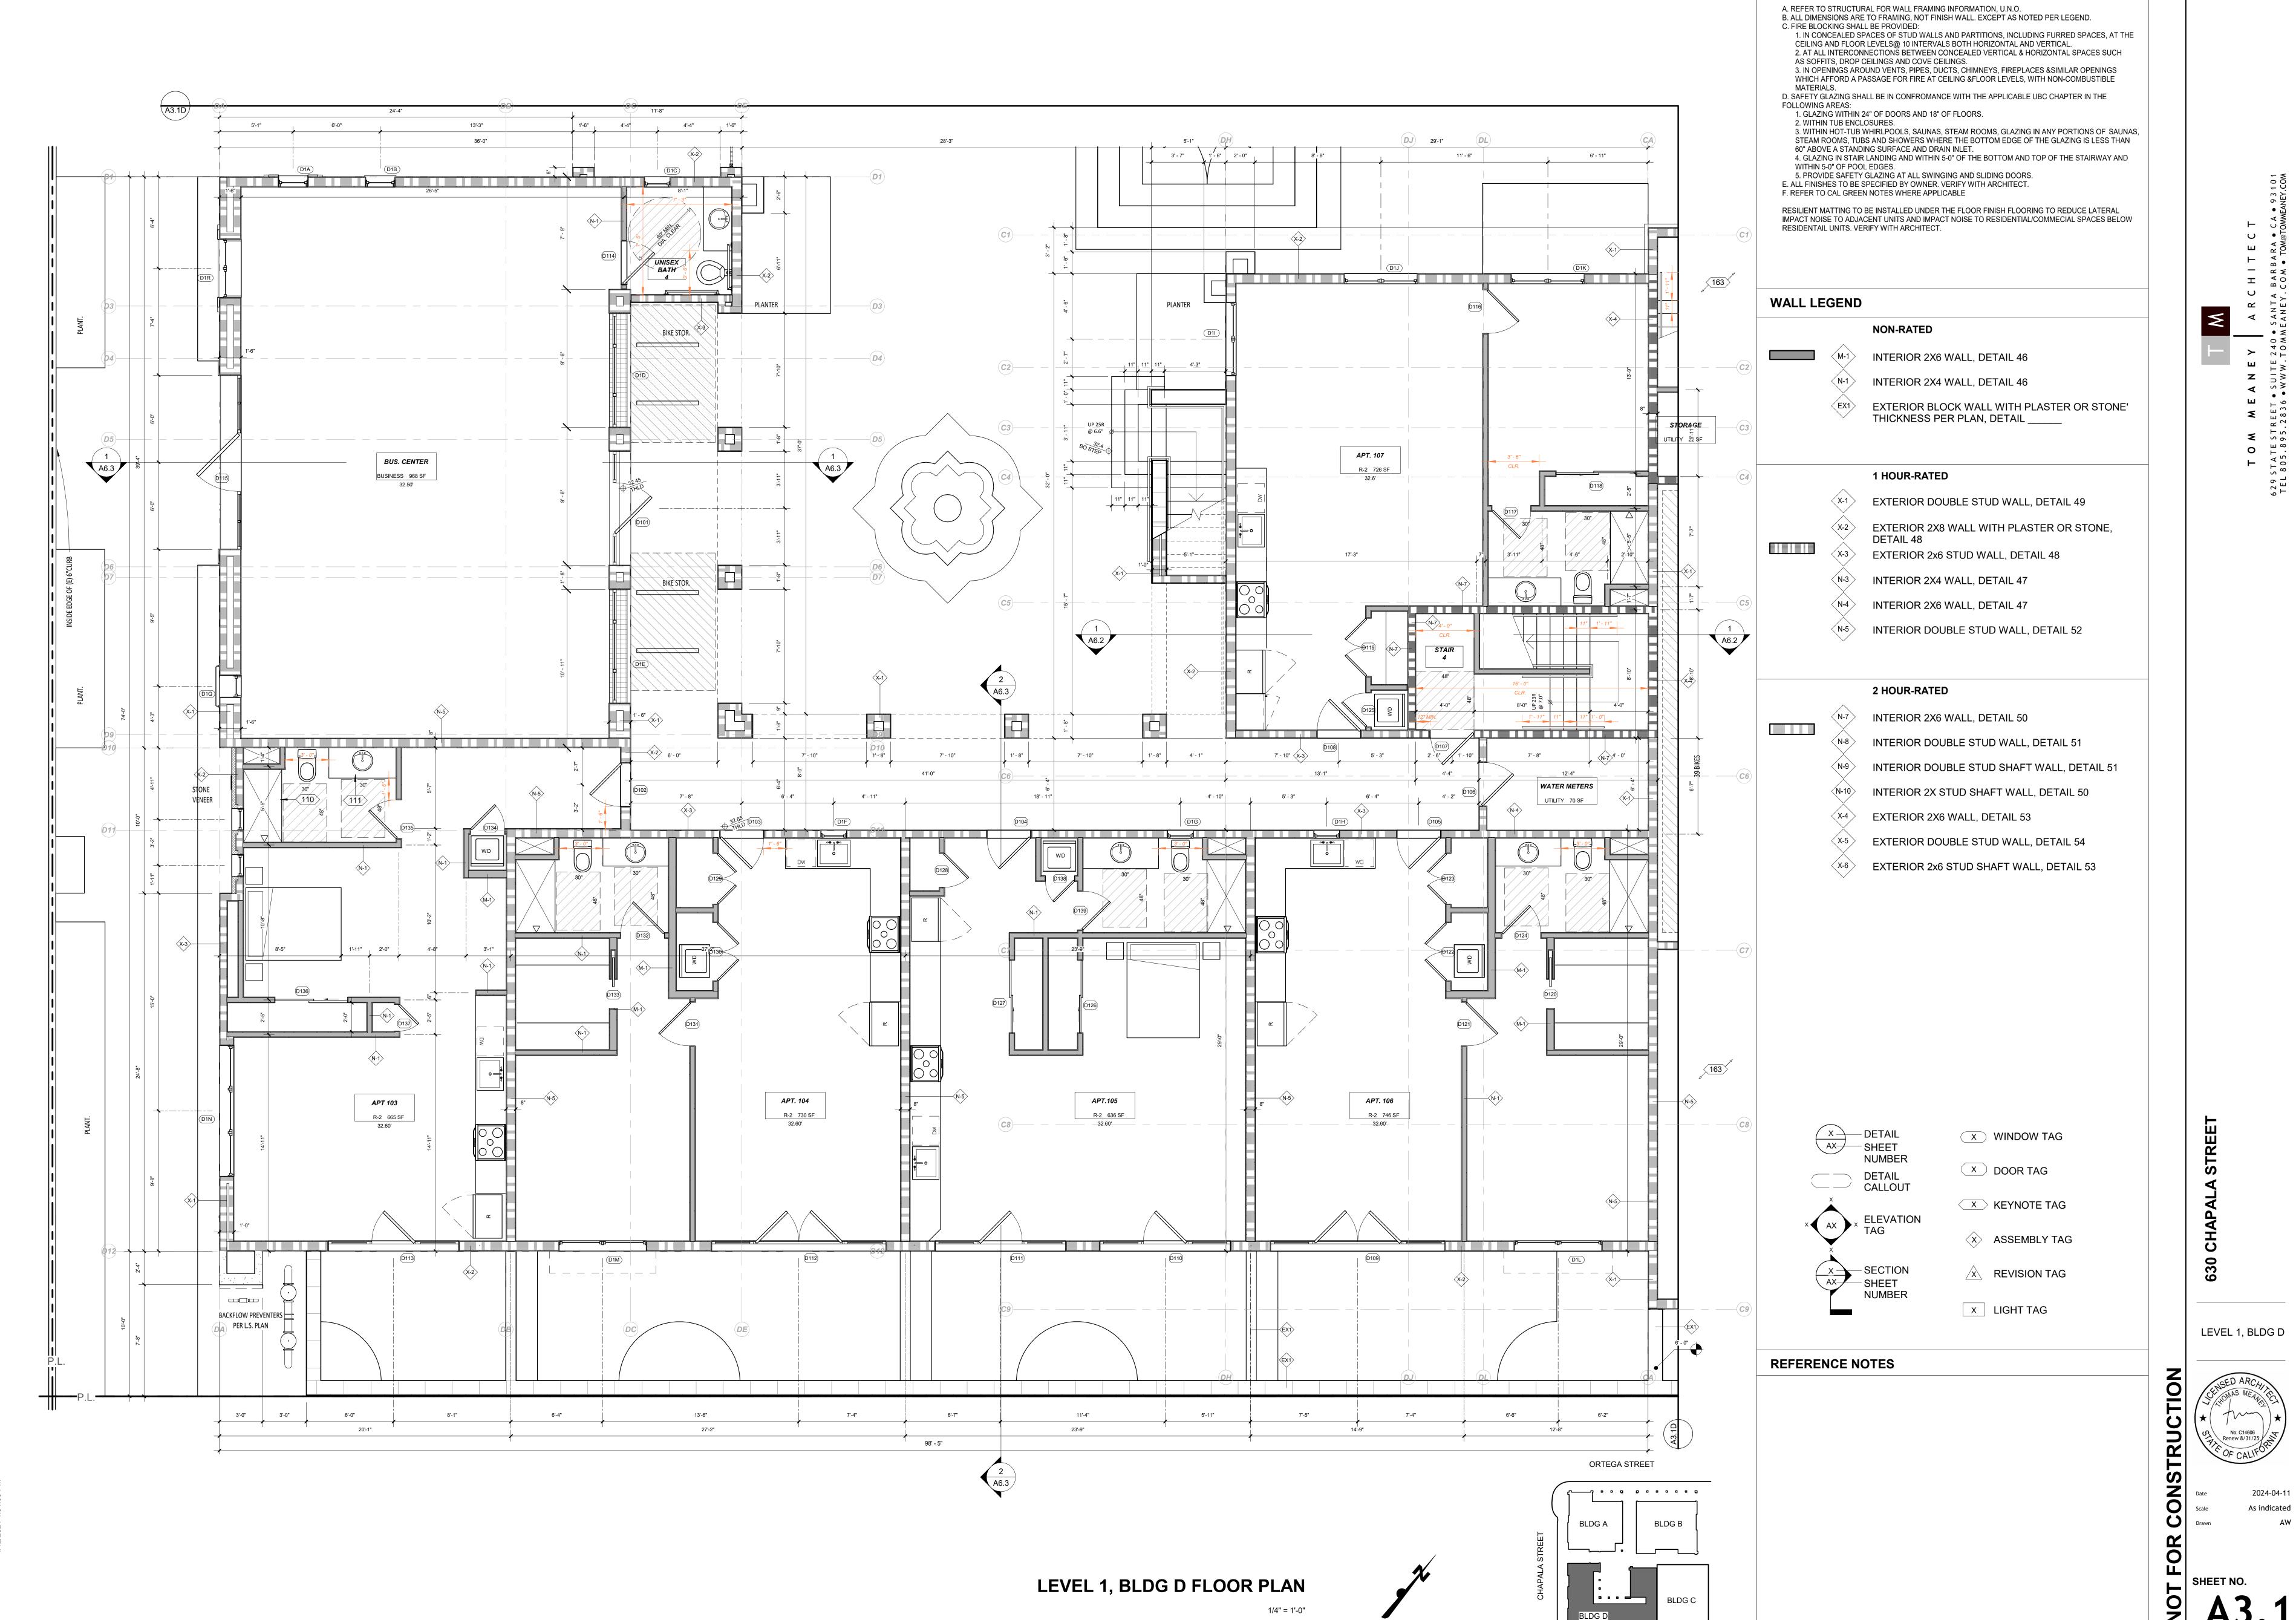

REVISION SCHEDULE NO. DESCRIPTION DATE

GENERAL NOTES

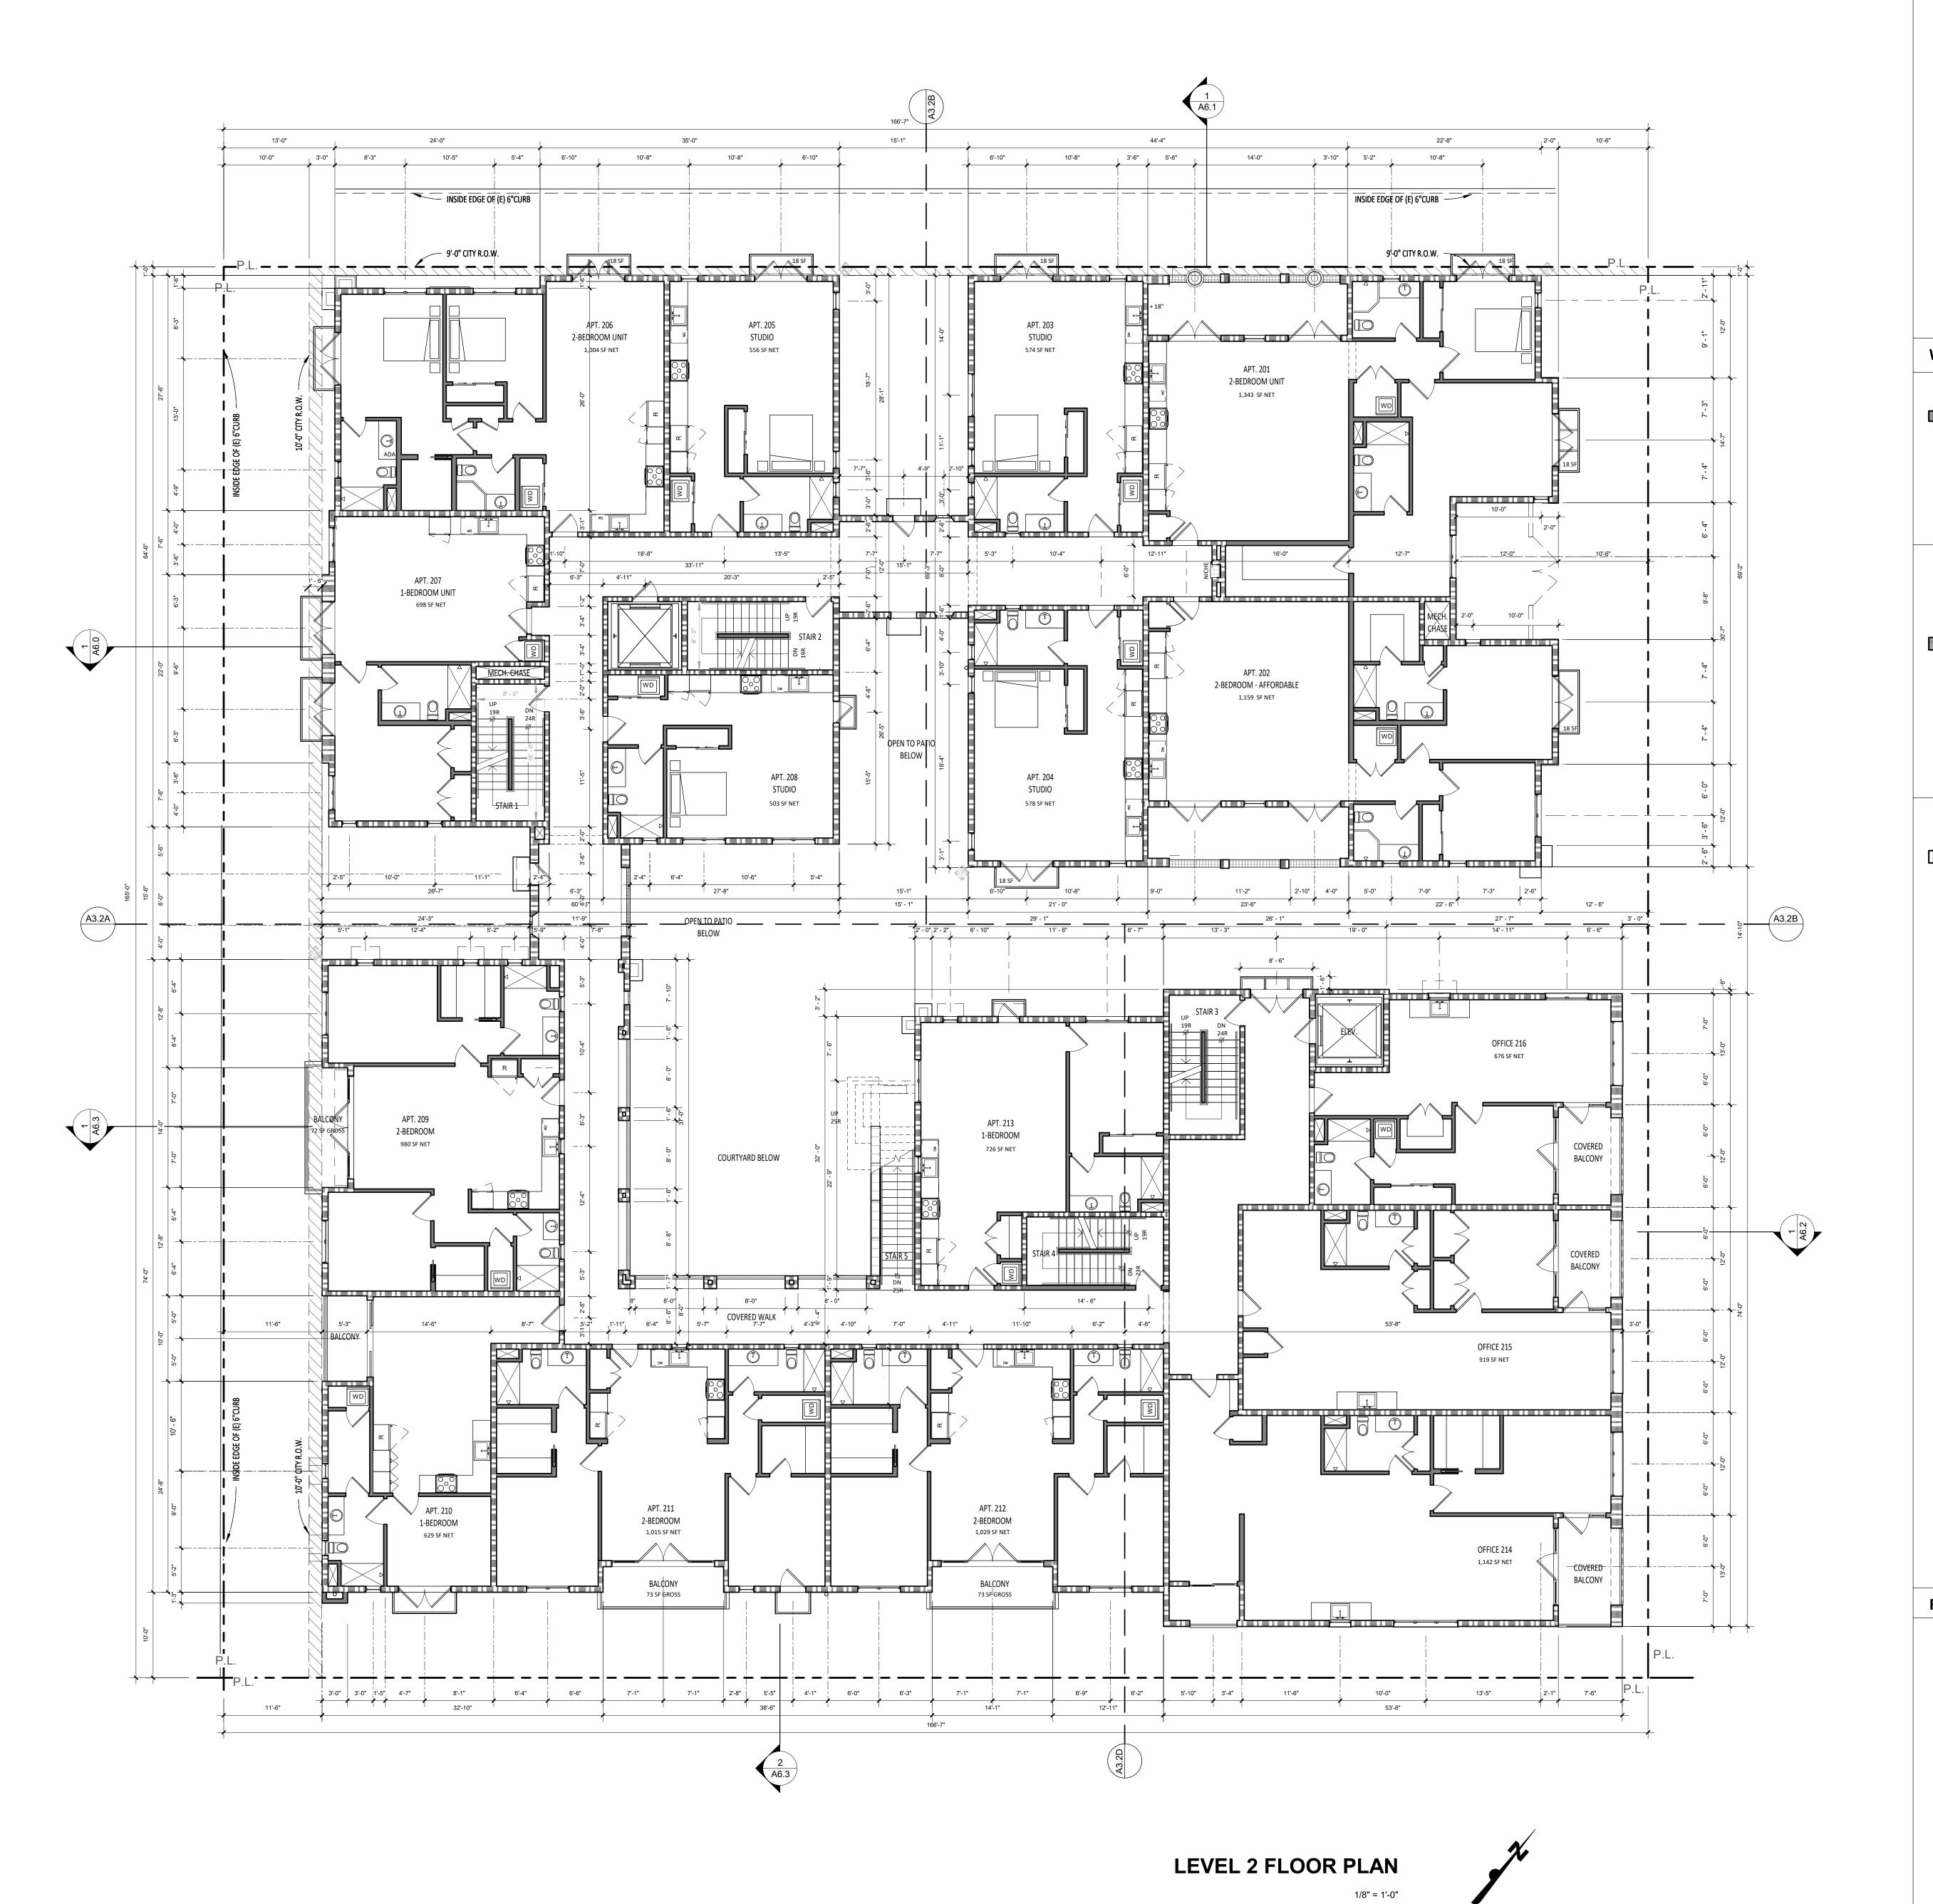


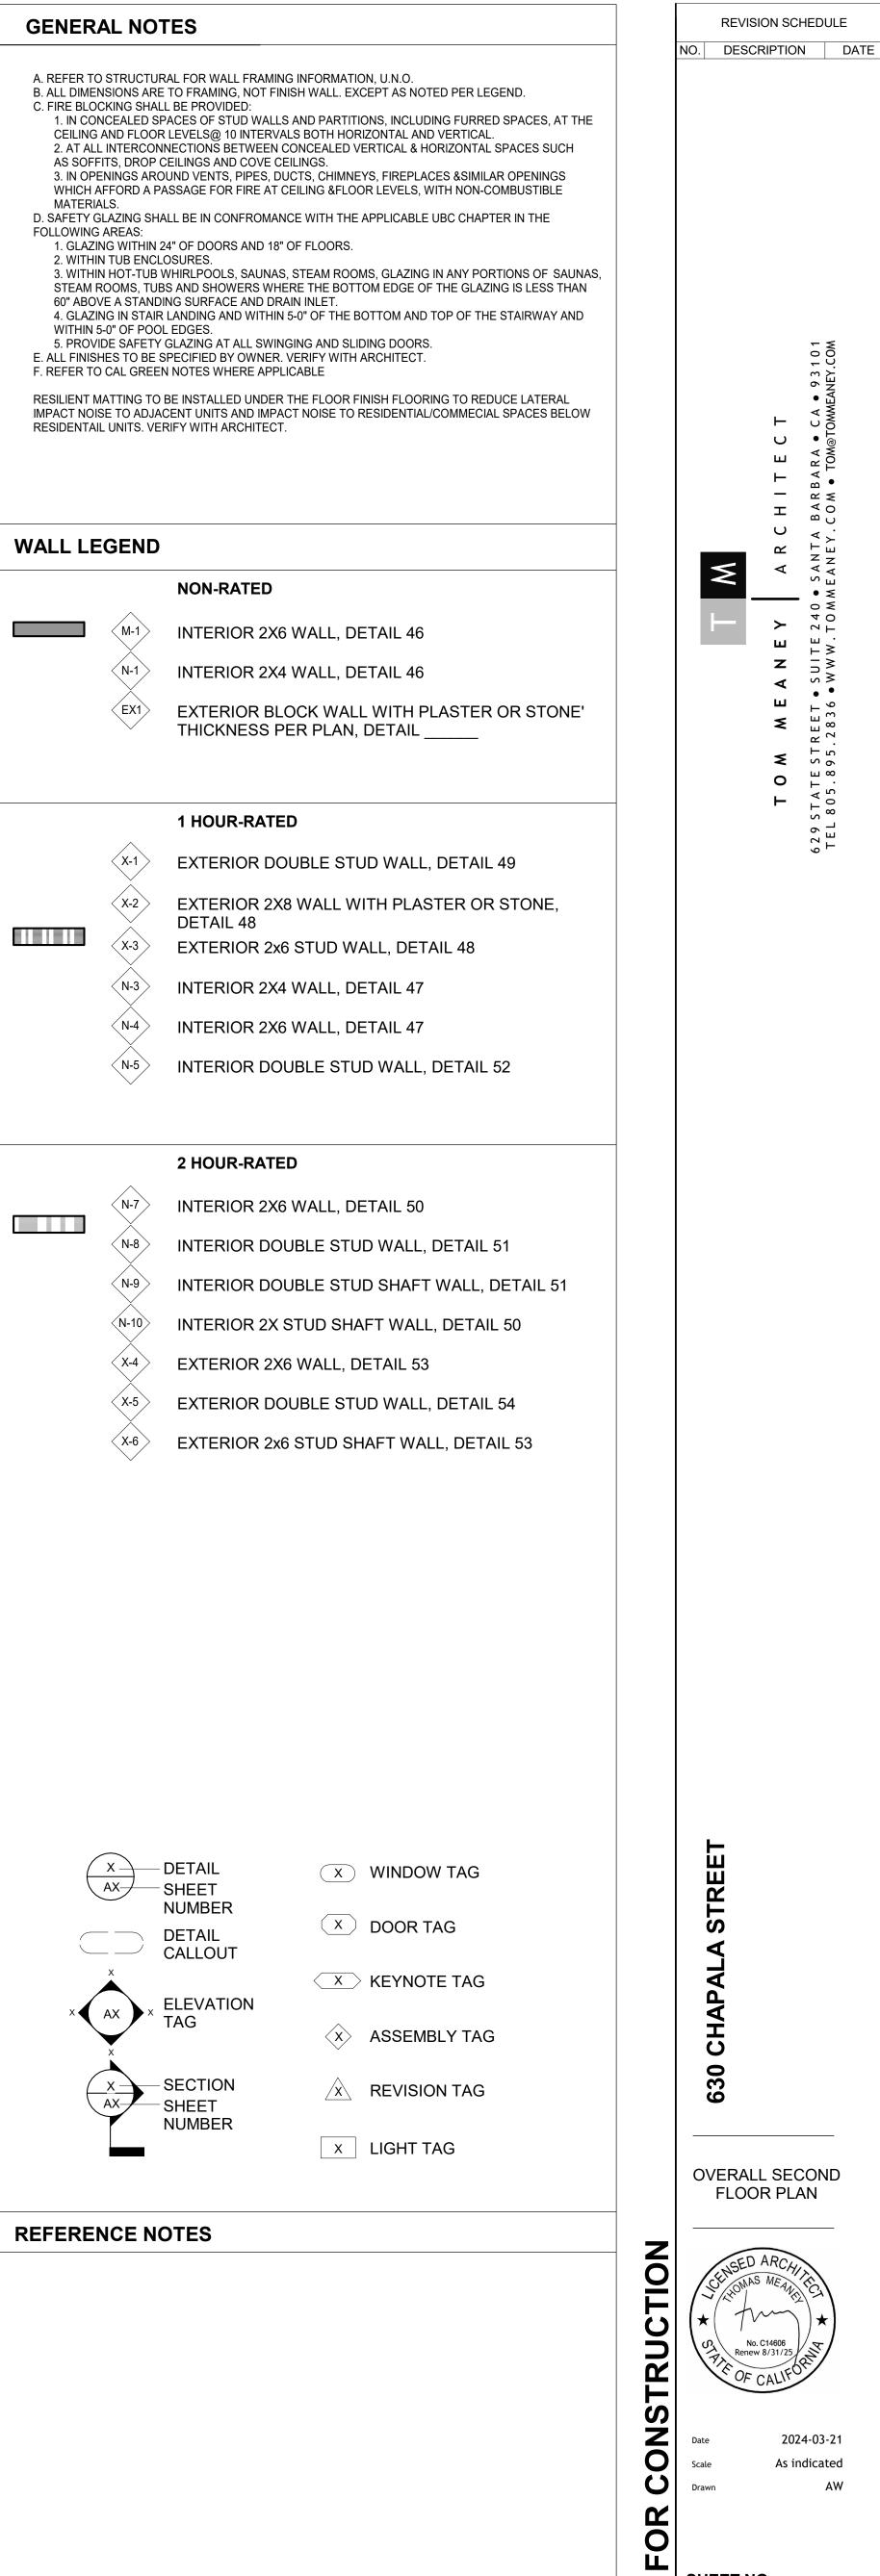

OVERALL SECOND FLOOR PLAN


REVISION SCHEDULE




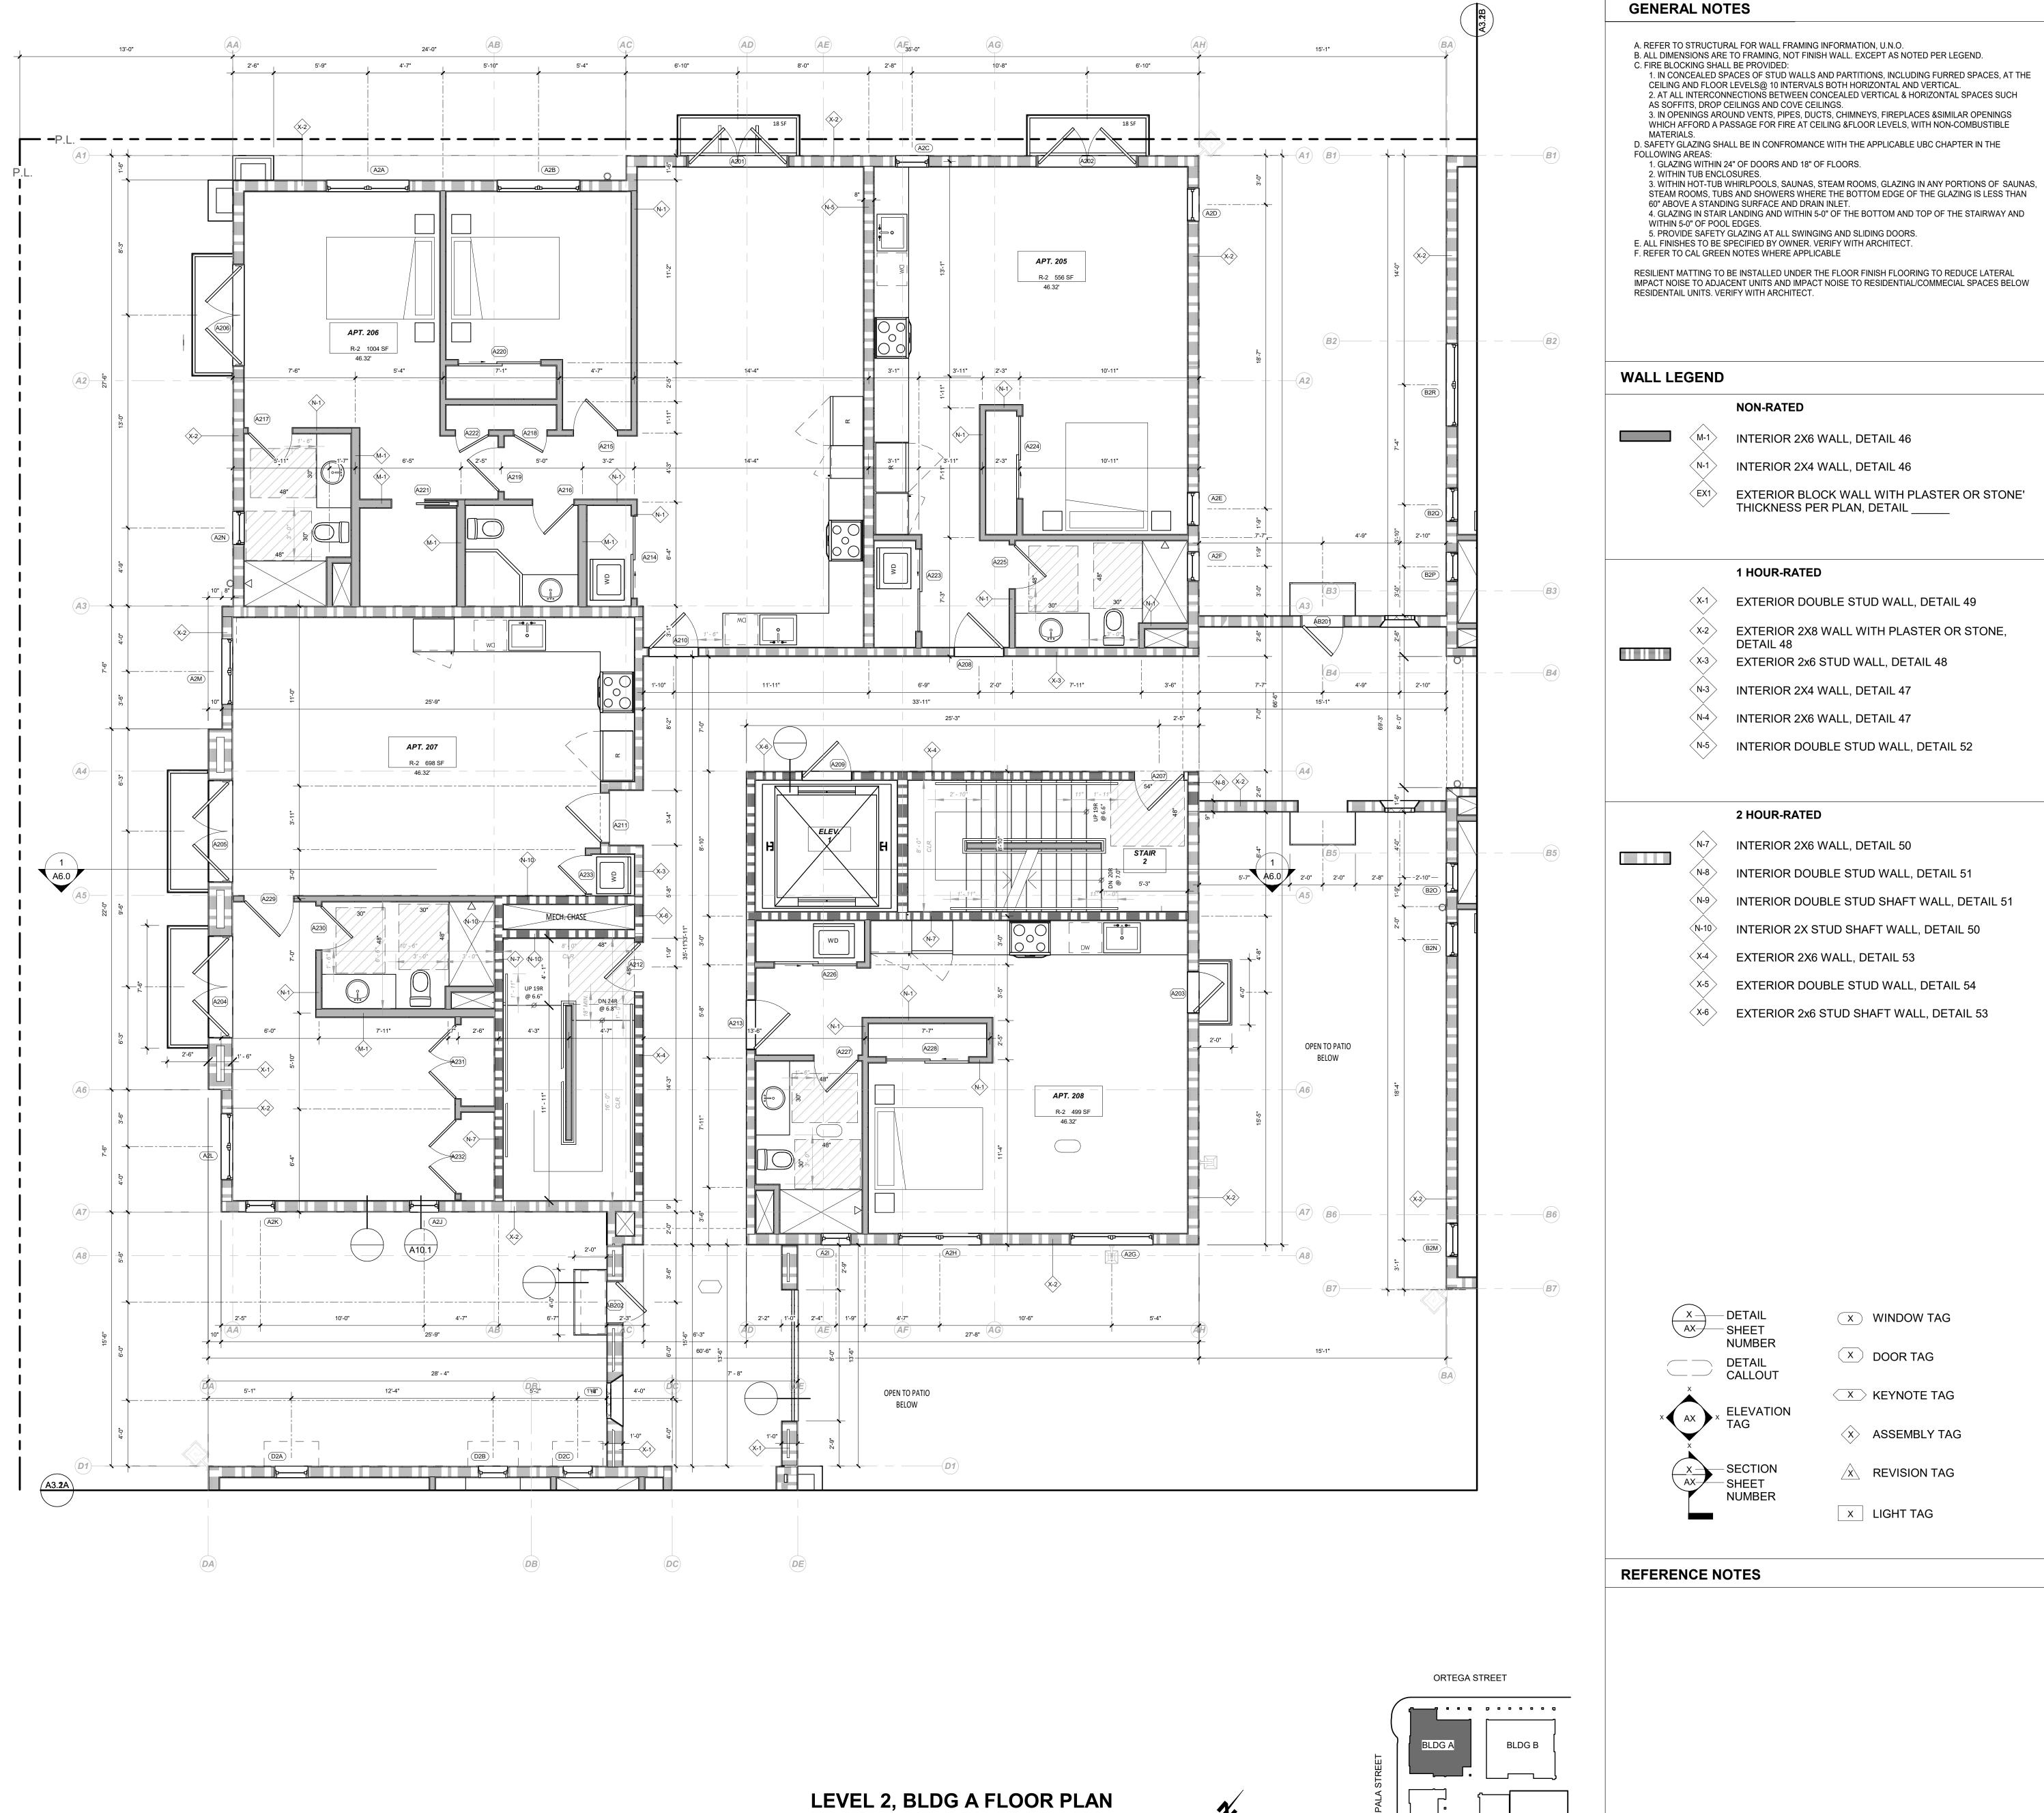

REVISION SCHEDULE NO. DESCRIPTION DATE

LEVEL 2, BLDG A

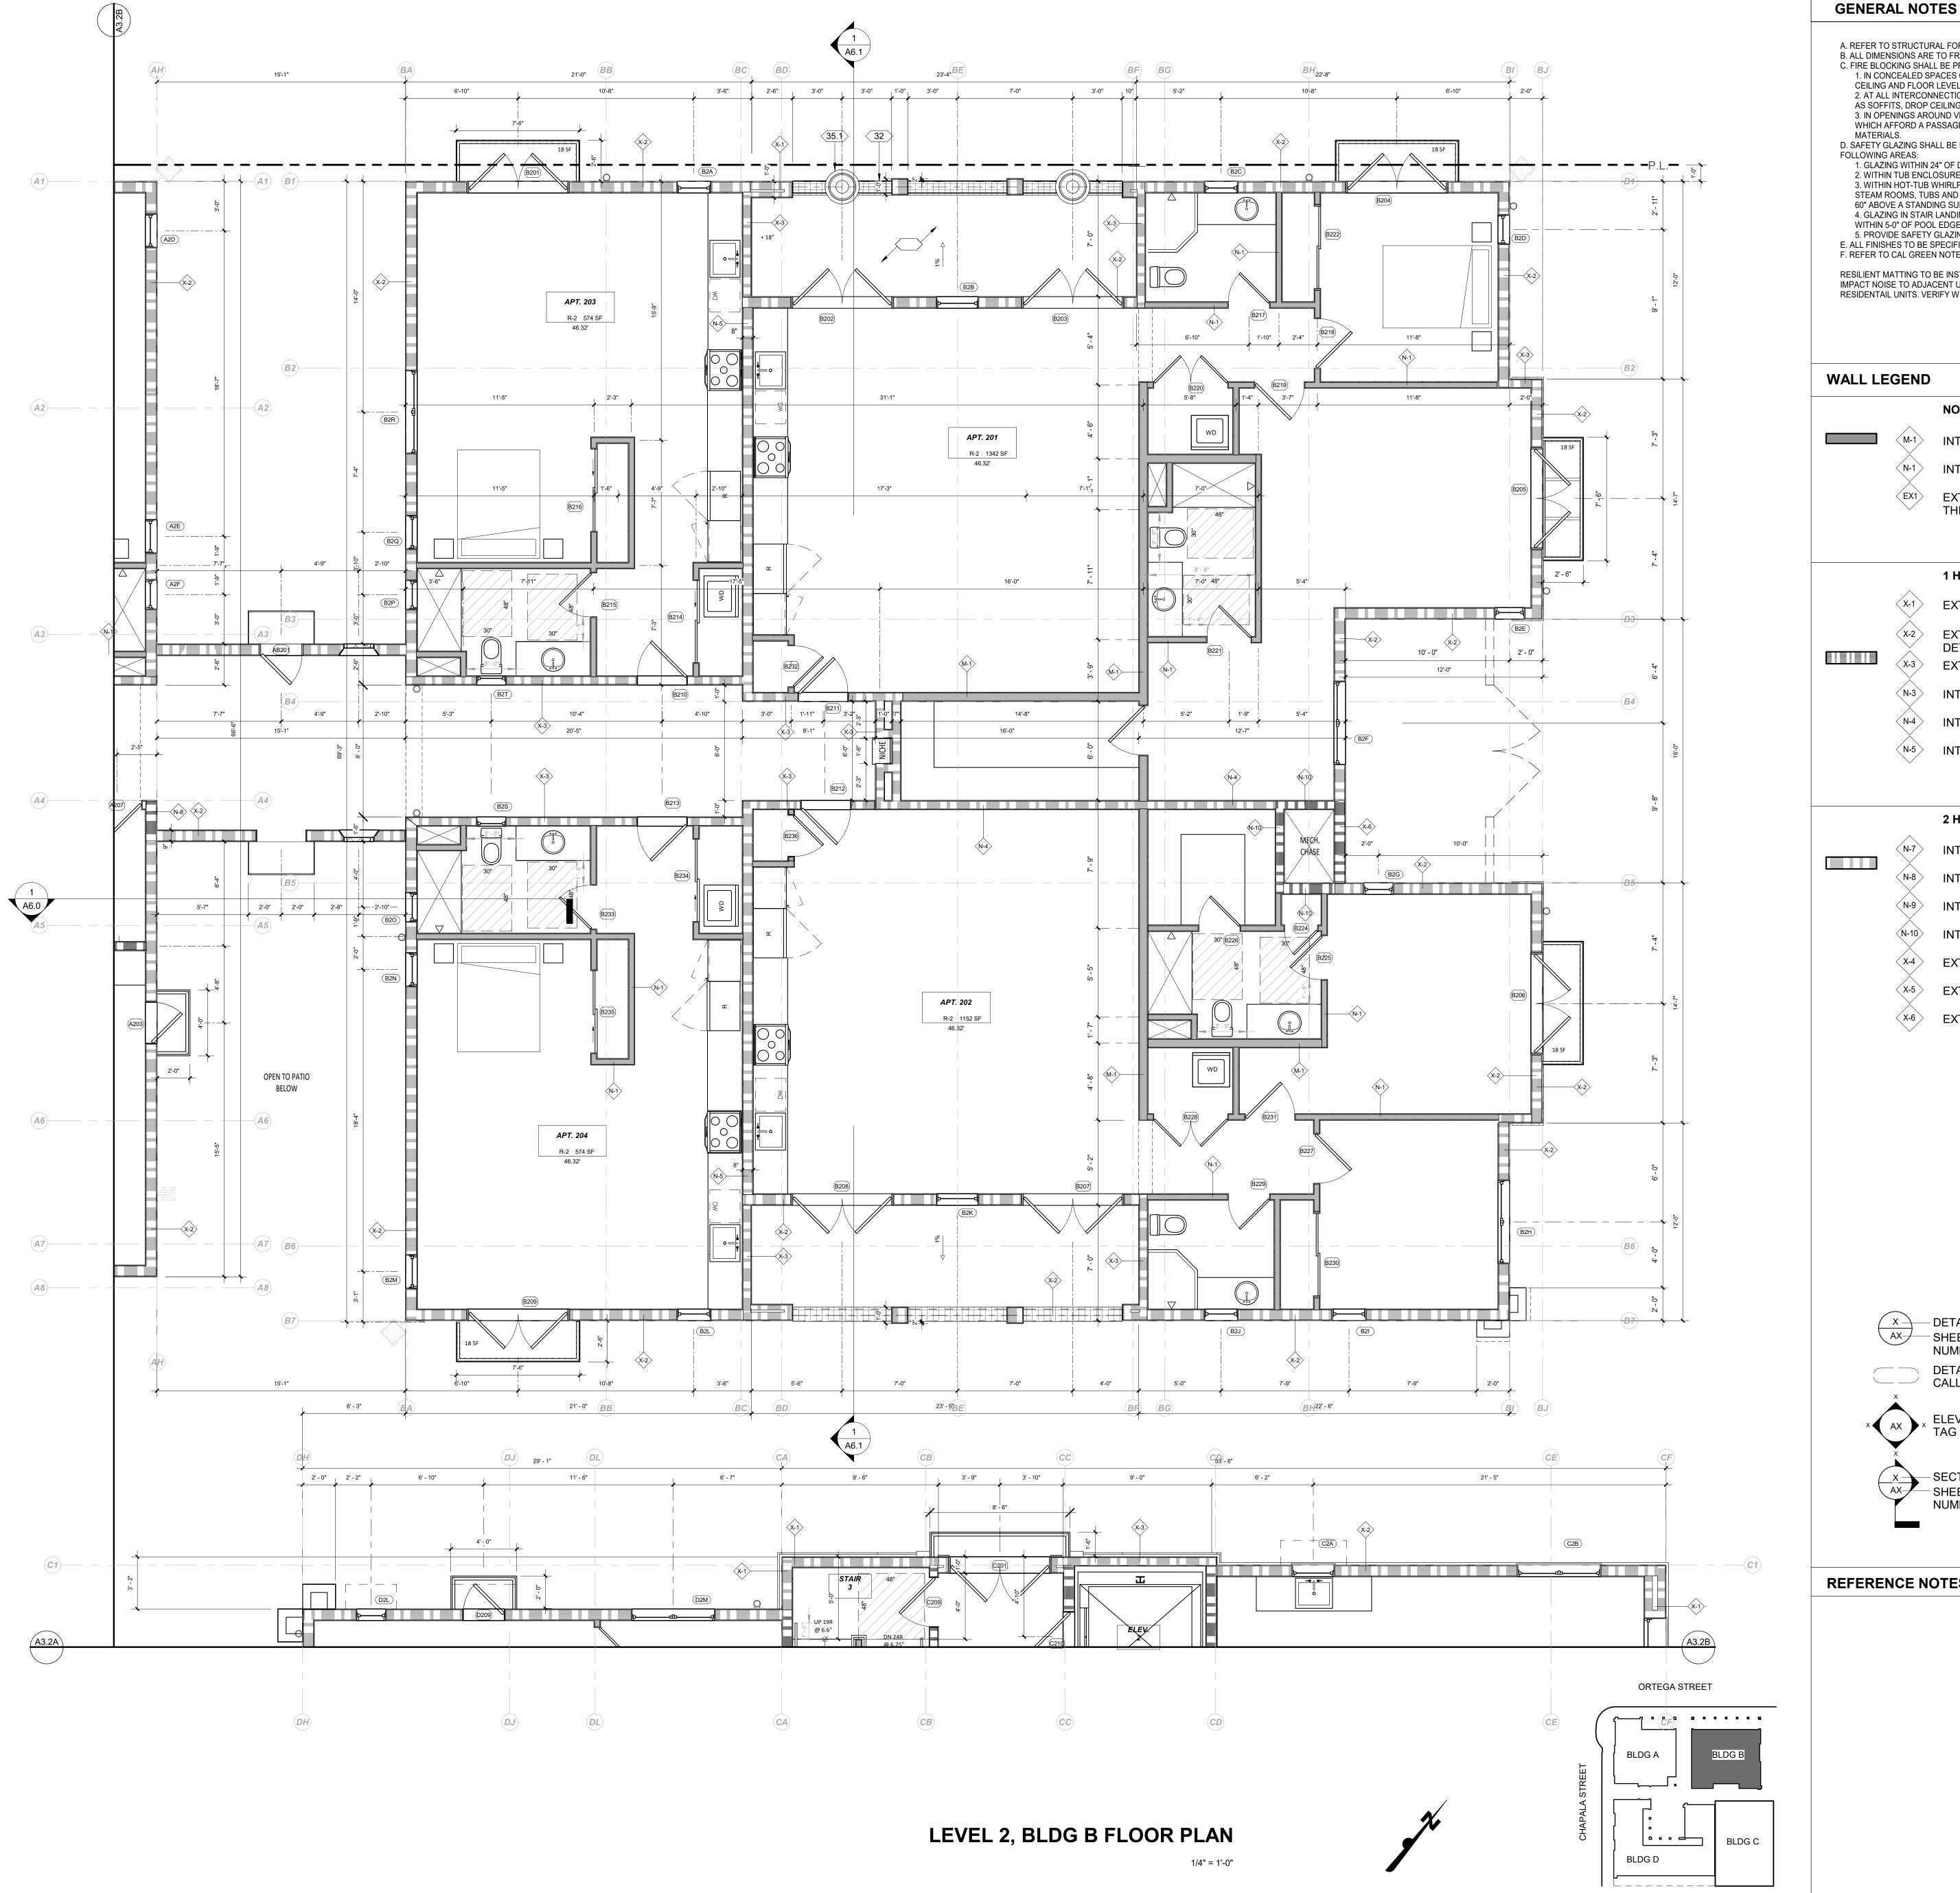


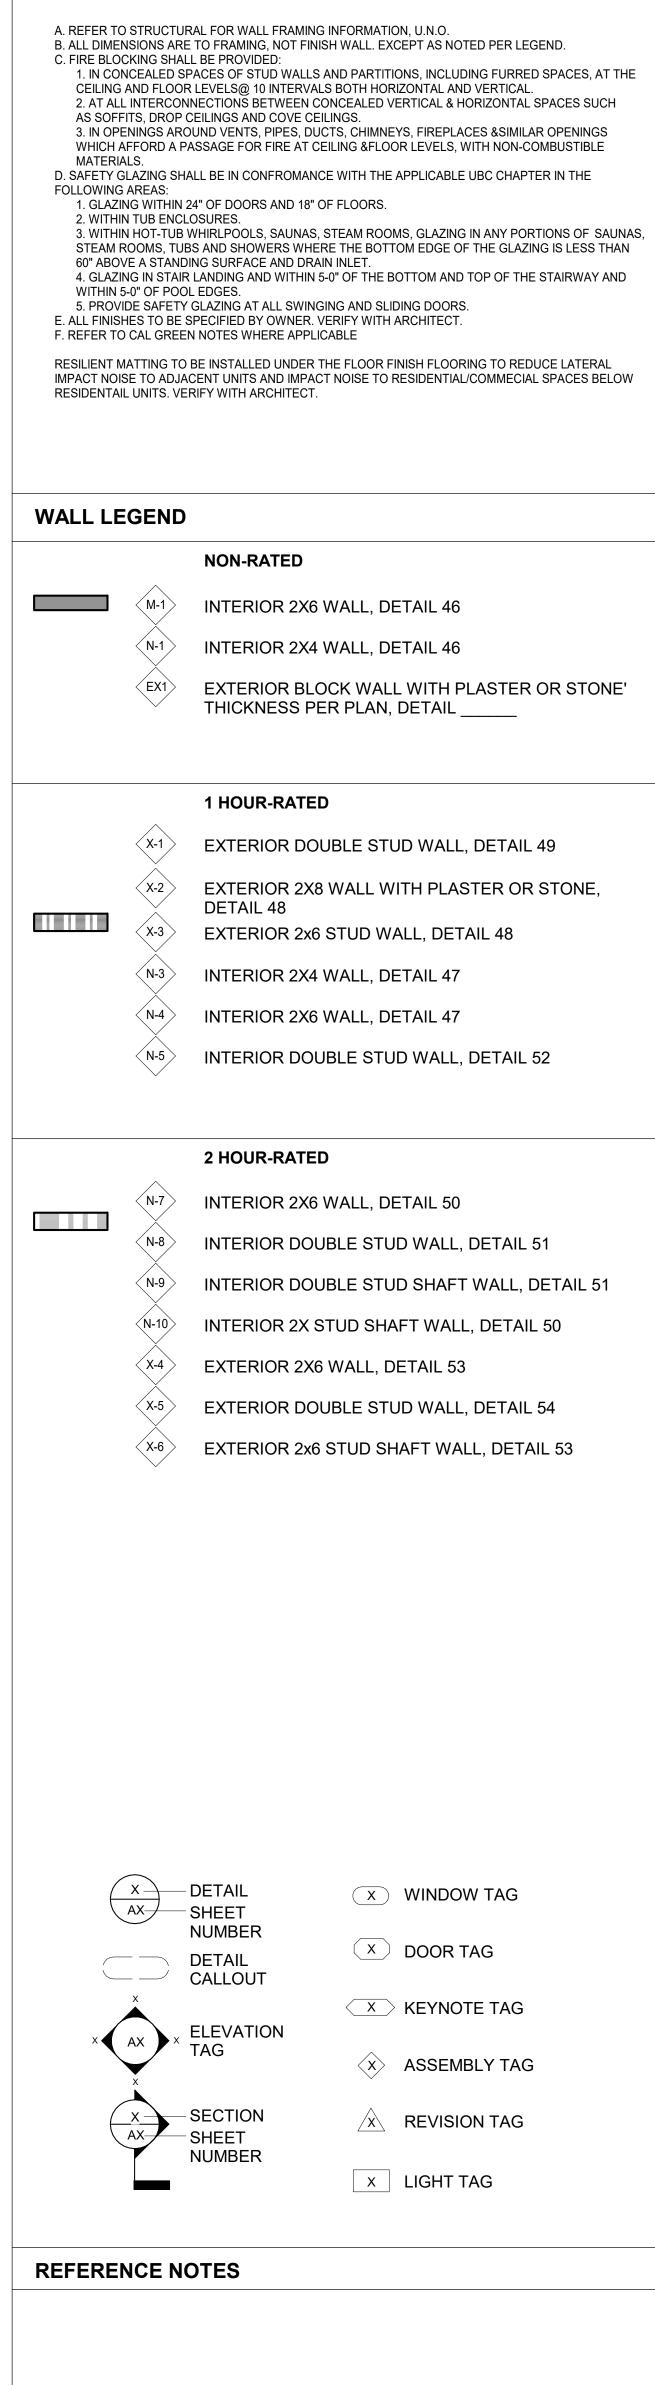

REVISION SCHEDULE

NO. DESCRIPTION DATE

LEVEL 2, BLDG B

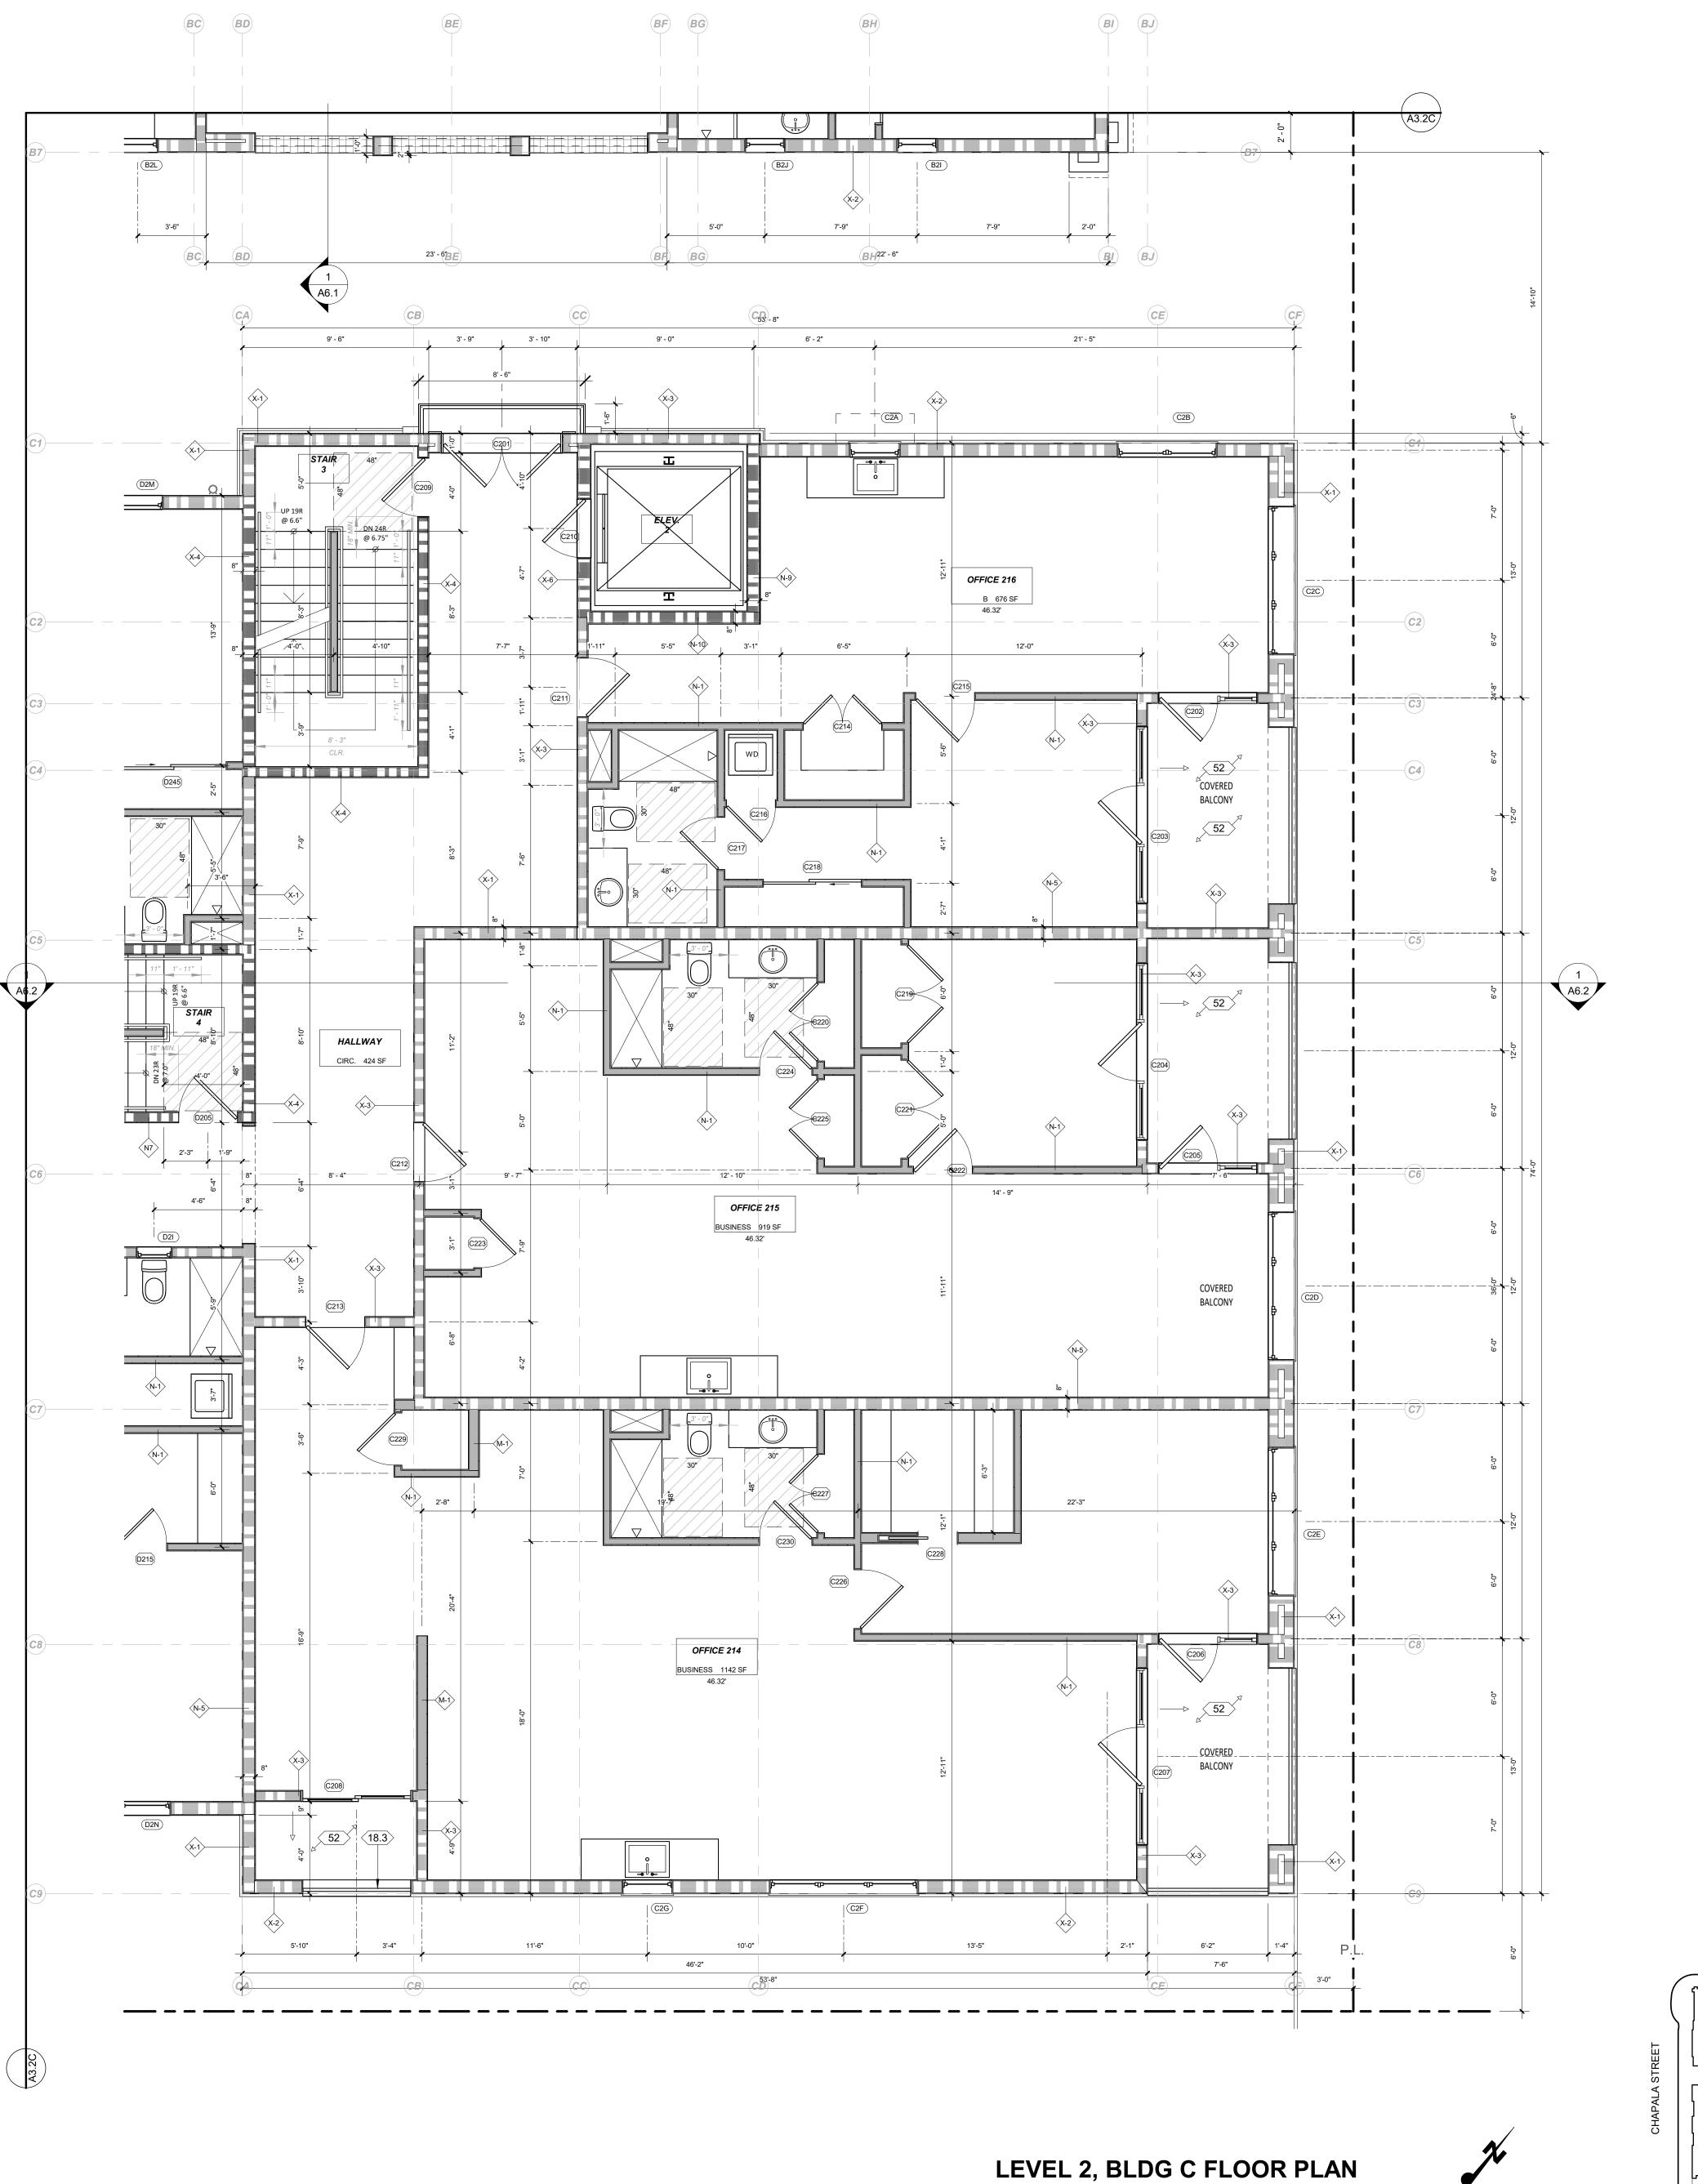


ORTEGA STREET



- A. REFER TO STRUCTURAL FOR WALL FRAMING INFORMATION, U.N.O.
- B. ALL DIMENSIONS ARE TO FRAMING, NOT FINISH WALL. EXCEPT AS NOTED PER LEGEND. C. FIRE BLOCKING SHALL BE PROVIDED: 1. IN CONCEALED SPACES OF STUD WALLS AND PARTITIONS, INCLUDING FURRED SPACES, AT THE
 - CEILING AND FLOOR LEVELS@ 10 INTERVALS BOTH HORIZONTAL AND VERTICAL. 2. AT ALL INTERCONNECTIONS BETWEEN CONCEALED VERTICAL & HORIZONTAL SPACES SUCH AS SOFFITS, DROP CEILINGS AND COVE CEILINGS. 3. IN OPENINGS AROUND VENTS, PIPES, DUCTS, CHIMNEYS, FIREPLACES & SIMILAR OPENINGS WHICH AFFORD A PASSAGE FOR FIRE AT CEILING &FLOOR LEVELS, WITH NON-COMBUSTIBLE
 - D. SAFETY GLAZING SHALL BE IN CONFROMANCE WITH THE APPLICABLE UBC CHAPTER IN THE FOLLOWING AREAS: 1. GLAZING WITHIN 24" OF DOORS AND 18" OF FLOORS.
 - 2. WITHIN TUB ENCLOSURES. 3. WITHIN HOT-TUB WHIRLPOOLS, SAUNAS, STEAM ROOMS, GLAZING IN ANY PORTIONS OF SAUNAS, STEAM ROOMS, TUBS AND SHOWERS WHERE THE BOTTOM EDGE OF THE GLAZING IS LESS THAN 60" ABOVE A STANDING SURFACE AND DRAIN INLET. 4. GLAZING IN STAIR LANDING AND WITHIN 5-0" OF THE BOTTOM AND TOP OF THE STAIRWAY AND WITHIN 5-0" OF POOL EDGES.
 - 5. PROVIDE SAFETY GLAZING AT ALL SWINGING AND SLIDING DOORS. E. ALL FINISHES TO BE SPECIFIED BY OWNER. VERIFY WITH ARCHITECT. F. REFER TO CAL GREEN NOTES WHERE APPLICABLE
 - RESILIENT MATTING TO BE INSTALLED UNDER THE FLOOR FINISH FLOORING TO REDUCE LATERAL IMPACT NOISE TO ADJACENT UNITS AND IMPACT NOISE TO RESIDENTIAL/COMMECIAL SPACES BELOW RESIDENTAIL UNITS. VERIFY WITH ARCHITECT.

WALL LEGEND

NON-RATED

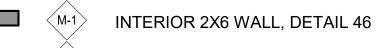

INTERIOR 2X4 WALL, DETAIL 46

EXTERIOR BLOCK WALL WITH PLASTER OR STONE' THICKNESS PER PLAN, DETAIL __

EXTERIOR 2X8 WALL WITH PLASTER OR STONE,

1 HOUR-RATED

EXTERIOR DOUBLE STUD WALL, DETAIL 49

DETAIL 48 EXTERIOR 2x6 STUD WALL, DETAIL 48

INTERIOR 2X4 WALL, DETAIL 47

INTERIOR 2X6 WALL, DETAIL 47

N-5 INTERIOR DOUBLE STUD WALL, DETAIL 52

2 HOUR-RATED



INTERIOR 2X6 WALL, DETAIL 50

(N-8) INTERIOR DOUBLE STUD WALL, DETAIL 51

INTERIOR DOUBLE STUD SHAFT WALL, DETAIL 51

INTERIOR 2X STUD SHAFT WALL, DETAIL 50

EXTERIOR 2X6 WALL, DETAIL 53

EXTERIOR DOUBLE STUD WALL, DETAIL 54

(X-6) EXTERIOR 2x6 STUD SHAFT WALL, DETAIL 53

DETAIL SHEET ____ DETAIL CALLOUT

ELEVATION

-SHEET

NUMBER

X WINDOW TAG

X DOOR TAG

X KEYNOTE TAG X ASSEMBLY TAG

X REVISION TAG


X LIGHT TAG

REFERENCE NOTES

REVISION SCHEDULE


NO. DESCRIPTION DATE


LEVEL 2, BLDG C

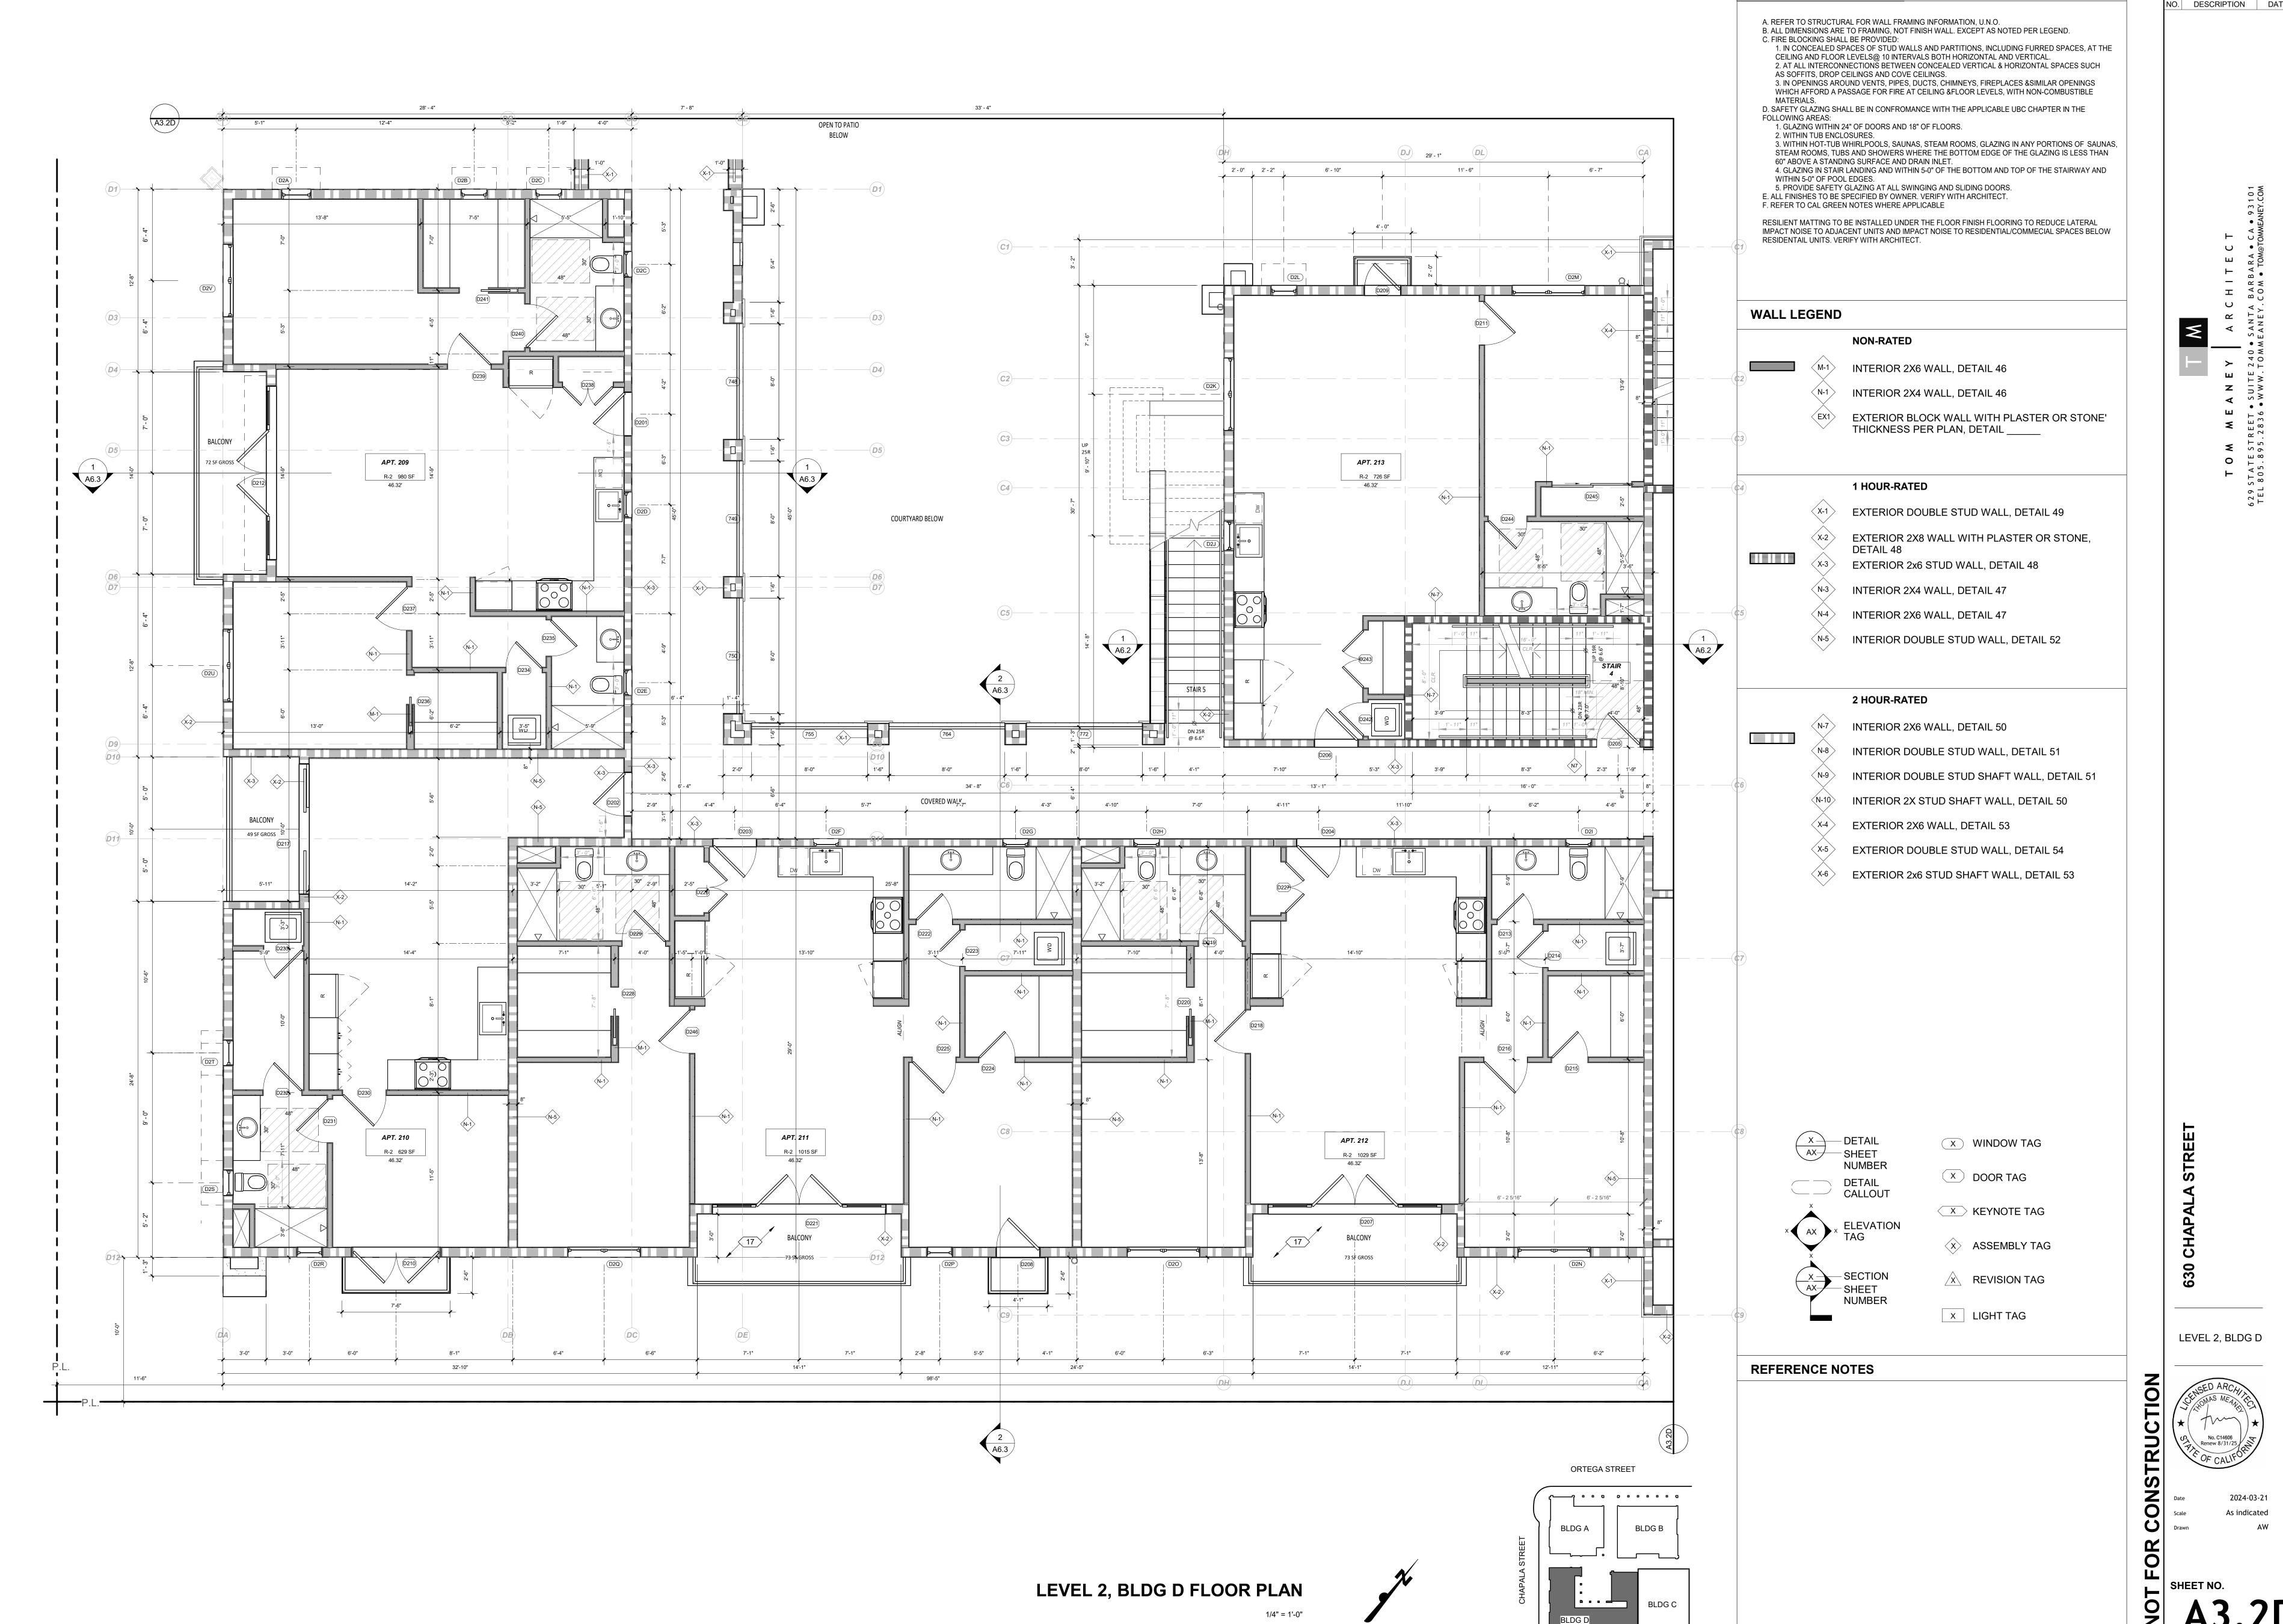

REVISION SCHEDULE NO. DESCRIPTION DATE

GENERAL NOTES

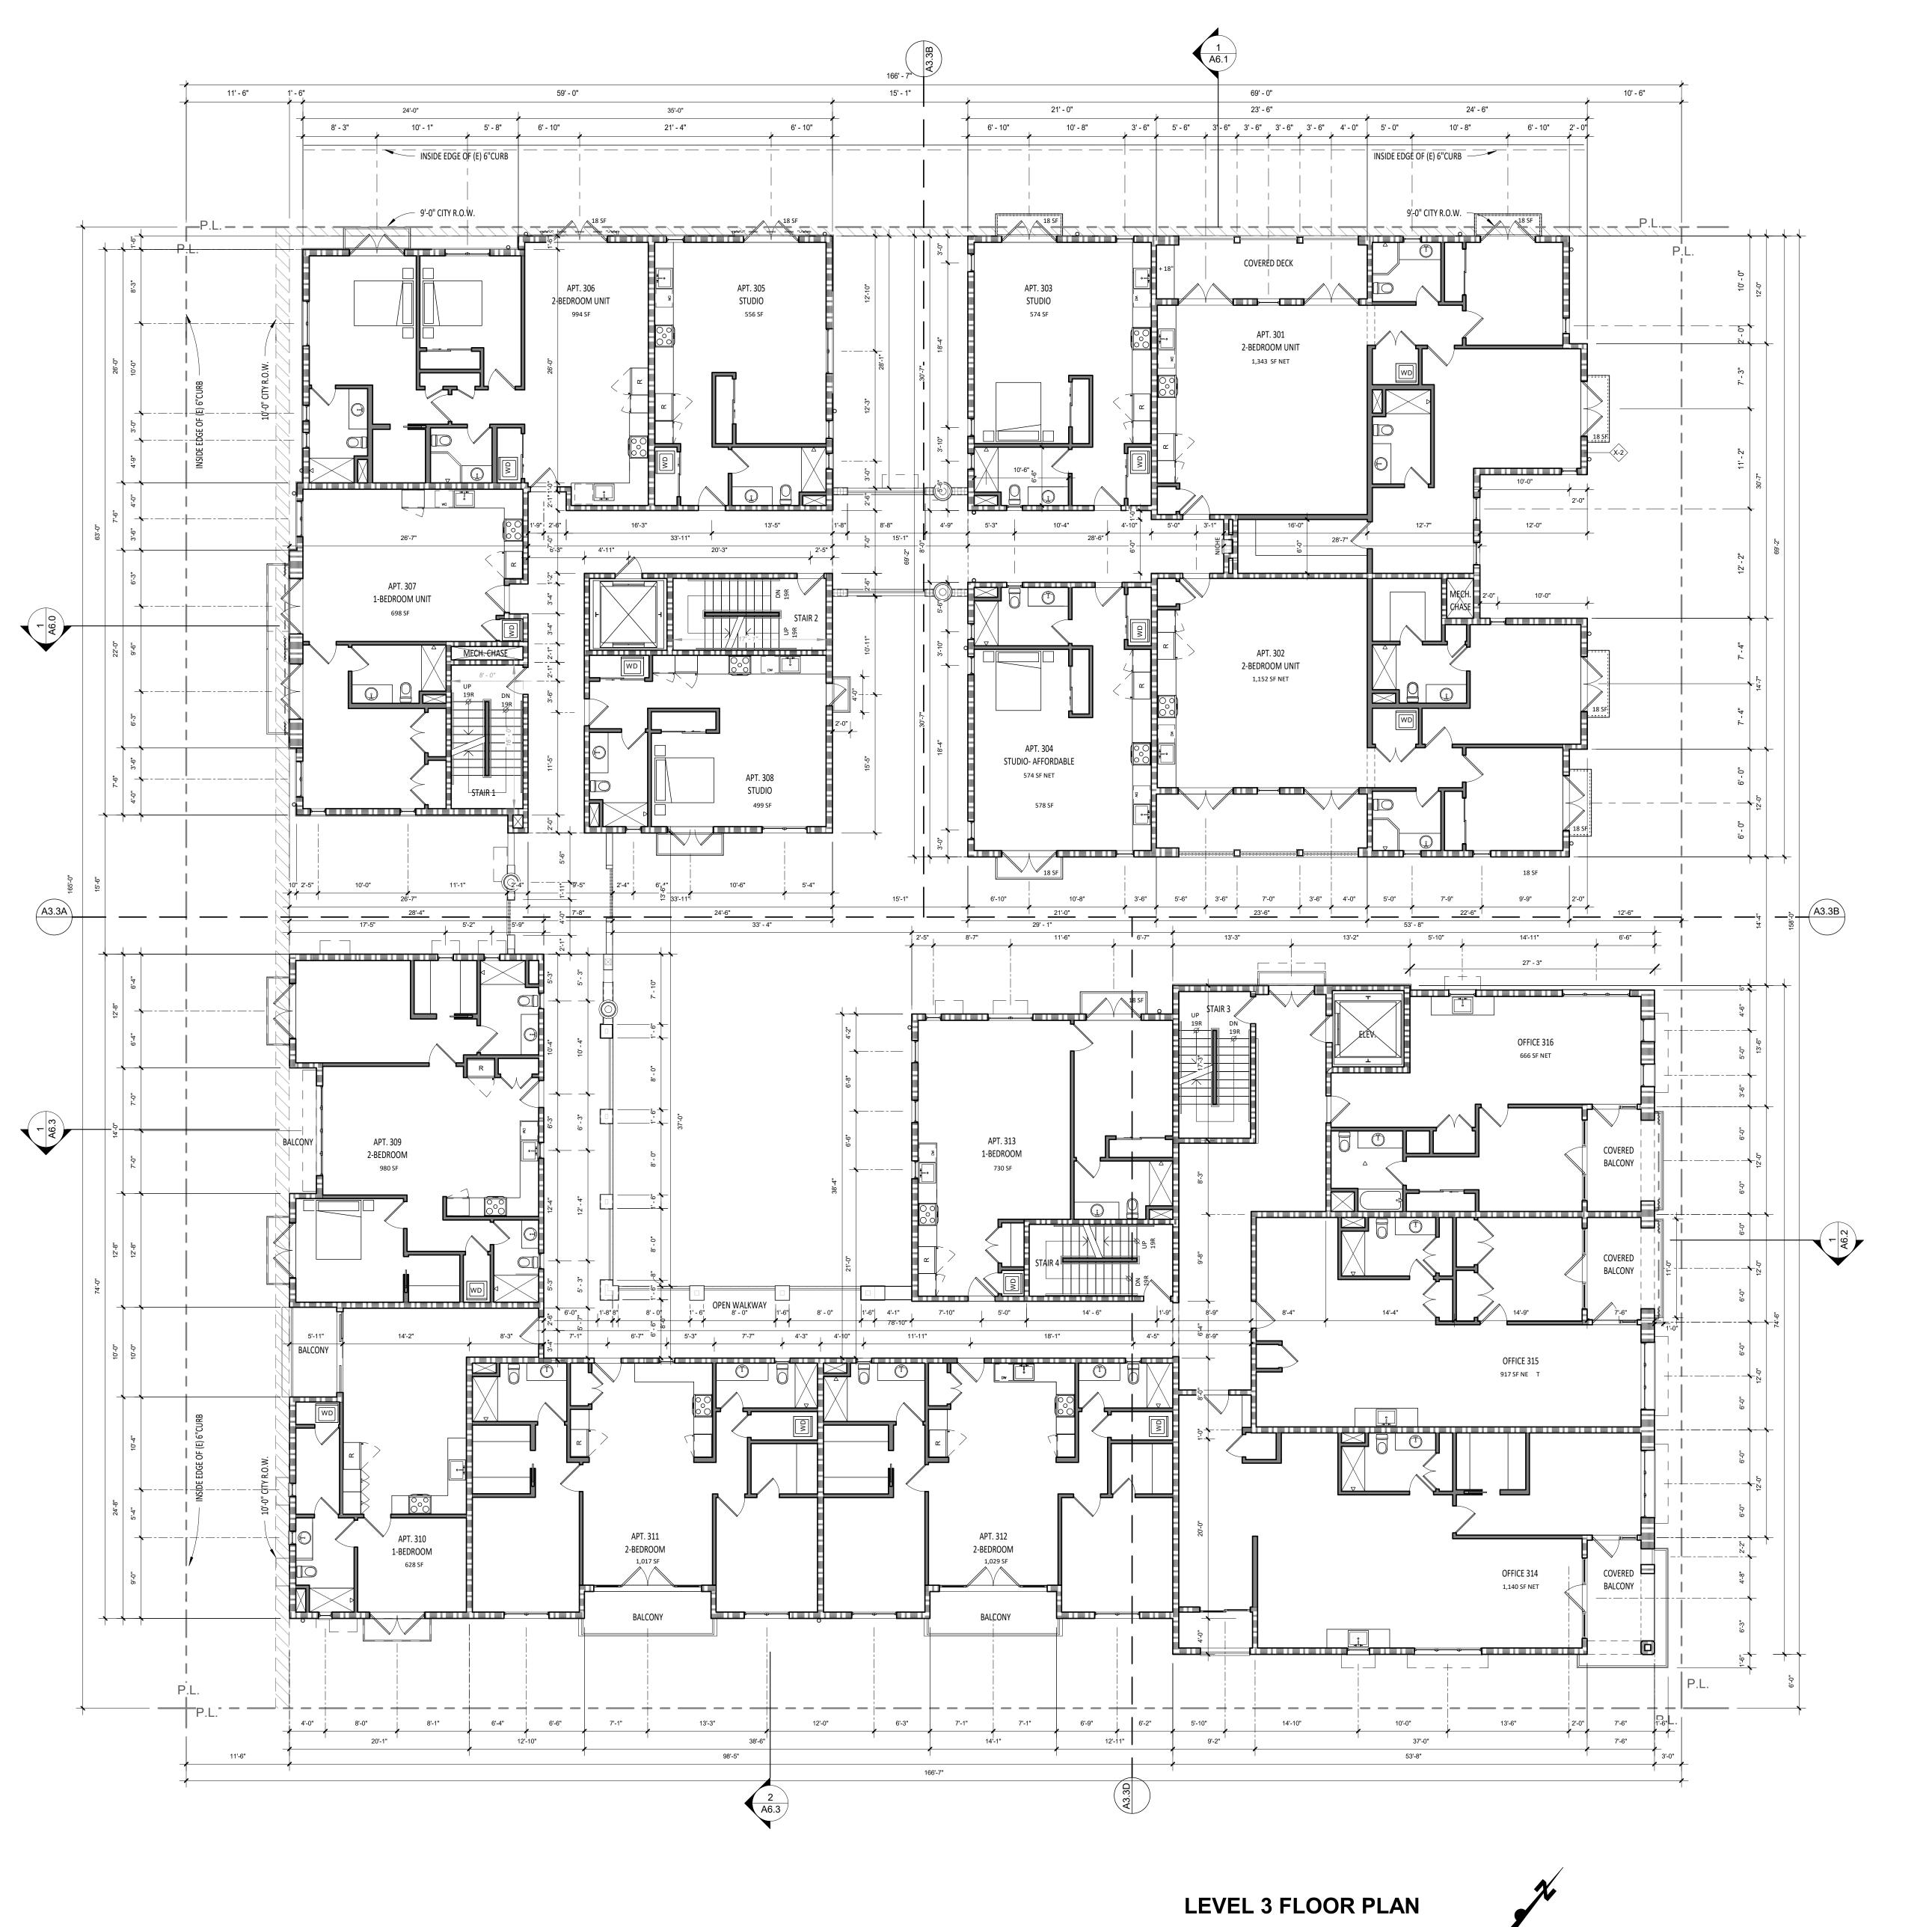

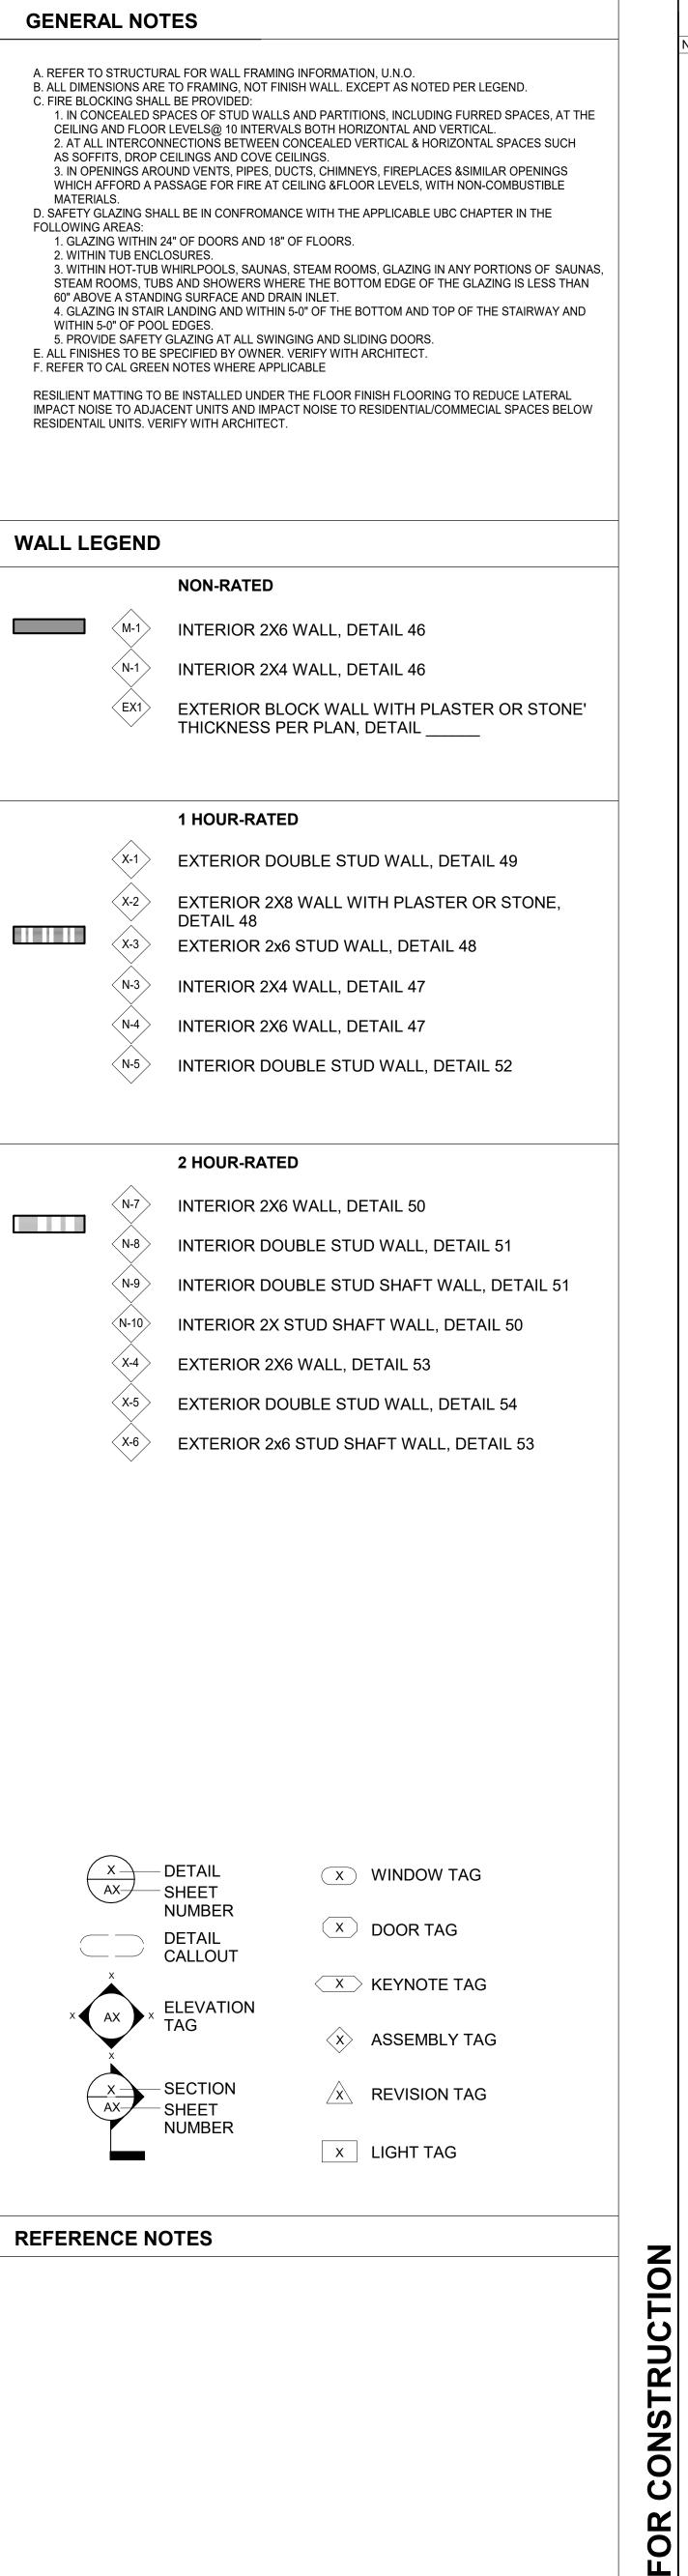


OVERALL THIRD

FLOOR PLAN

REVISION SCHEDULE

O. DESCRIPTION DATE

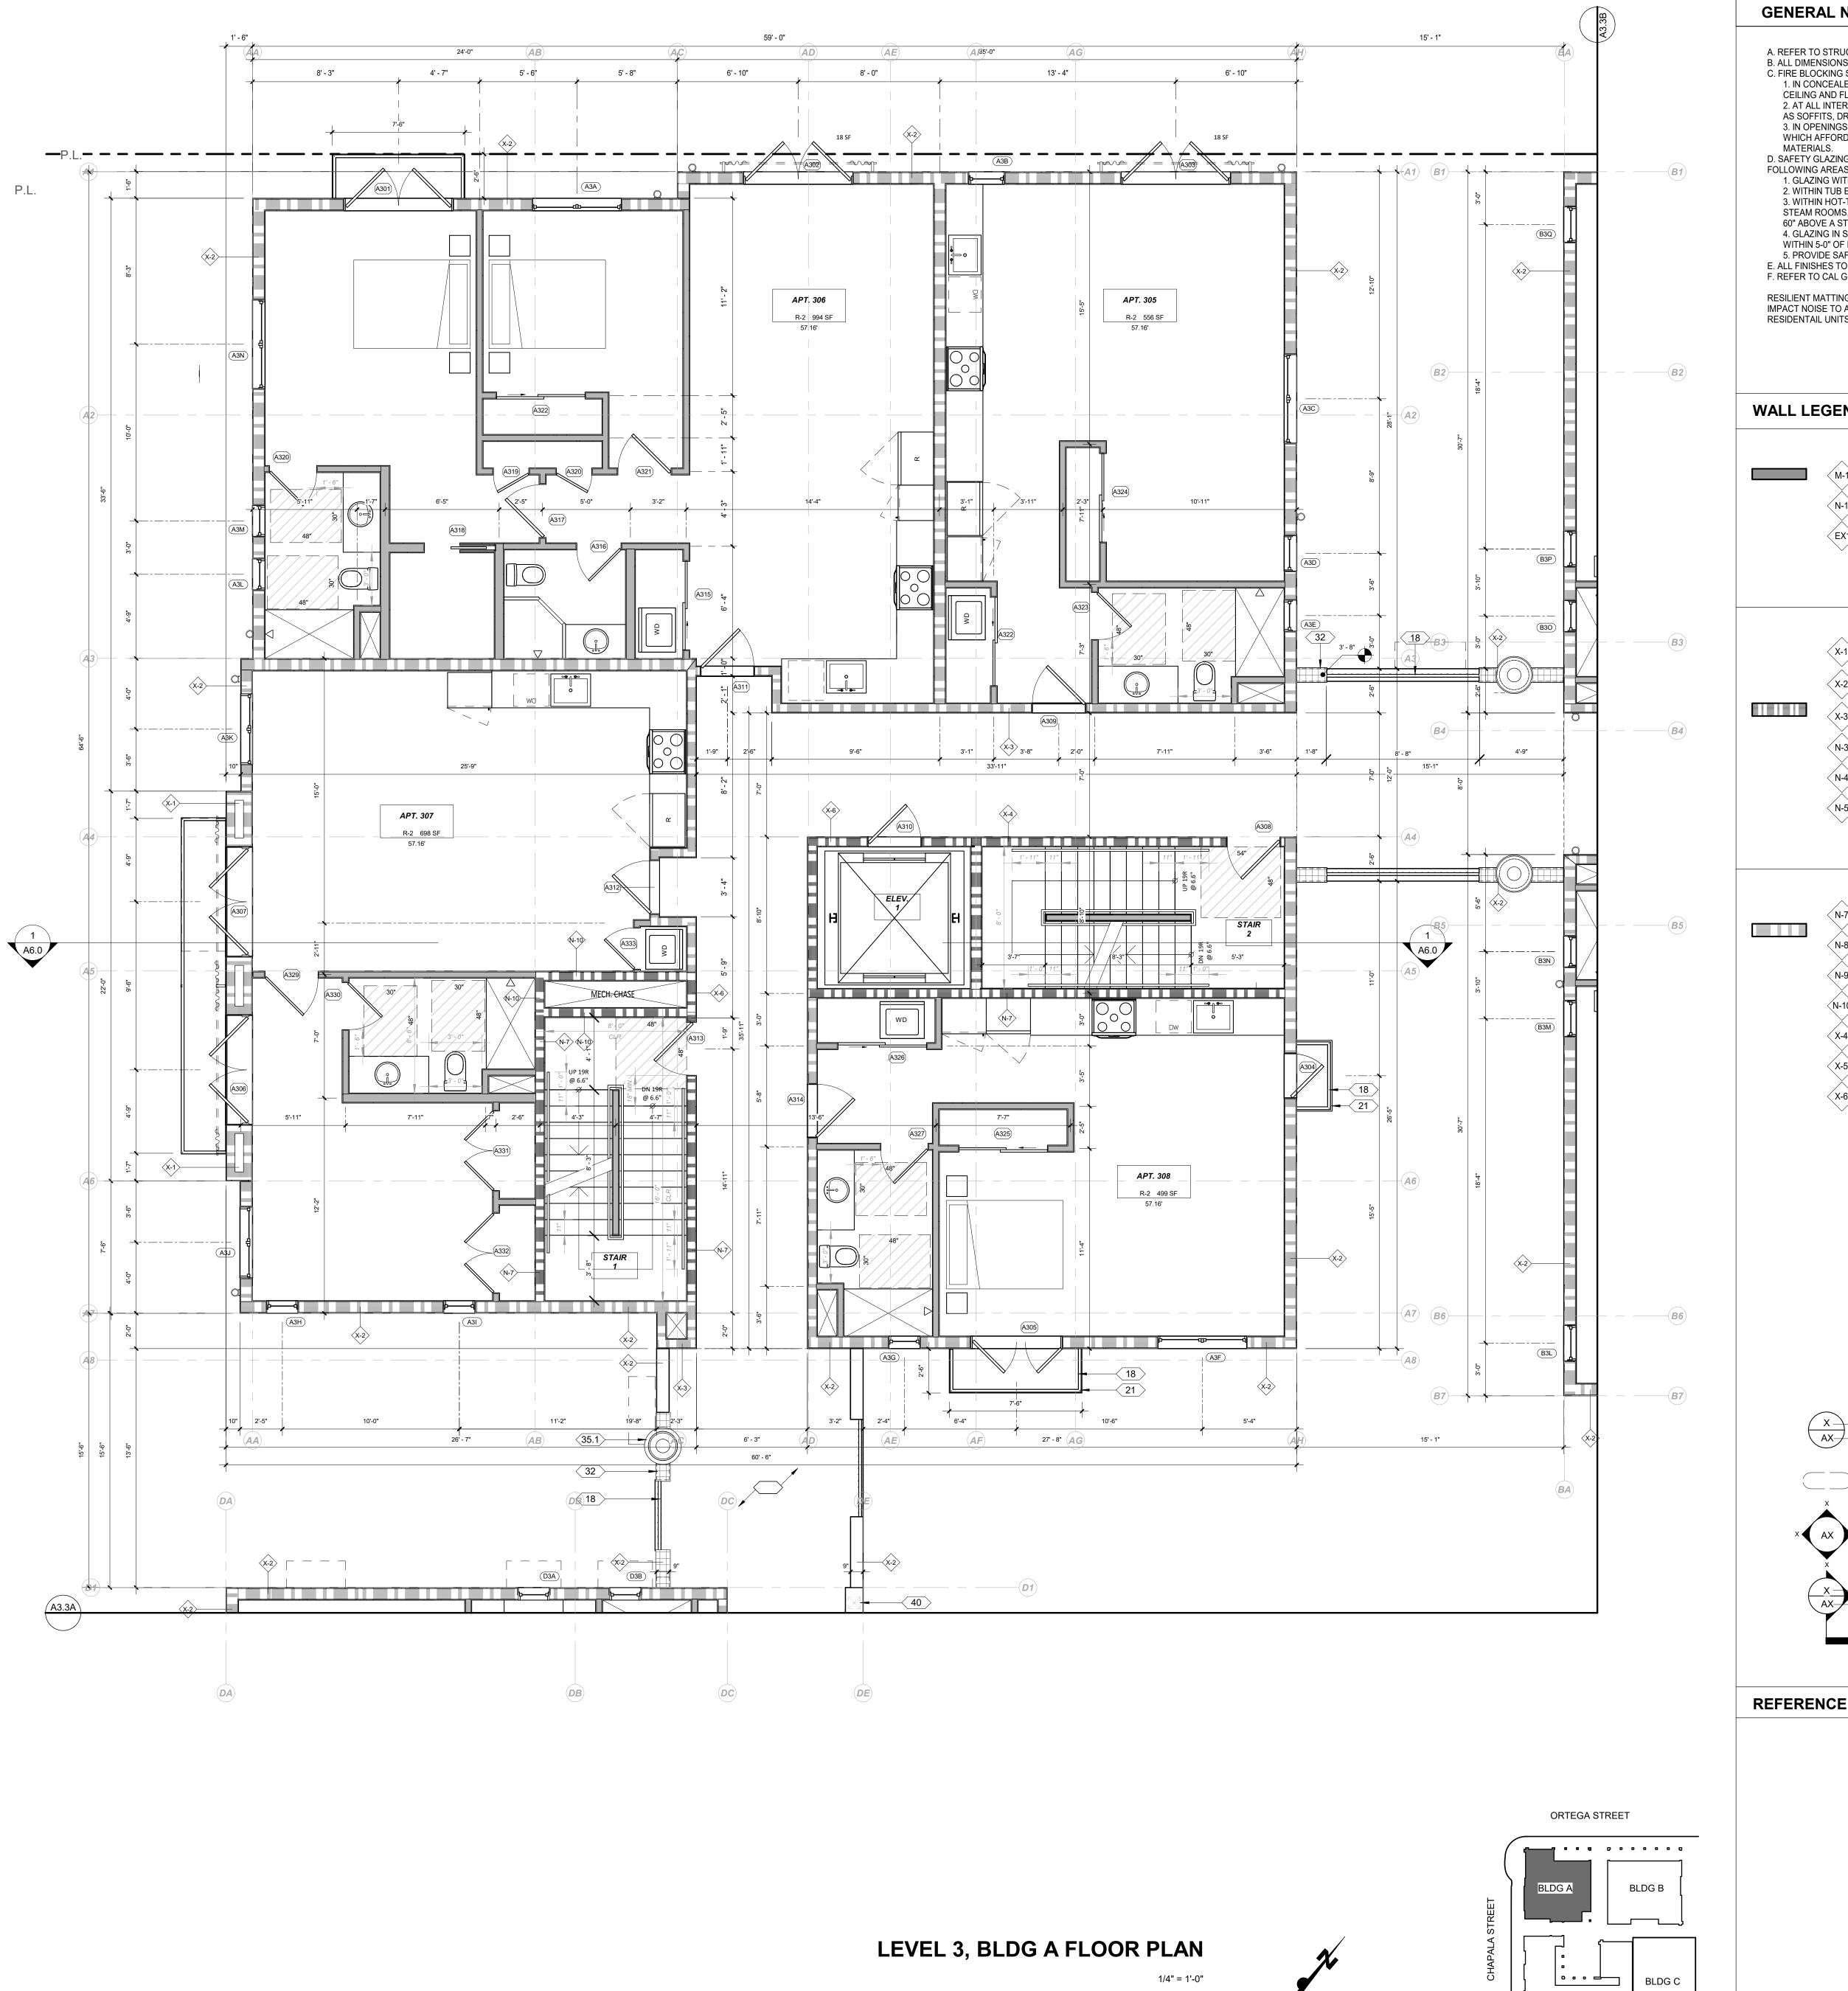

REVISION SCHEDULE **GENERAL NOTES** NO. DESCRIPTION DATE A. REFER TO STRUCTURAL FOR WALL FRAMING INFORMATION, U.N.O. B. ALL DIMENSIONS ARE TO FRAMING, NOT FINISH WALL. EXCEPT AS NOTED PER LEGEND. C. FIRE BLOCKING SHALL BE PROVIDED: 1. IN CONCEALED SPACES OF STUD WALLS AND PARTITIONS, INCLUDING FURRED SPACES, AT THE CEILING AND FLOOR LEVELS@ 10 INTERVALS BOTH HORIZONTAL AND VERTICAL. 2. AT ALL INTERCONNECTIONS BETWEEN CONCEALED VERTICAL & HORIZONTAL SPACES SUCH AS SOFFITS, DROP CEILINGS AND COVE CEILINGS. 3. IN OPENINGS AROUND VENTS, PIPES, DUCTS, CHIMNEYS, FIREPLACES & SIMILAR OPENINGS WHICH AFFORD A PASSAGE FOR FIRE AT CEILING &FLOOR LEVELS, WITH NON-COMBUSTIBLE D. SAFETY GLAZING SHALL BE IN CONFROMANCE WITH THE APPLICABLE UBC CHAPTER IN THE FOLLOWING AREAS: 1. GLAZING WITHIN 24" OF DOORS AND 18" OF FLOORS. 2. WITHIN TUB ENCLOSURES. 3. WITHIN HOT-TUB WHIRLPOOLS, SAUNAS, STEAM ROOMS, GLAZING IN ANY PORTIONS OF SAUNAS, STEAM ROOMS, TUBS AND SHOWERS WHERE THE BOTTOM EDGE OF THE GLAZING IS LESS THAN 60" ABOVE A STANDING SURFACE AND DRAIN INLET. 4. GLAZING IN STAIR LANDING AND WITHIN 5-0" OF THE BOTTOM AND TOP OF THE STAIRWAY AND WITHIN 5-0" OF POOL EDGES. 5. PROVIDE SAFETY GLAZING AT ALL SWINGING AND SLIDING DOORS. E. ALL FINISHES TO BE SPECIFIED BY OWNER. VERIFY WITH ARCHITECT. F. REFER TO CAL GREEN NOTES WHERE APPLICABLE RESILIENT MATTING TO BE INSTALLED UNDER THE FLOOR FINISH FLOORING TO REDUCE LATERAL IMPACT NOISE TO ADJACENT UNITS AND IMPACT NOISE TO RESIDENTIAL/COMMECIAL SPACES BELOW RESIDENTAIL UNITS. VERIFY WITH ARCHITECT.

WALL LEGEND

NON-RATED

INTERIOR 2X6 WALL, DETAIL 46 INTERIOR 2X4 WALL, DETAIL 46

> EXTERIOR BLOCK WALL WITH PLASTER OR STONE' THICKNESS PER PLAN, DETAIL ___

1 HOUR-RATED

EXTERIOR DOUBLE STUD WALL, DETAIL 49

EXTERIOR 2X8 WALL WITH PLASTER OR STONE,

EXTERIOR 2x6 STUD WALL, DETAIL 48

INTERIOR 2X4 WALL, DETAIL 47 INTERIOR 2X6 WALL, DETAIL 47

INTERIOR DOUBLE STUD WALL, DETAIL 52

2 HOUR-RATED

INTERIOR 2X6 WALL, DETAIL 50

INTERIOR DOUBLE STUD WALL, DETAIL 51

INTERIOR DOUBLE STUD SHAFT WALL, DETAIL 51

INTERIOR 2X STUD SHAFT WALL, DETAIL 50

(X-4) EXTERIOR 2X6 WALL, DETAIL 53

EXTERIOR DOUBLE STUD WALL, DETAIL 54

EXTERIOR 2x6 STUD SHAFT WALL, DETAIL 53

SHEET DETAIL CALLOUT

× ELEVATION TAG

SHEET
NUMBER

X WINDOW TAG X DOOR TAG

X KEYNOTE TAG


X ASSEMBLY TAG


REVISION TAG

X LIGHT TAG

REFERENCE NOTES

LEVEL 3, BLDG A

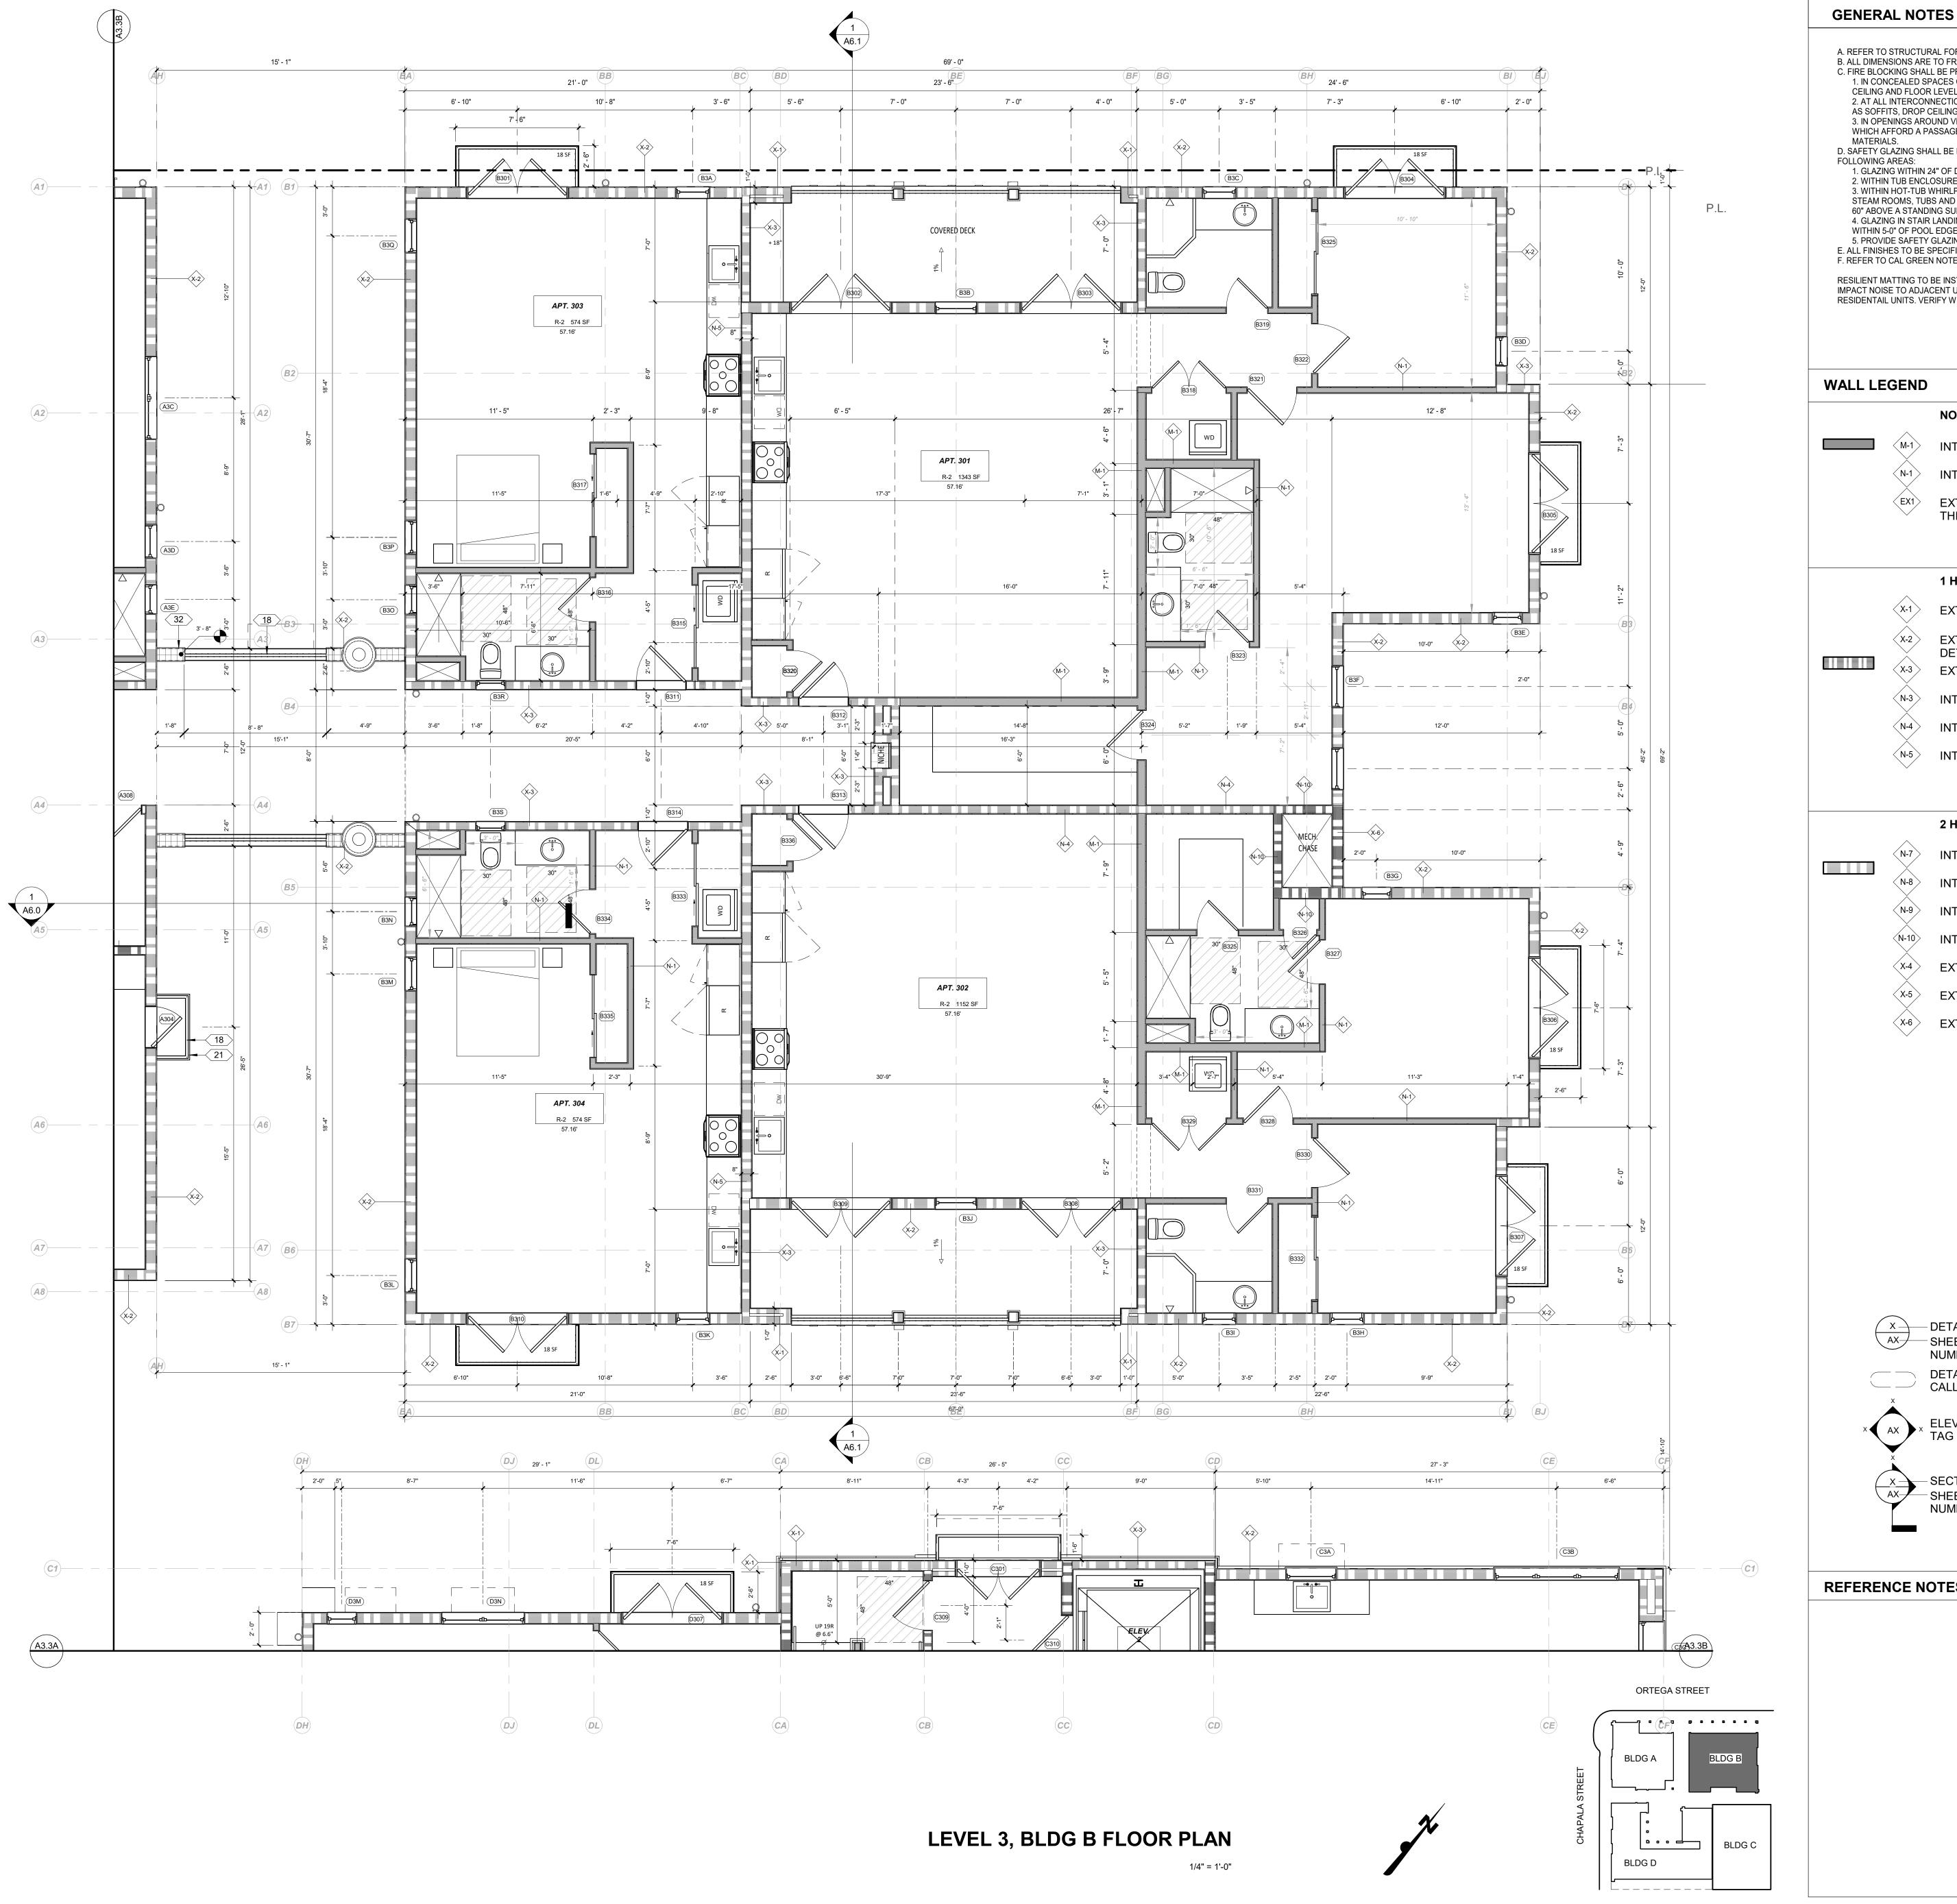


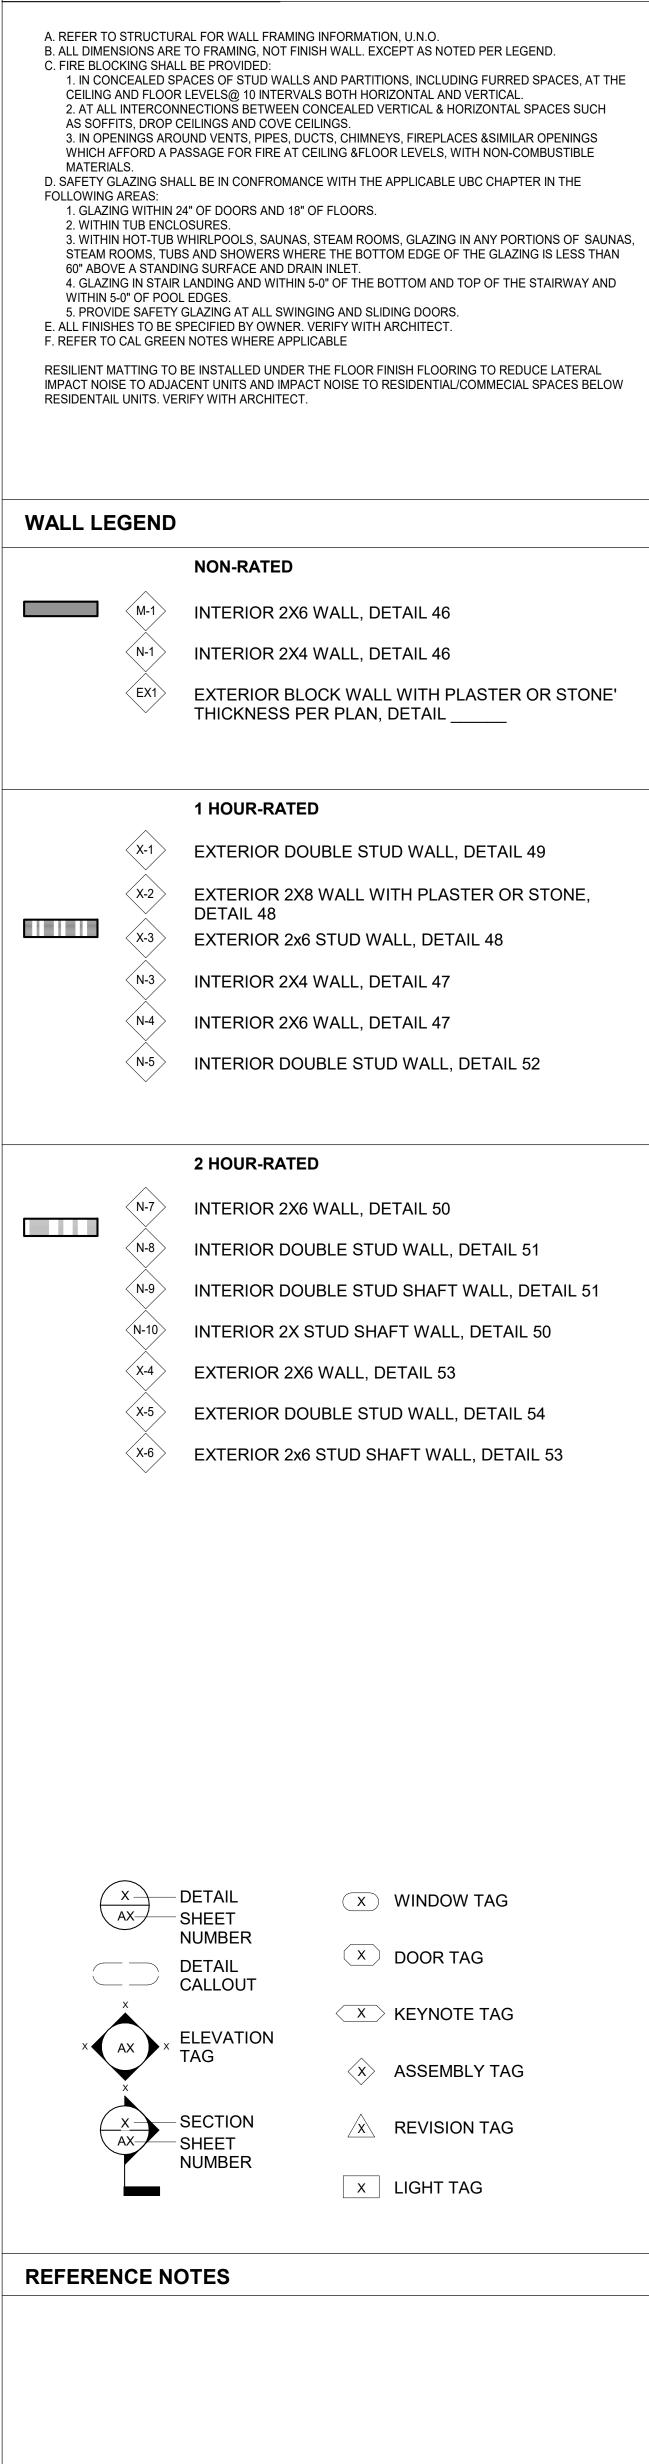

LEVEL 3, BLDG B

REVISION SCHEDULE

NO. DESCRIPTION DATE

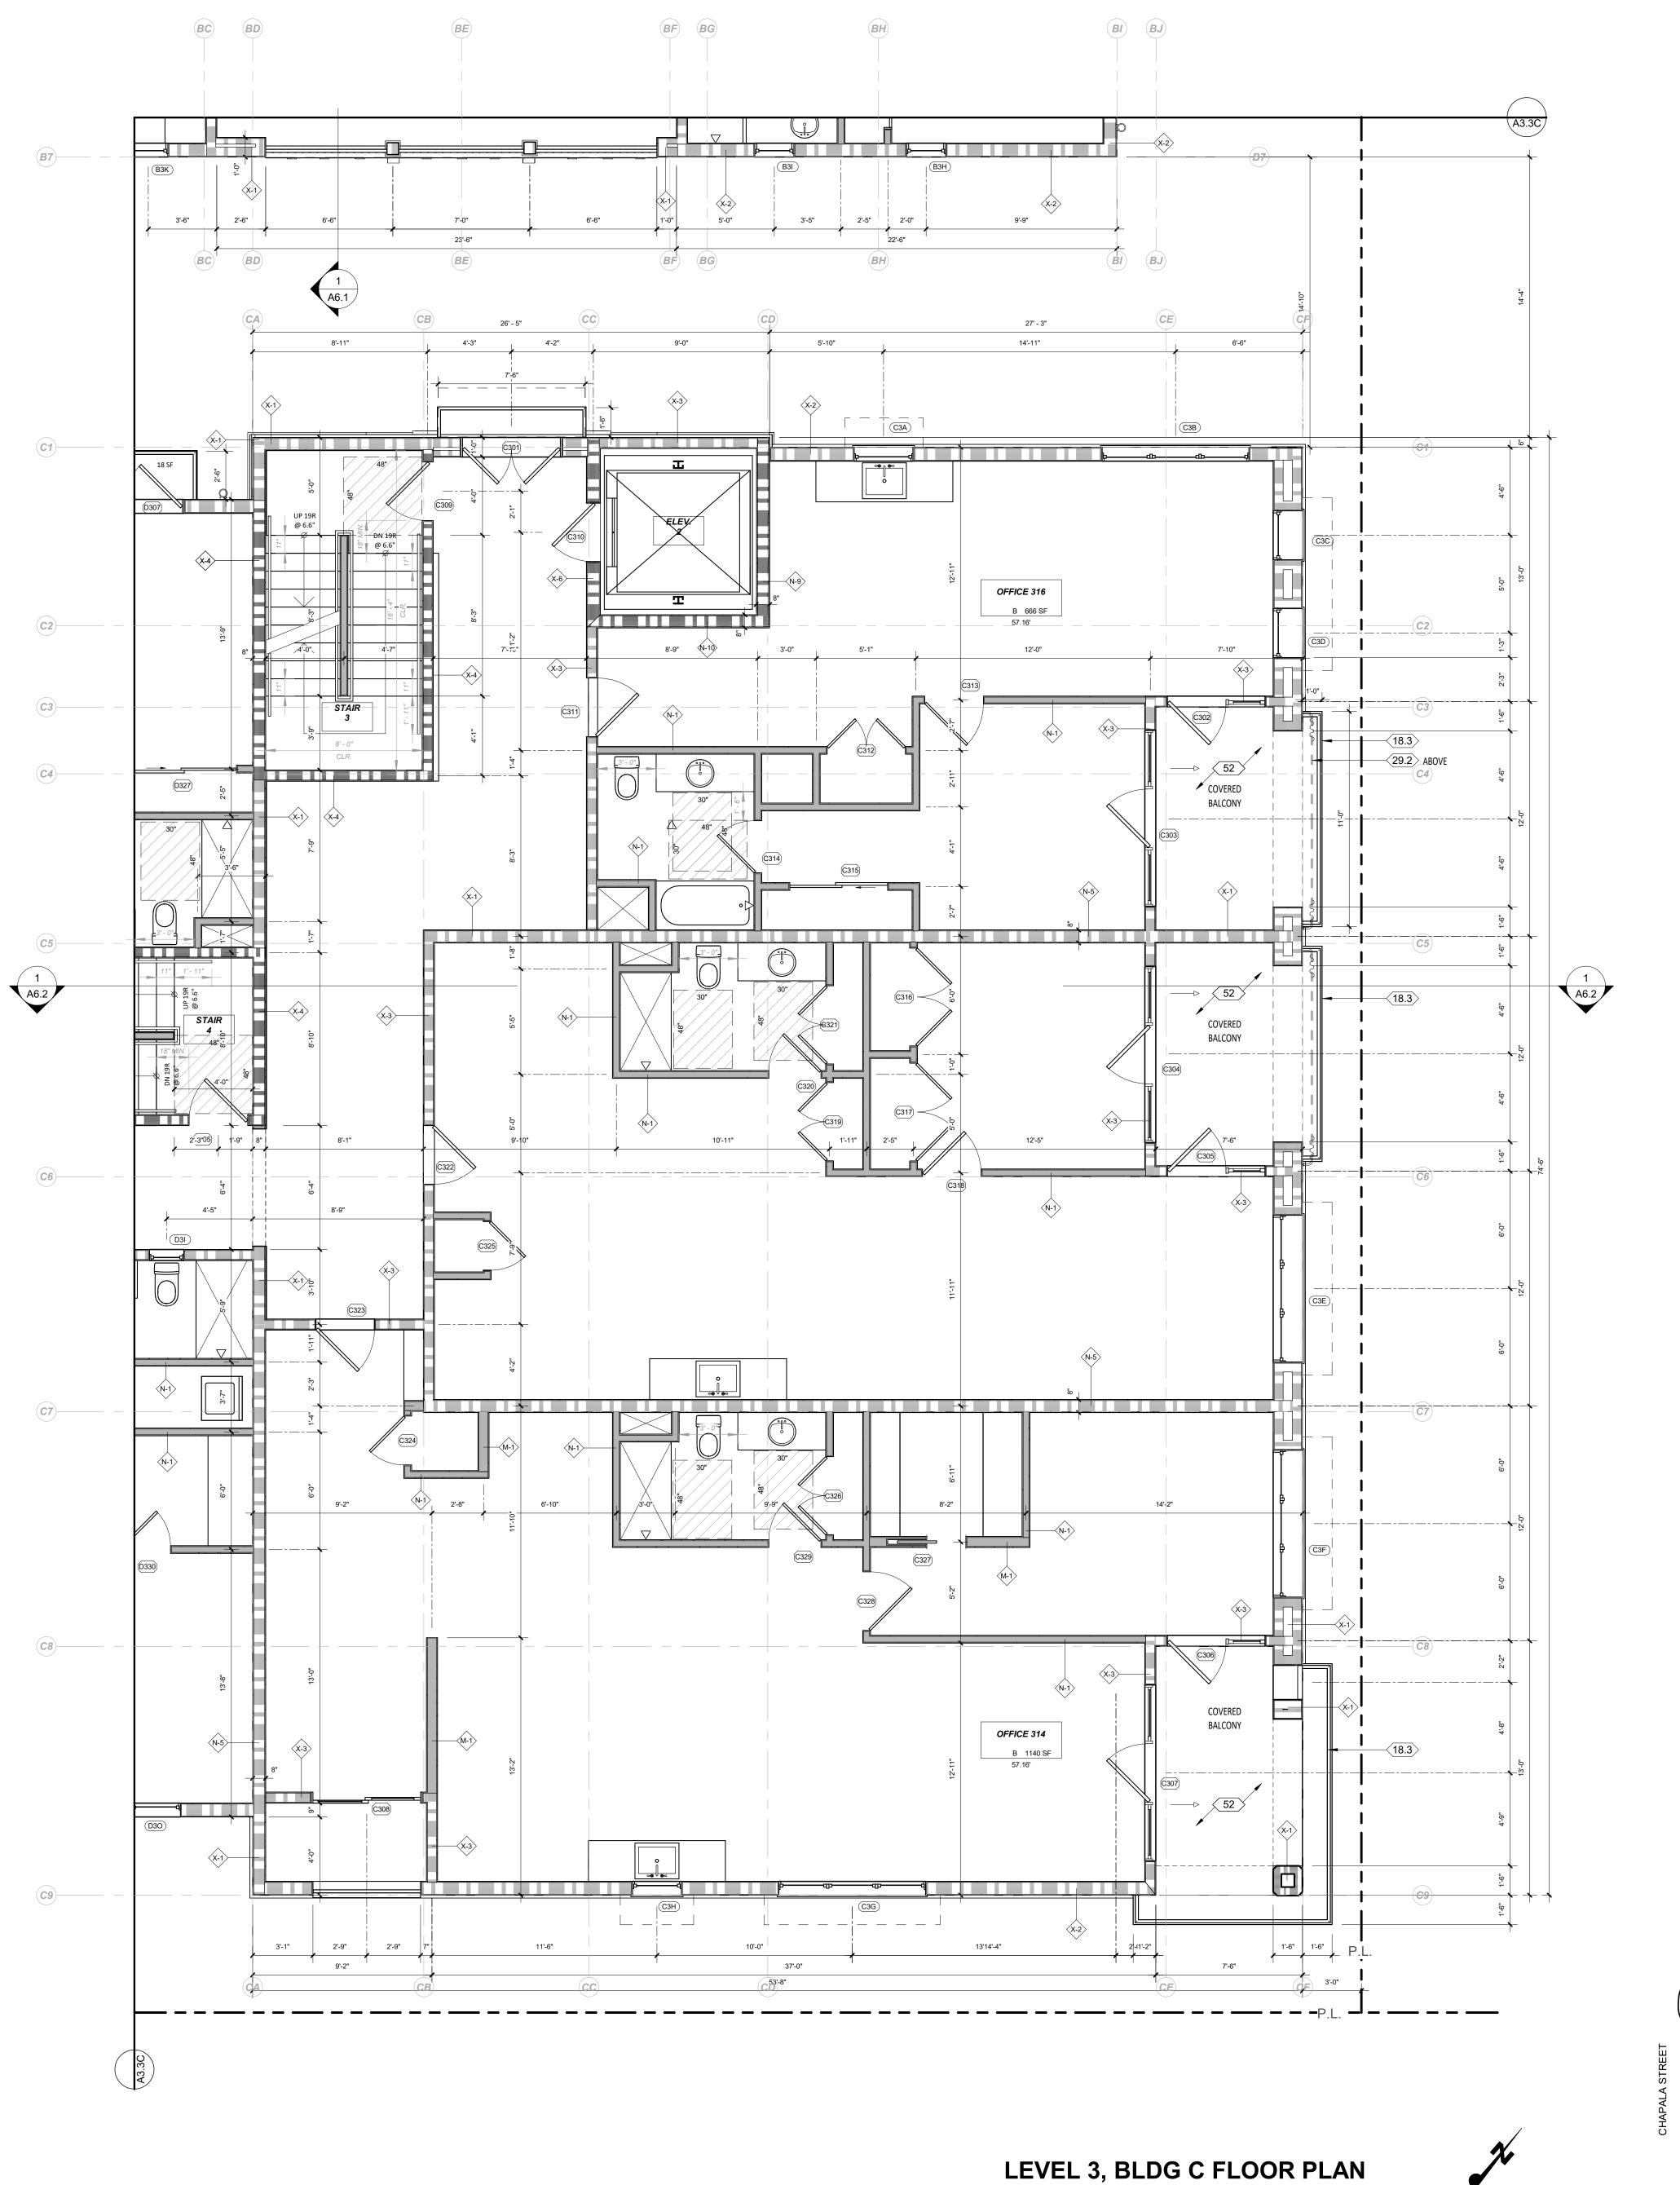

ORTEGA STREET BLDG A | • • • -BLDG D



A. REFER TO STRUCTURAL FOR WALL FRAMING INFORMATION, U.N.O.

B. ALL DIMENSIONS ARE TO FRAMING, NOT FINISH WALL. EXCEPT AS NOTED PER LEGEND. C. FIRE BLOCKING SHALL BE PROVIDED: 1. IN CONCEALED SPACES OF STUD WALLS AND PARTITIONS, INCLUDING FURRED SPACES, AT THE CEILING AND FLOOR LEVELS@ 10 INTERVALS BOTH HORIZONTAL AND VERTICAL.

2. AT ALL INTERCONNECTIONS BETWEEN CONCEALED VERTICAL & HORIZONTAL SPACES SUCH AS SOFFITS, DROP CEILINGS AND COVE CEILINGS. 3. IN OPENINGS AROUND VENTS, PIPES, DUCTS, CHIMNEYS, FIREPLACES & SIMILAR OPENINGS WHICH AFFORD A PASSAGE FOR FIRE AT CEILING &FLOOR LEVELS, WITH NON-COMBUSTIBLE

D. SAFETY GLAZING SHALL BE IN CONFROMANCE WITH THE APPLICABLE UBC CHAPTER IN THE FOLLOWING AREAS: 1. GLAZING WITHIN 24" OF DOORS AND 18" OF FLOORS. 2. WITHIN TUB ENCLOSURES.

3. WITHIN HOT-TUB WHIRLPOOLS, SAUNAS, STEAM ROOMS, GLAZING IN ANY PORTIONS OF SAUNAS, STEAM ROOMS, TUBS AND SHOWERS WHERE THE BOTTOM EDGE OF THE GLAZING IS LESS THAN 60" ABOVE A STANDING SURFACE AND DRAIN INLET. 4. GLAZING IN STAIR LANDING AND WITHIN 5-0" OF THE BOTTOM AND TOP OF THE STAIRWAY AND WITHIN 5-0" OF POOL EDGES.

5. PROVIDE SAFETY GLAZING AT ALL SWINGING AND SLIDING DOORS. E. ALL FINISHES TO BE SPECIFIED BY OWNER. VERIFY WITH ARCHITECT. F. REFER TO CAL GREEN NOTES WHERE APPLICABLE

RESILIENT MATTING TO BE INSTALLED UNDER THE FLOOR FINISH FLOORING TO REDUCE LATERAL IMPACT NOISE TO ADJACENT UNITS AND IMPACT NOISE TO RESIDENTIAL/COMMECIAL SPACES BELOW RESIDENTAIL UNITS. VERIFY WITH ARCHITECT.

WALL LEGEND

NON-RATED



INTERIOR 2X4 WALL, DETAIL 46

EXTERIOR BLOCK WALL WITH PLASTER OR STONE' THICKNESS PER PLAN, DETAIL __

1 HOUR-RATED

EXTERIOR DOUBLE STUD WALL, DETAIL 49


EXTERIOR 2X8 WALL WITH PLASTER OR STONE, **DETAIL 48** EXTERIOR 2x6 STUD WALL, DETAIL 48

INTERIOR 2X4 WALL, DETAIL 47

INTERIOR 2X6 WALL, DETAIL 47

N-5 INTERIOR DOUBLE STUD WALL, DETAIL 52

2 HOUR-RATED

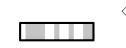

INTERIOR 2X6 WALL, DETAIL 50

(N-8) INTERIOR DOUBLE STUD WALL, DETAIL 51

INTERIOR DOUBLE STUD SHAFT WALL, DETAIL 51

INTERIOR 2X STUD SHAFT WALL, DETAIL 50

EXTERIOR 2X6 WALL, DETAIL 53

EXTERIOR DOUBLE STUD WALL, DETAIL 54

EXTERIOR 2x6 STUD SHAFT WALL, DETAIL 53

DETAIL SHEET ____ DETAIL CALLOUT

ELEVATION

-SHEET NUMBER X WINDOW TAG

X DOOR TAG

X KEYNOTE TAG

X ASSEMBLY TAG X REVISION TAG

X LIGHT TAG


REFERENCE NOTES


LEVEL 3, BLDG C



REVISION SCHEDULE

NO. DESCRIPTION DATE

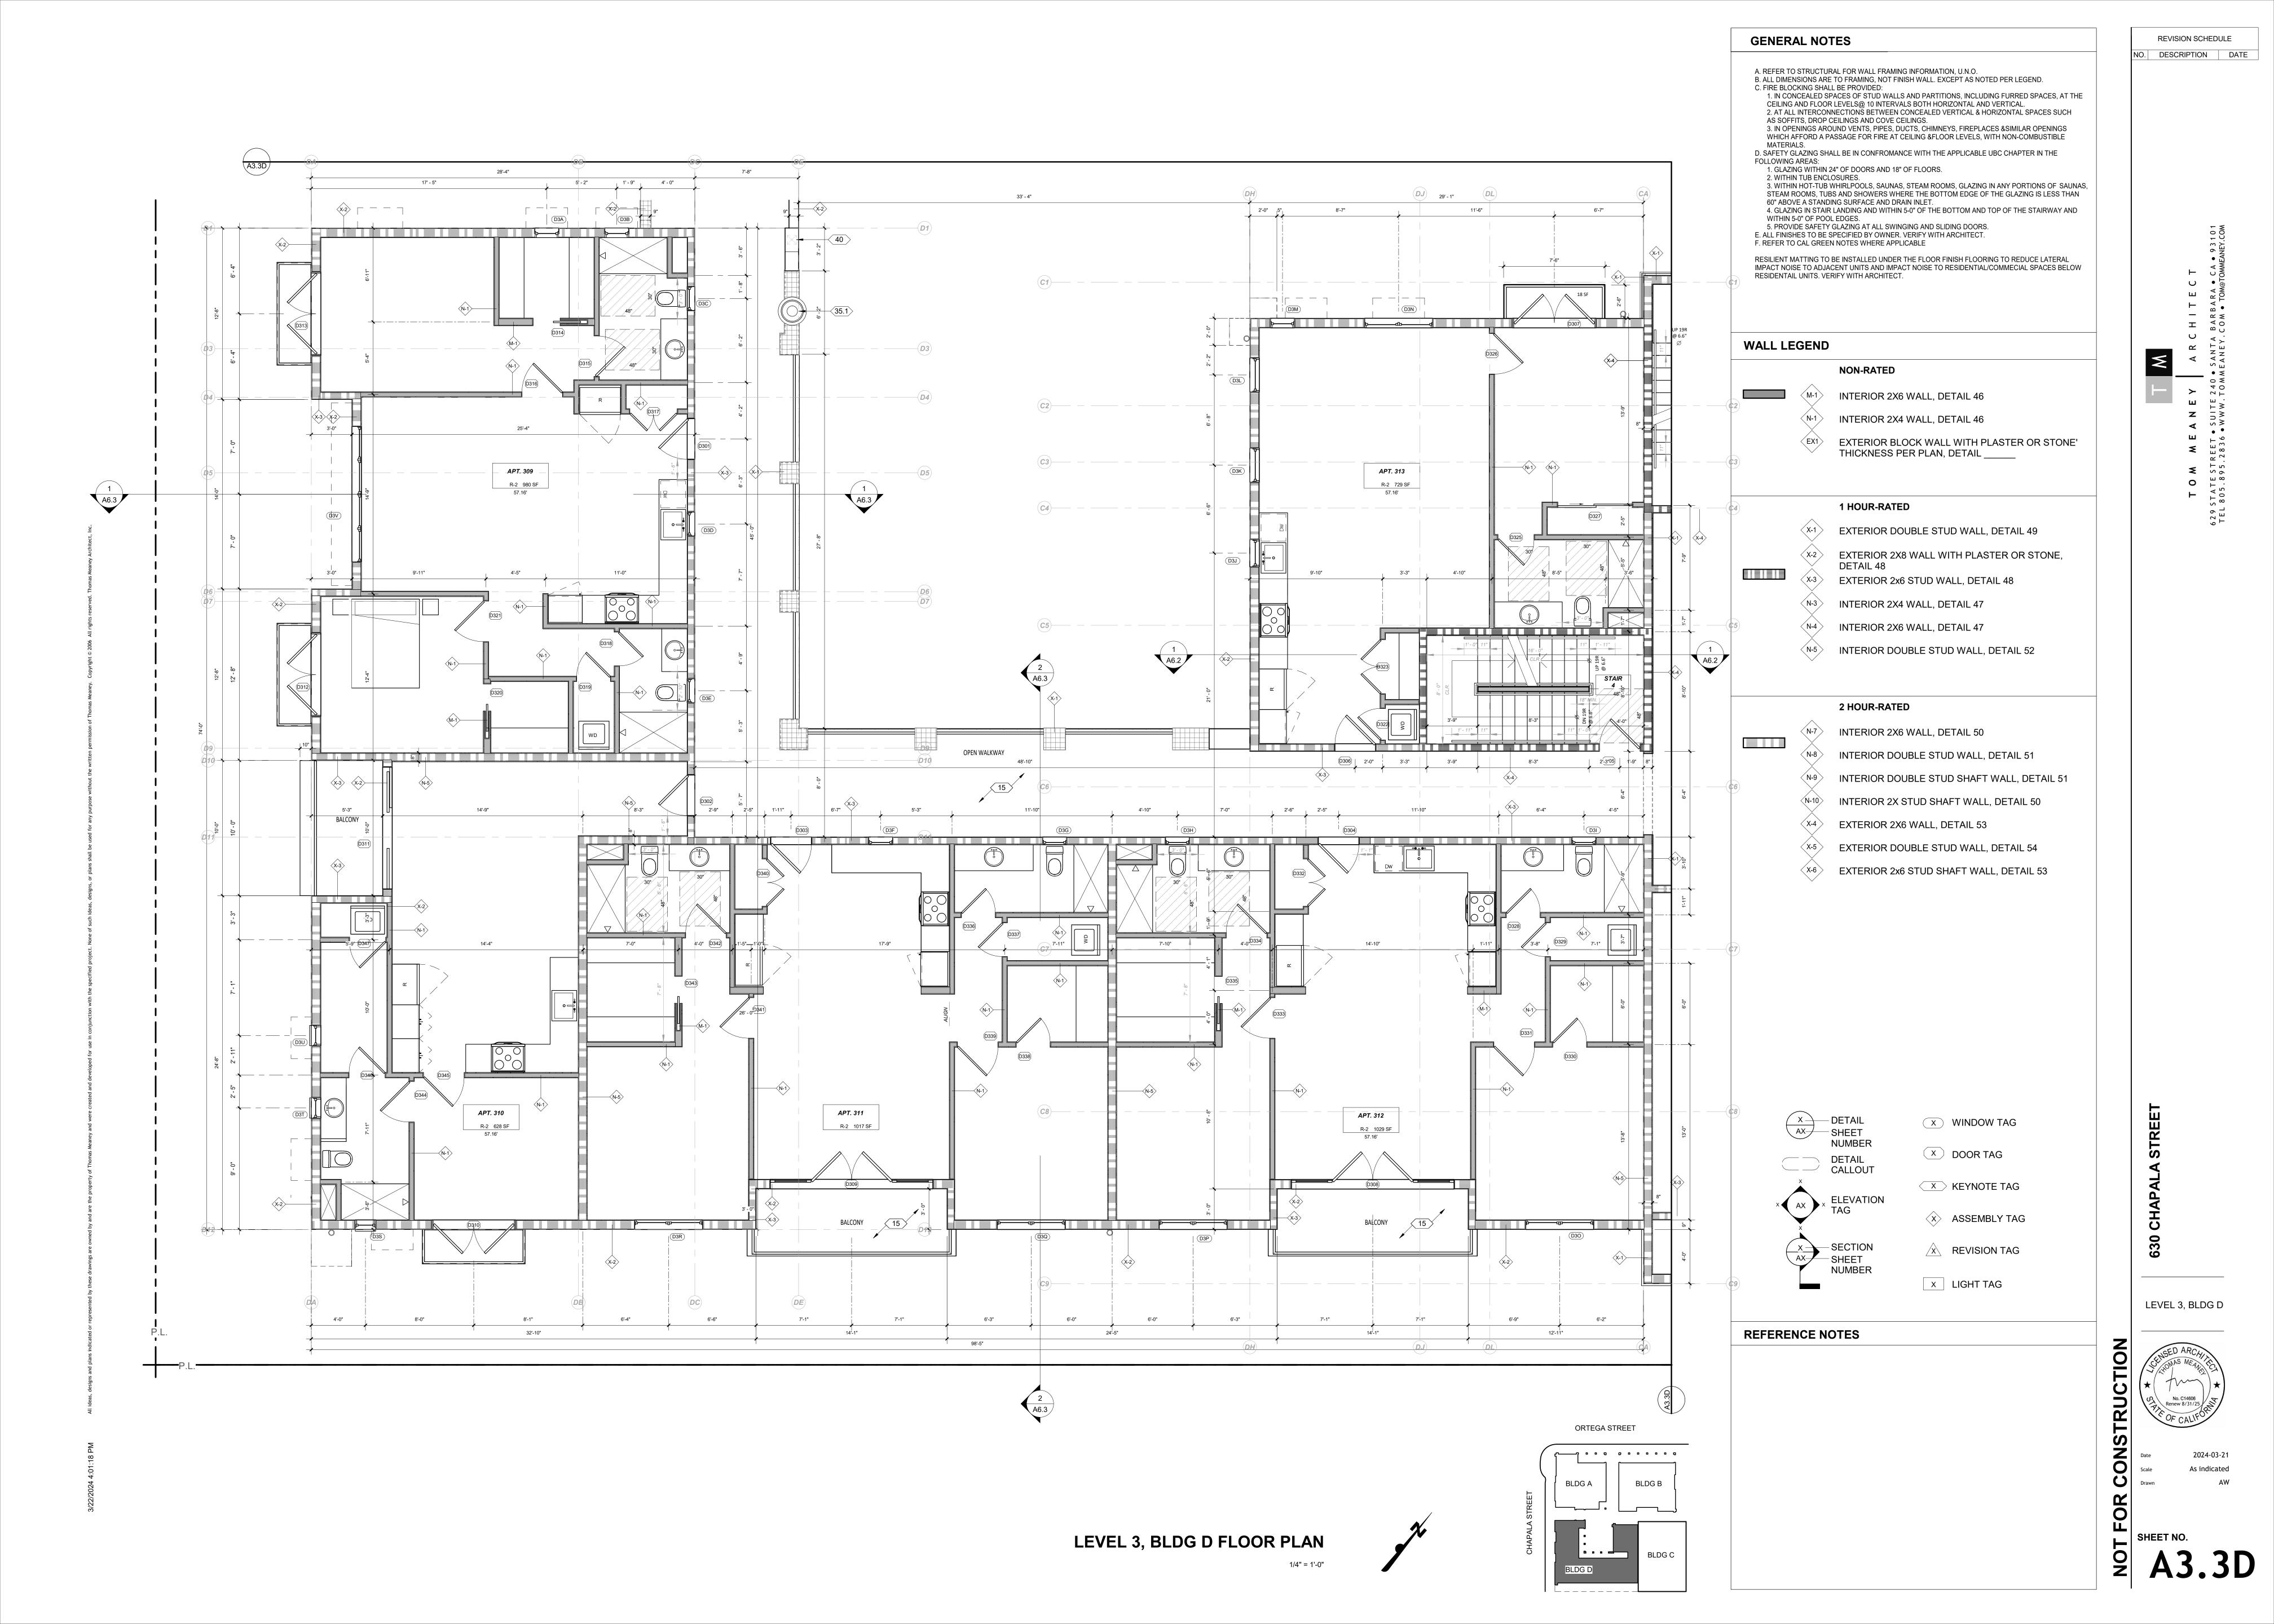

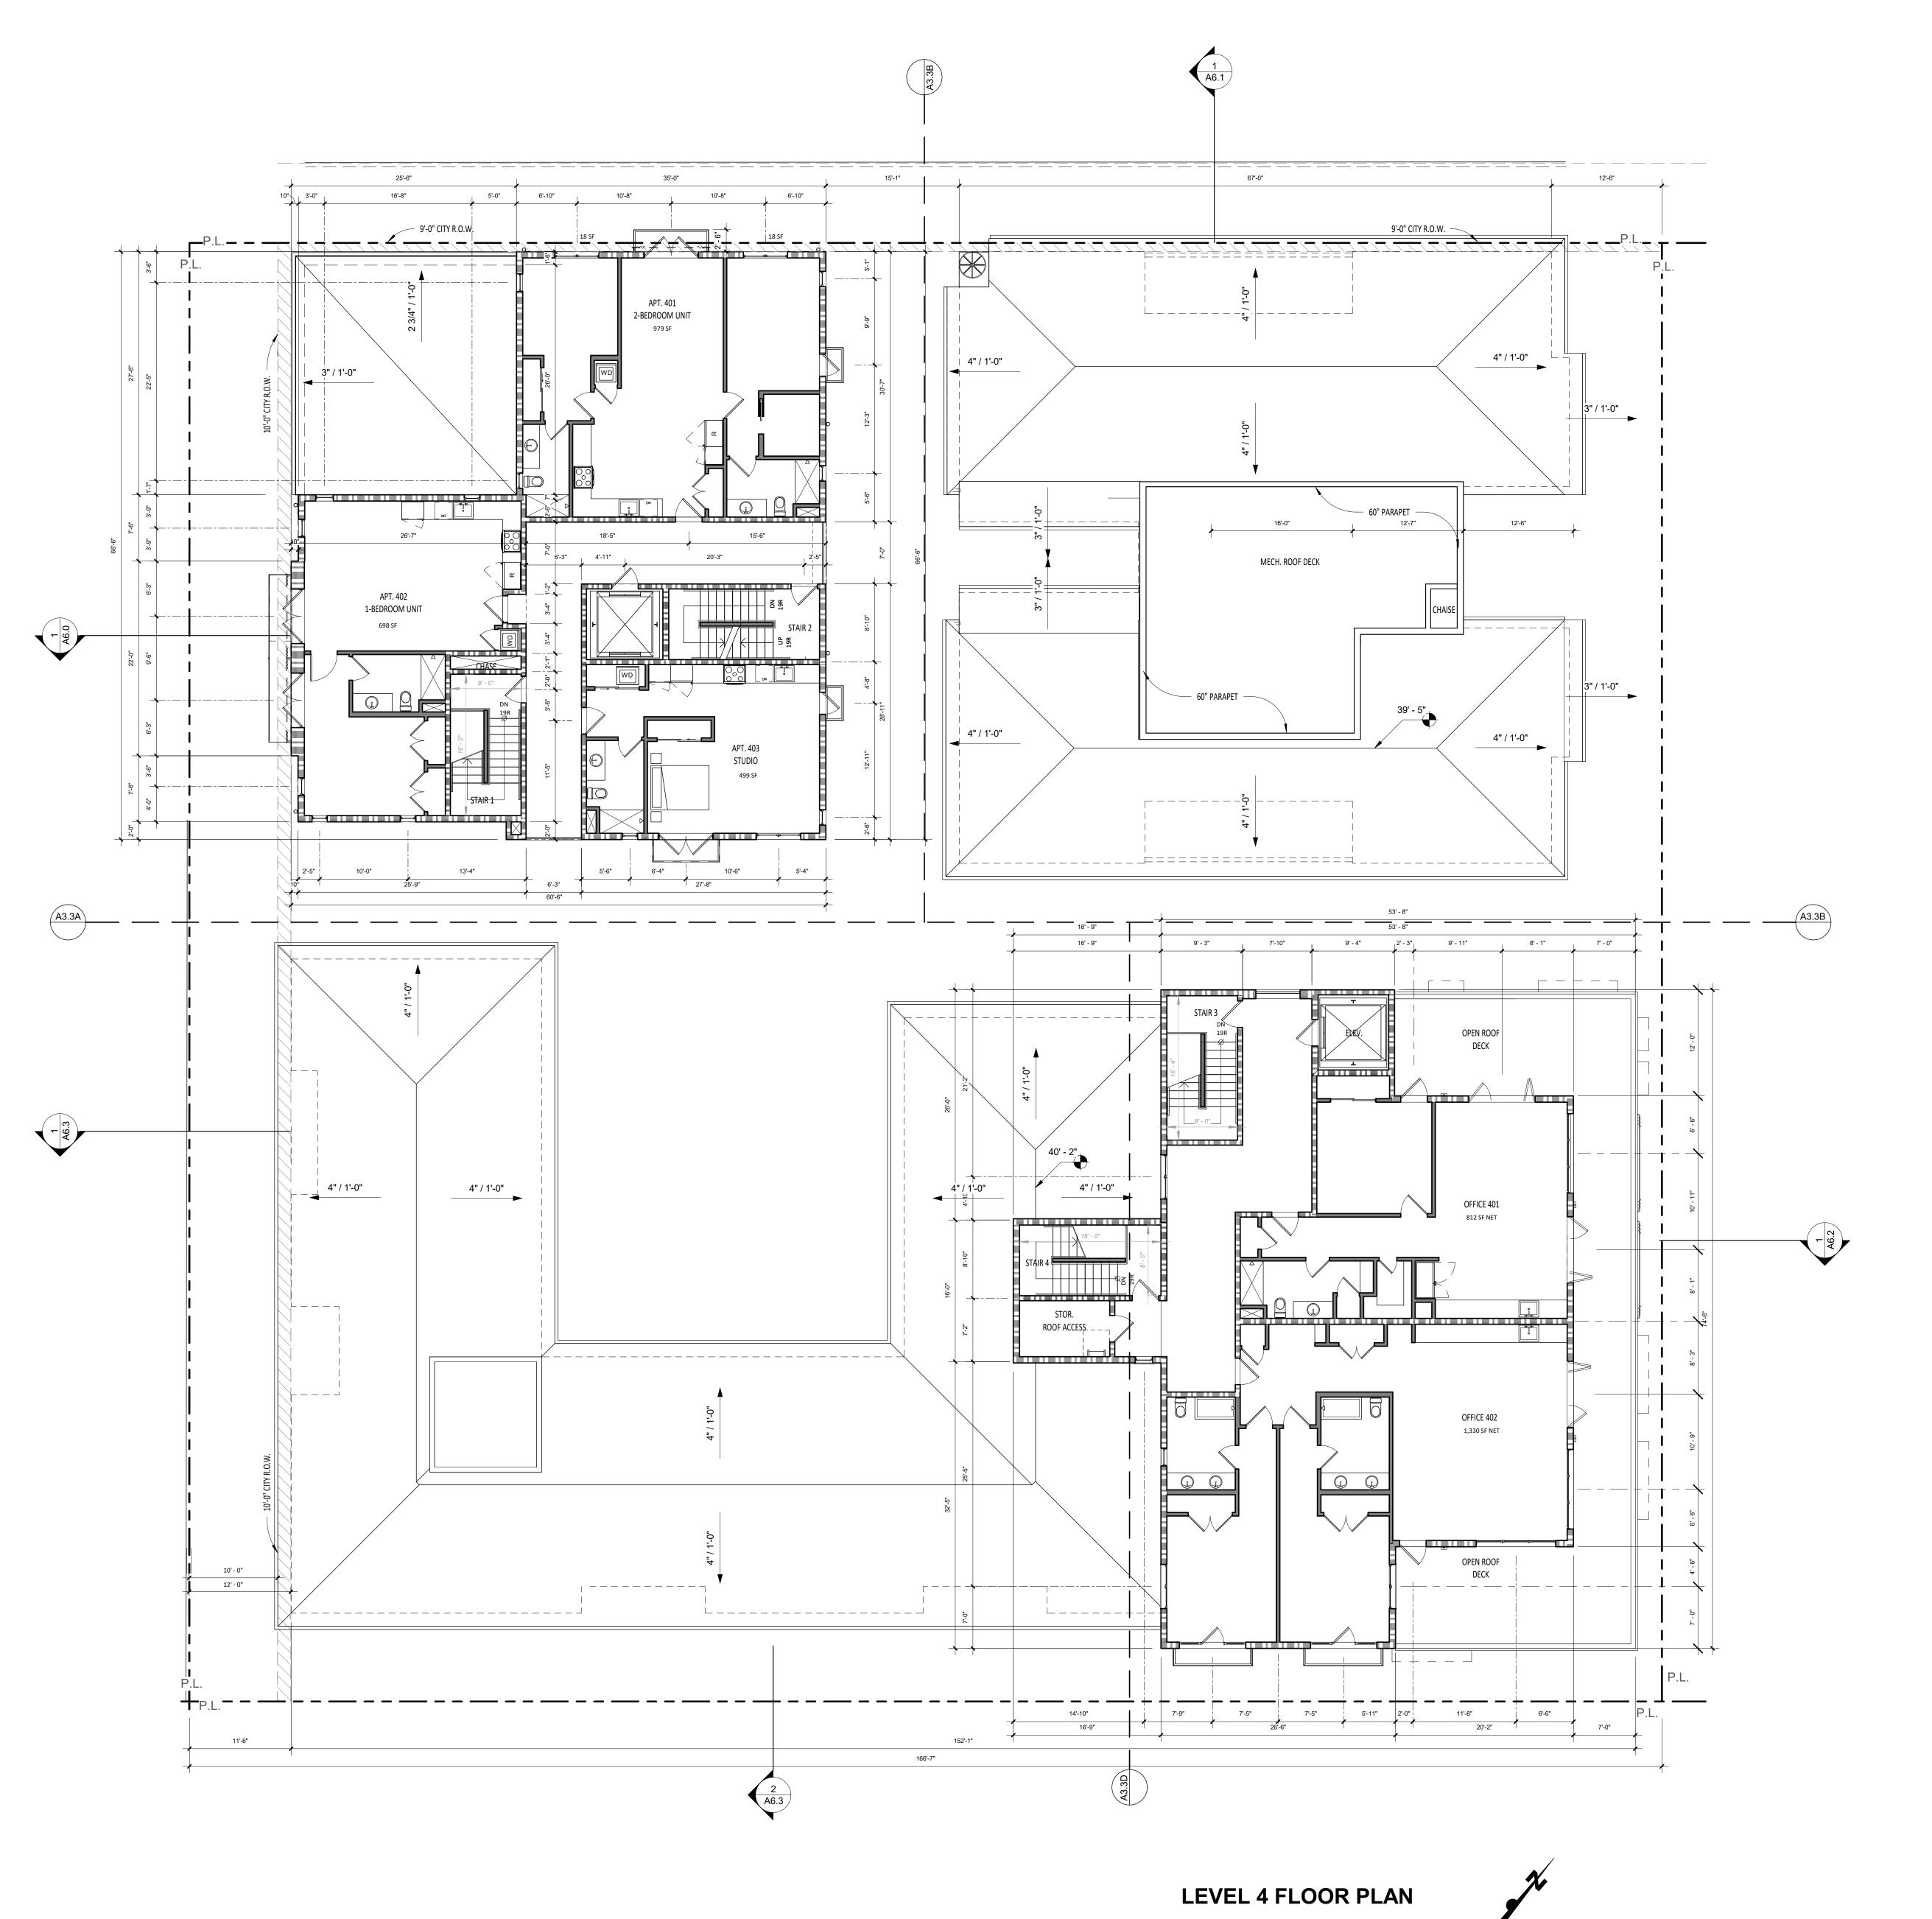


A. REFER TO STRUCTURAL FOR WALL FRAMING INFORMATION, U.N.O. B. ALL DIMENSIONS ARE TO FRAMING, NOT FINISH WALL. EXCEPT AS NOTED PER LEGEND. C. FIRE BLOCKING SHALL BE PROVIDED: 1. IN CONCEALED SPACES OF STUD WALLS AND PARTITIONS, INCLUDING FURRED SPACES, AT THE CEILING AND FLOOR LEVELS@ 10 INTERVALS BOTH HORIZONTAL AND VERTICAL. 2. AT ALL INTERCONNECTIONS BETWEEN CONCEALED VERTICAL & HORIZONTAL SPACES SUCH AS SOFFITS, DROP CEILINGS AND COVE CEILINGS. 3. IN OPENINGS AROUND VENTS, PIPES, DUCTS, CHIMNEYS, FIREPLACES & SIMILAR OPENINGS WHICH AFFORD A PASSAGE FOR FIRE AT CEILING &FLOOR LEVELS, WITH NON-COMBUSTIBLE MATERIALS. D. SAFETY GLAZING SHALL BE IN CONFROMANCE WITH THE APPLICABLE UBC CHAPTER IN THE FOLLOWING AREAS: 1. GLAZING WITHIN 24" OF DOORS AND 18" OF FLOORS. 2. WITHIN TUB ENCLOSURES. 3. WITHIN HOT-TUB WHIRLPOOLS, SAUNAS, STEAM ROOMS, GLAZING IN ANY PORTIONS OF SAUNAS, STEAM ROOMS, TUBS AND SHOWERS WHERE THE BOTTOM EDGE OF THE GLAZING IS LESS THAN 60" ABOVE A STANDING SURFACE AND DRAIN INLET. 4. GLAZING IN STAIR LANDING AND WITHIN 5-0" OF THE BOTTOM AND TOP OF THE STAIRWAY AND WITHIN 5-0" OF POOL EDGES. 5. PROVIDE SAFETY GLAZING AT ALL SWINGING AND SLIDING DOORS. E. ALL FINISHES TO BE SPECIFIED BY OWNER. VERIFY WITH ARCHITECT. F. REFER TO CAL GREEN NOTES WHERE APPLICABLE RESILIENT MATTING TO BE INSTALLED UNDER THE FLOOR FINISH FLOORING TO REDUCE LATERAL IMPACT NOISE TO ADJACENT UNITS AND IMPACT NOISE TO RESIDENTIAL/COMMECIAL SPACES BELOW RESIDENTAIL UNITS. VERIFY WITH ARCHITECT. **WALL LEGEND NON-RATED** INTERIOR 2X6 WALL, DETAIL 46 INTERIOR 2X4 WALL, DETAIL 46 EXTERIOR BLOCK WALL WITH PLASTER OR STONE' THICKNESS PER PLAN, DETAIL ___ 1 HOUR-RATED EXTERIOR DOUBLE STUD WALL, DETAIL 49 EXTERIOR 2X8 WALL WITH PLASTER OR STONE, EXTERIOR 2x6 STUD WALL, DETAIL 48 INTERIOR 2X4 WALL, DETAIL 47 INTERIOR 2X6 WALL, DETAIL 47 INTERIOR DOUBLE STUD WALL, DETAIL 52 2 HOUR-RATED INTERIOR 2X6 WALL, DETAIL 50 INTERIOR DOUBLE STUD WALL, DETAIL 51 INTERIOR DOUBLE STUD SHAFT WALL, DETAIL 51 INTERIOR 2X STUD SHAFT WALL, DETAIL 50 EXTERIOR 2X6 WALL, DETAIL 53 EXTERIOR DOUBLE STUD WALL, DETAIL 54 EXTERIOR 2x6 STUD SHAFT WALL, DETAIL 53 X WINDOW TAG X DOOR TAG DETAIL CALLOUT X KEYNOTE TAG × ELEVATION X ASSEMBLY TAG REVISION TAG -SHEET NUMBER X LIGHT TAG **REFERENCE NOTES**

GENERAL NOTES

REVISION SCHEDULE NO. DESCRIPTION DATE

OVERALL FOURTH FLOOR AND ROOF **DECK PLANS**

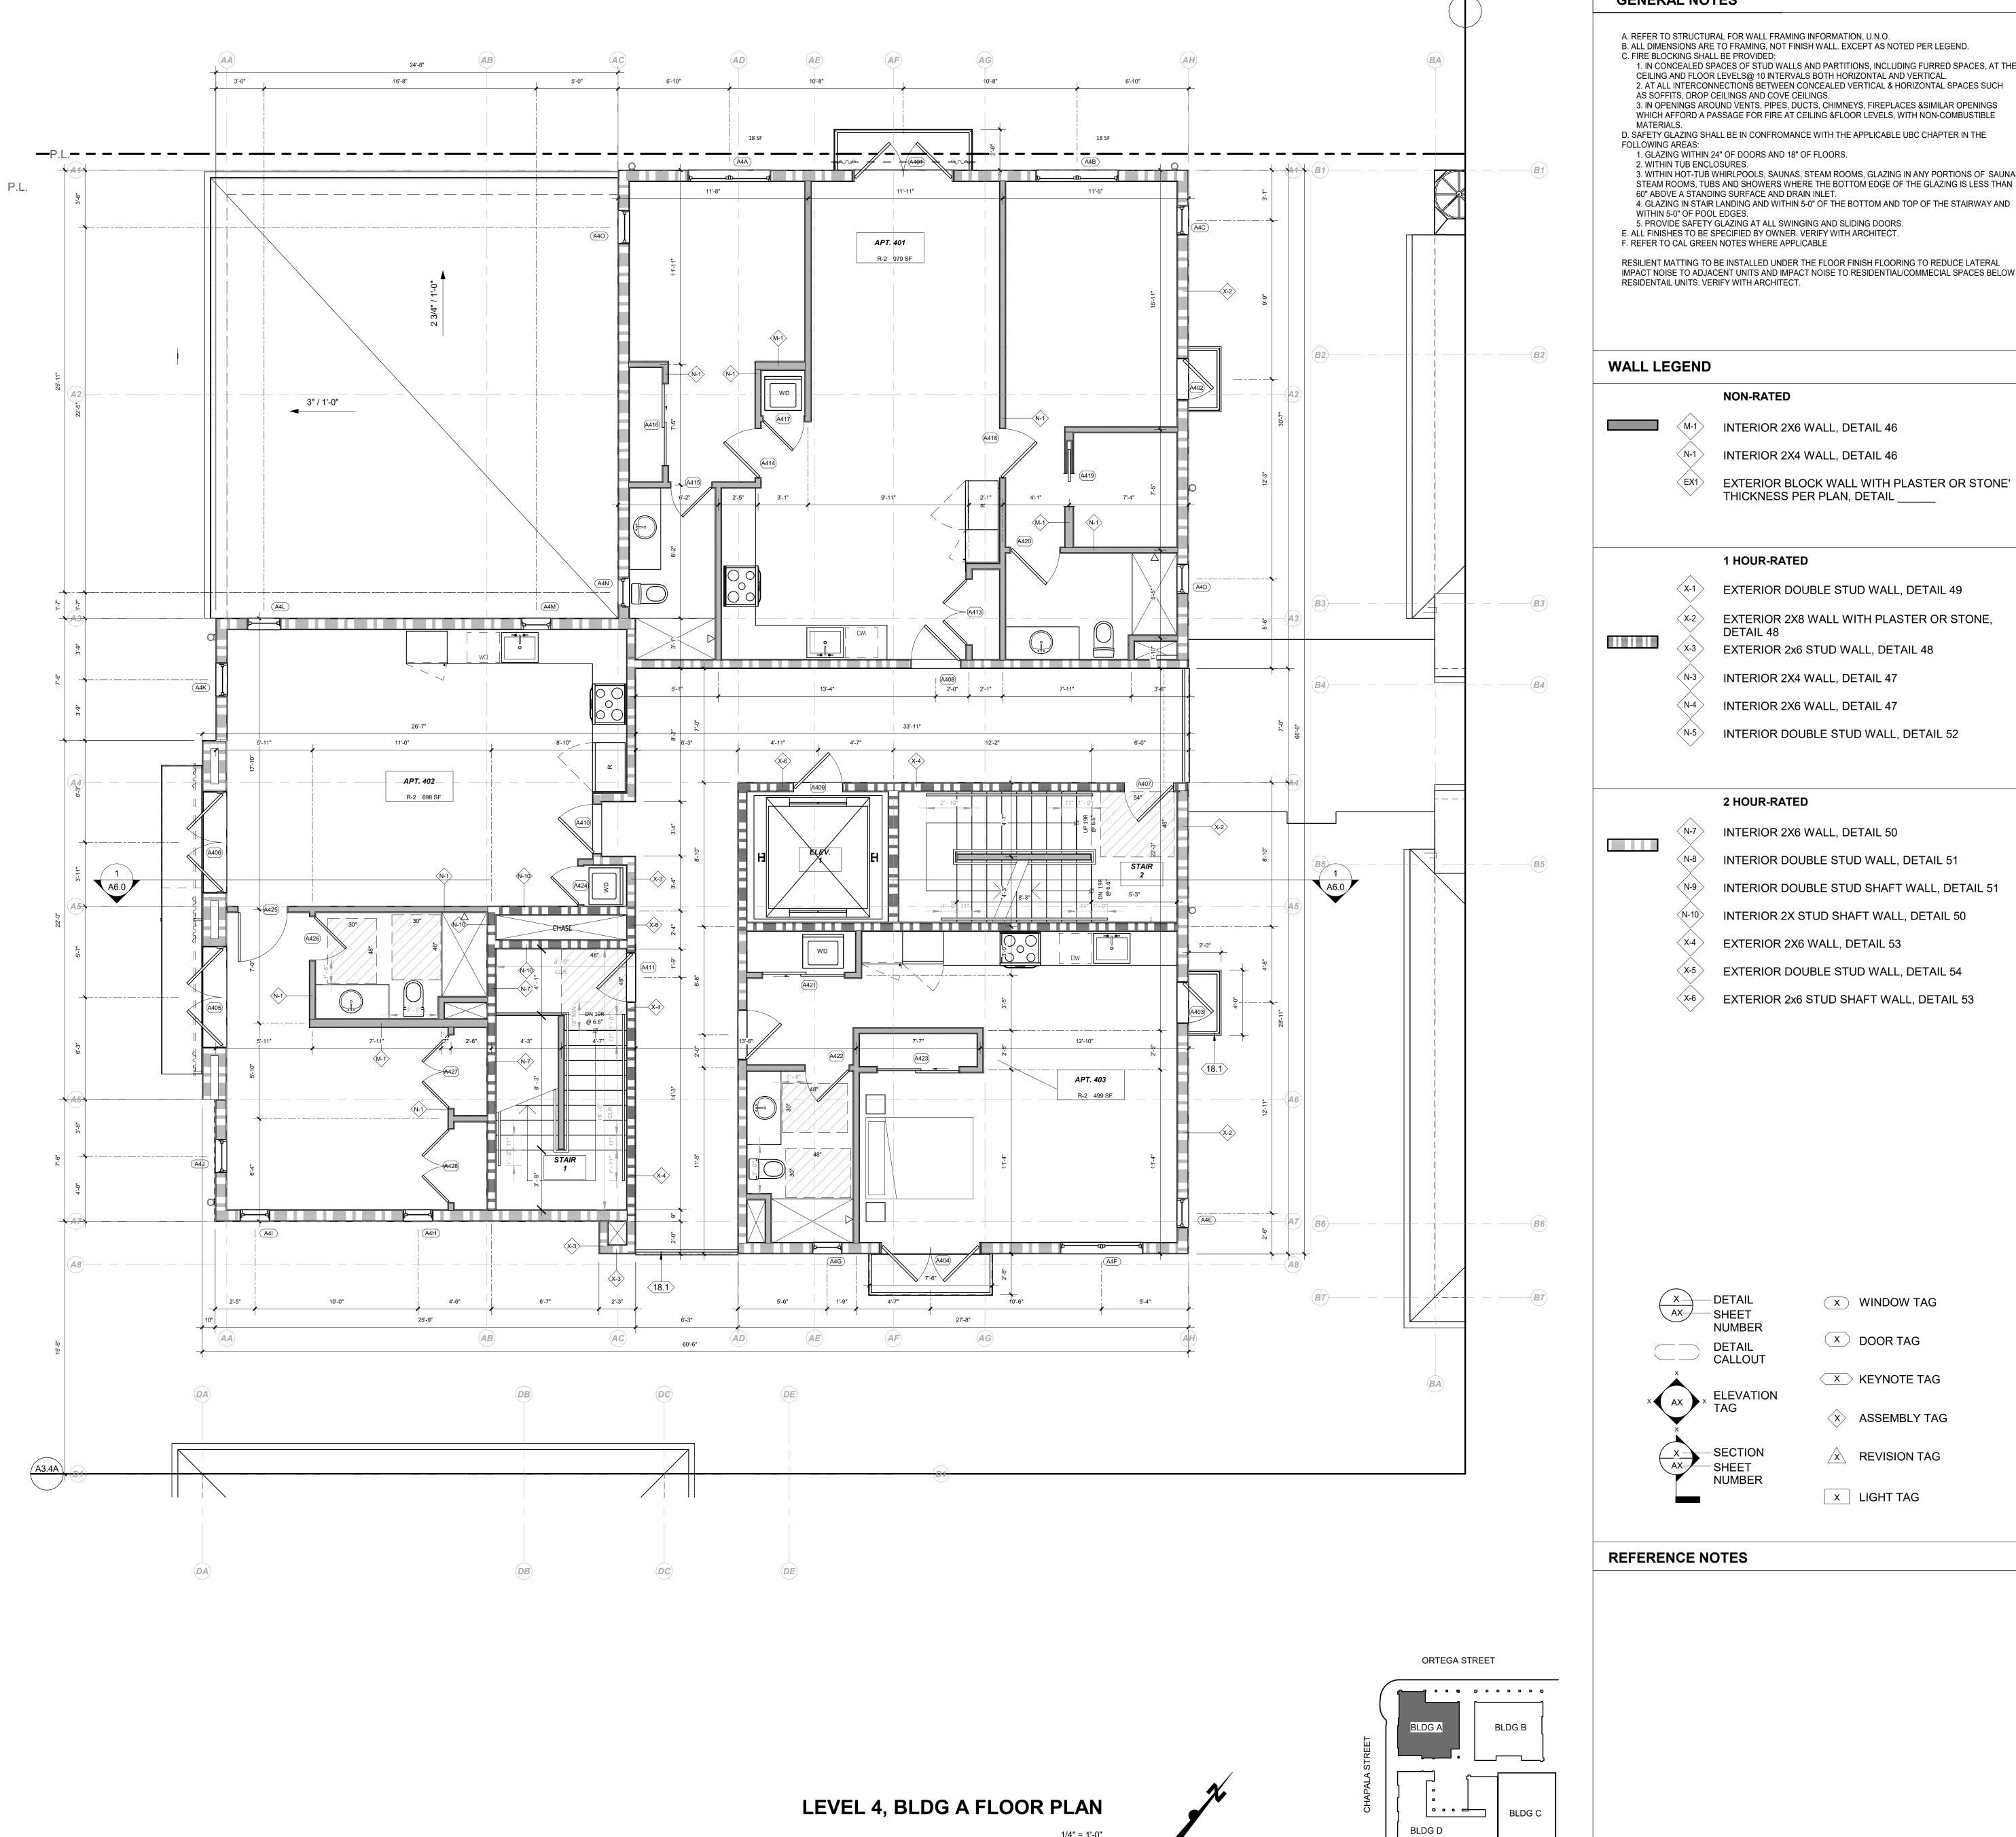

REVISION SCHEDULE **GENERAL NOTES** NO. DESCRIPTION DATE A. REFER TO STRUCTURAL FOR WALL FRAMING INFORMATION, U.N.O. B. ALL DIMENSIONS ARE TO FRAMING, NOT FINISH WALL. EXCEPT AS NOTED PER LEGEND. C. FIRE BLOCKING SHALL BE PROVIDED: IN CONCEALED SPACES OF STUD WALLS AND PARTITIONS, INCLUDING FURRED SPACES, AT THE CEILING AND FLOOR LEVELS@ 10 INTERVALS BOTH HORIZONTAL AND VERTICAL. 2. AT ALL INTERCONNECTIONS BETWEEN CONCEALED VERTICAL & HORIZONTAL SPACES SUCH AS SOFFITS, DROP CEILINGS AND COVE CEILINGS. 3. IN OPENINGS AROUND VENTS, PIPES, DUCTS, CHIMNEYS, FIREPLACES & SIMILAR OPENINGS WHICH AFFORD A PASSAGE FOR FIRE AT CEILING &FLOOR LEVELS, WITH NON-COMBUSTIBLE D. SAFETY GLAZING SHALL BE IN CONFROMANCE WITH THE APPLICABLE UBC CHAPTER IN THE 1. GLAZING WITHIN 24" OF DOORS AND 18" OF FLOORS. 3. WITHIN HOT-TUB WHIRLPOOLS, SAUNAS, STEAM ROOMS, GLAZING IN ANY PORTIONS OF SAUNAS, STEAM ROOMS, TUBS AND SHOWERS WHERE THE BOTTOM EDGE OF THE GLAZING IS LESS THAN

F. REFER TO CAL GREEN NOTES WHERE APPLICABLE RESILIENT MATTING TO BE INSTALLED UNDER THE FLOOR FINISH FLOORING TO REDUCE LATERAL IMPACT NOISE TO ADJACENT UNITS AND IMPACT NOISE TO RESIDENTIAL/COMMECIAL SPACES BELOW RESIDENTAIL UNITS. VERIFY WITH ARCHITECT.

INTERIOR 2X6 WALL, DETAIL 46

INTERIOR 2X4 WALL, DETAIL 46 EXTERIOR BLOCK WALL WITH PLASTER OR STONE' THICKNESS PER PLAN, DETAIL ___

1 HOUR-RATED

EXTERIOR DOUBLE STUD WALL, DETAIL 49

EXTERIOR 2X8 WALL WITH PLASTER OR STONE, EXTERIOR 2x6 STUD WALL, DETAIL 48

INTERIOR 2X4 WALL, DETAIL 47

INTERIOR 2X6 WALL, DETAIL 47

INTERIOR DOUBLE STUD WALL, DETAIL 52

2 HOUR-RATED

INTERIOR 2X6 WALL, DETAIL 50

INTERIOR DOUBLE STUD WALL, DETAIL 51

INTERIOR DOUBLE STUD SHAFT WALL, DETAIL 51

INTERIOR 2X STUD SHAFT WALL, DETAIL 50

EXTERIOR 2X6 WALL, DETAIL 53

EXTERIOR DOUBLE STUD WALL, DETAIL 54

EXTERIOR 2x6 STUD SHAFT WALL, DETAIL 53

SHEET DETAIL CALLOUT X WINDOW TAG X DOOR TAG

X KEYNOTE TAG


ASSEMBLY TAG


REVISION TAG


X LIGHT TAG

REFERENCE NOTES

LEVEL 4, BLDG A

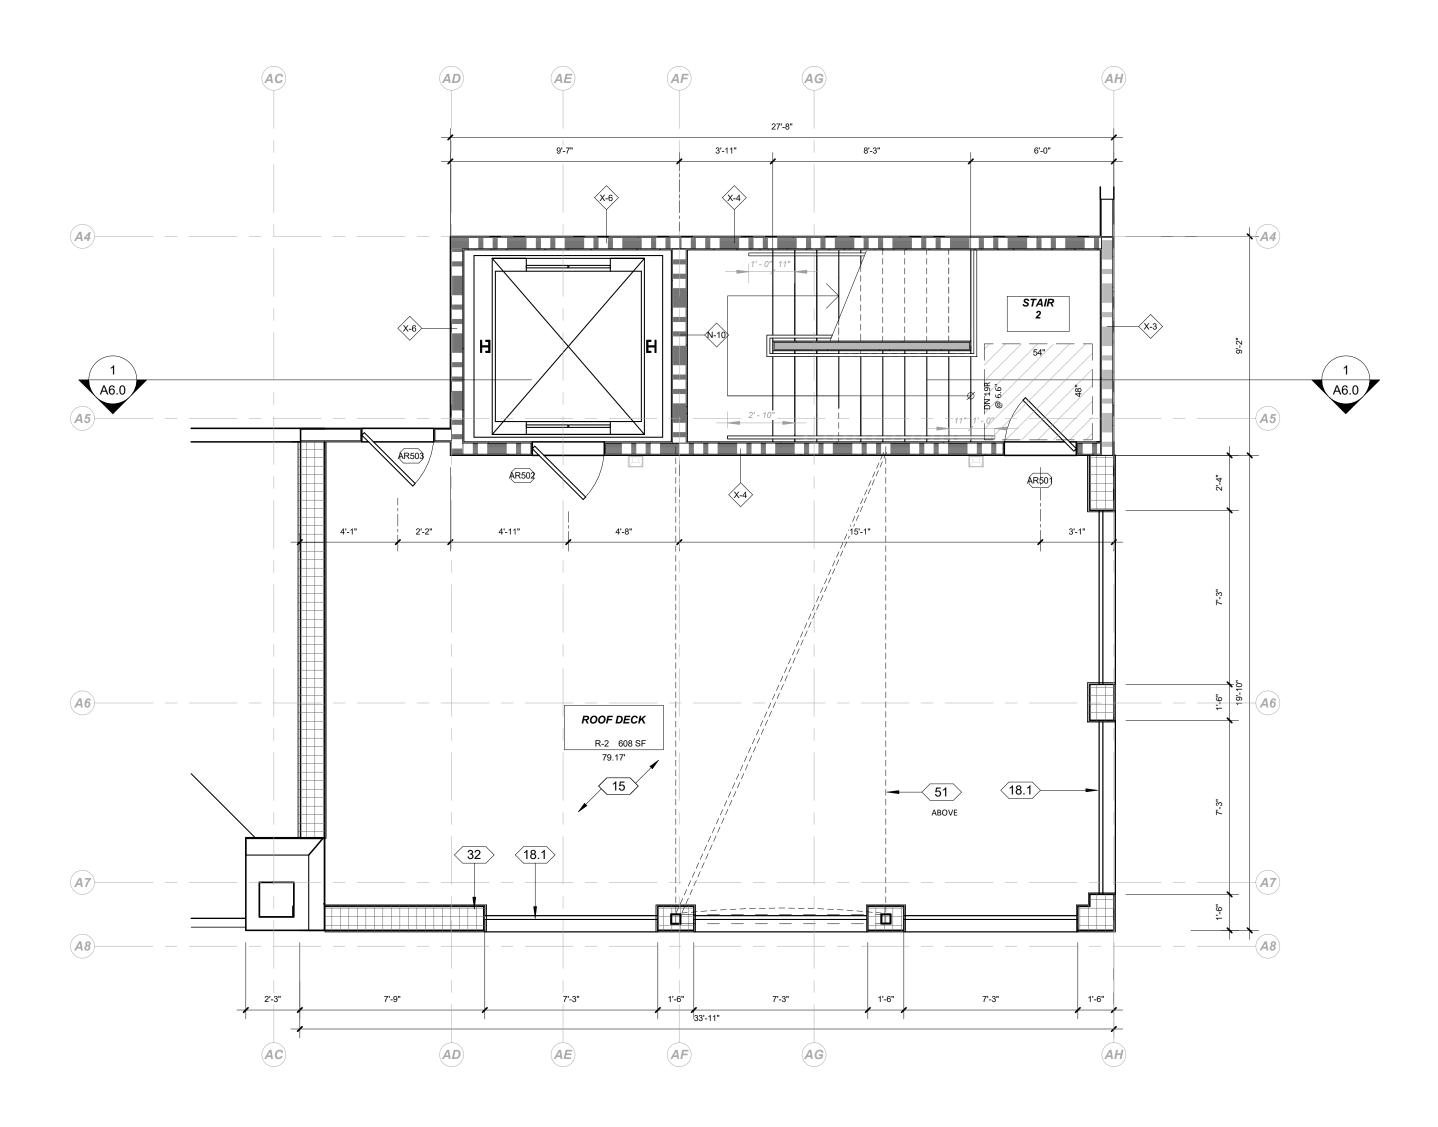

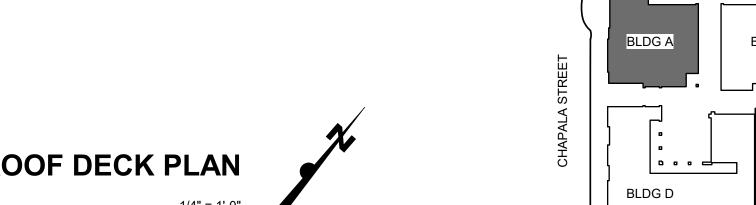

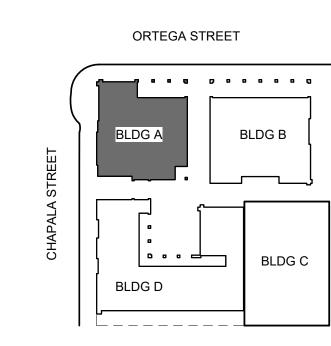

GENERAL NOTES REVISION SCHEDULE NO. DESCRIPTION DATE A. REFER TO STRUCTURAL FOR WALL FRAMING INFORMATION, U.N.O. B. ALL DIMENSIONS ARE TO FRAMING, NOT FINISH WALL. EXCEPT AS NOTED PER LEGEND. C. FIRE BLOCKING SHALL BE PROVIDED:

2. AT ALL INTERCONNECTIONS BETWEEN CONCEALED VERTICAL & HORIZONTAL SPACES SUCH AS SOFFITS, DROP CEILINGS AND COVE CEILINGS. 3. IN OPENINGS AROUND VENTS, PIPES, DUCTS, CHIMNEYS, FIREPLACES &SIMILAR OPENINGS WHICH AFFORD A PASSAGE FOR FIRE AT CEILING &FLOOR LEVELS, WITH NON-COMBUSTIBLE D. SAFETY GLAZING SHALL BE IN CONFROMANCE WITH THE APPLICABLE UBC CHAPTER IN THE FOLLOWING AREAS: 1. GLAZING WITHIN 24" OF DOORS AND 18" OF FLOORS. 2. WITHIN TUB ENCLOSURES.

1. IN CONCEALED SPACES OF STUD WALLS AND PARTITIONS, INCLUDING FURRED SPACES, AT THE CEILING AND FLOOR LEVELS@ 10 INTERVALS BOTH HORIZONTAL AND VERTICAL.

3. WITHIN HOT-TUB WHIRLPOOLS, SAUNAS, STEAM ROOMS, GLAZING IN ANY PORTIONS OF SAUNAS, STEAM ROOMS, TUBS AND SHOWERS WHERE THE BOTTOM EDGE OF THE GLAZING IS LESS THAN 60" ABOVE A STANDING SURFACE AND DRAIN INLET. 4. GLAZING IN STAIR LANDING AND WITHIN 5-0" OF THE BOTTOM AND TOP OF THE STAIRWAY AND WITHIN 5-0" OF POOL EDGES.

5. PROVIDE SAFETY GLAZING AT ALL SWINGING AND SLIDING DOORS. E. ALL FINISHES TO BE SPECIFIED BY OWNER. VERIFY WITH ARCHITECT. F. REFER TO CAL GREEN NOTES WHERE APPLICABLE

RESILIENT MATTING TO BE INSTALLED UNDER THE FLOOR FINISH FLOORING TO REDUCE LATERAL IMPACT NOISE TO ADJACENT UNITS AND IMPACT NOISE TO RESIDENTIAL/COMMECIAL SPACES BELOW RESIDENTAIL UNITS. VERIFY WITH ARCHITECT.

WALL LEGEND

NON-RATED

INTERIOR 2X6 WALL, DETAIL 46

INTERIOR 2X4 WALL, DETAIL 46

EXTERIOR BLOCK WALL WITH PLASTER OR STONE' THICKNESS PER PLAN, DETAIL _____

1 HOUR-RATED

EXTERIOR DOUBLE STUD WALL, DETAIL 49

EXTERIOR 2X8 WALL WITH PLASTER OR STONE, DETAIL 48 (X-3) EXTERIOR 2x6 STUD WALL, DETAIL 48

INTERIOR 2X4 WALL, DETAIL 47

INTERIOR 2X6 WALL, DETAIL 47

INTERIOR DOUBLE STUD WALL, DETAIL 52

2 HOUR-RATED

INTERIOR 2X6 WALL, DETAIL 50

INTERIOR DOUBLE STUD WALL, DETAIL 51

INTERIOR DOUBLE STUD SHAFT WALL, DETAIL 51

INTERIOR 2X STUD SHAFT WALL, DETAIL 50

EXTERIOR 2X6 WALL, DETAIL 53

EXTERIOR DOUBLE STUD WALL, DETAIL 54

(X-6) EXTERIOR 2x6 STUD SHAFT WALL, DETAIL 53

SHEET DETAIL CALLOUT

SECTION SHEET

× ELEVATION TAG

SHEET
NUMBER

X WINDOW TAG

X DOOR TAG X KEYNOTE TAG


ASSEMBLY TAG

REVISION TAG


X LIGHT TAG

REFERENCE NOTES

ROOF DECK, BLDG A

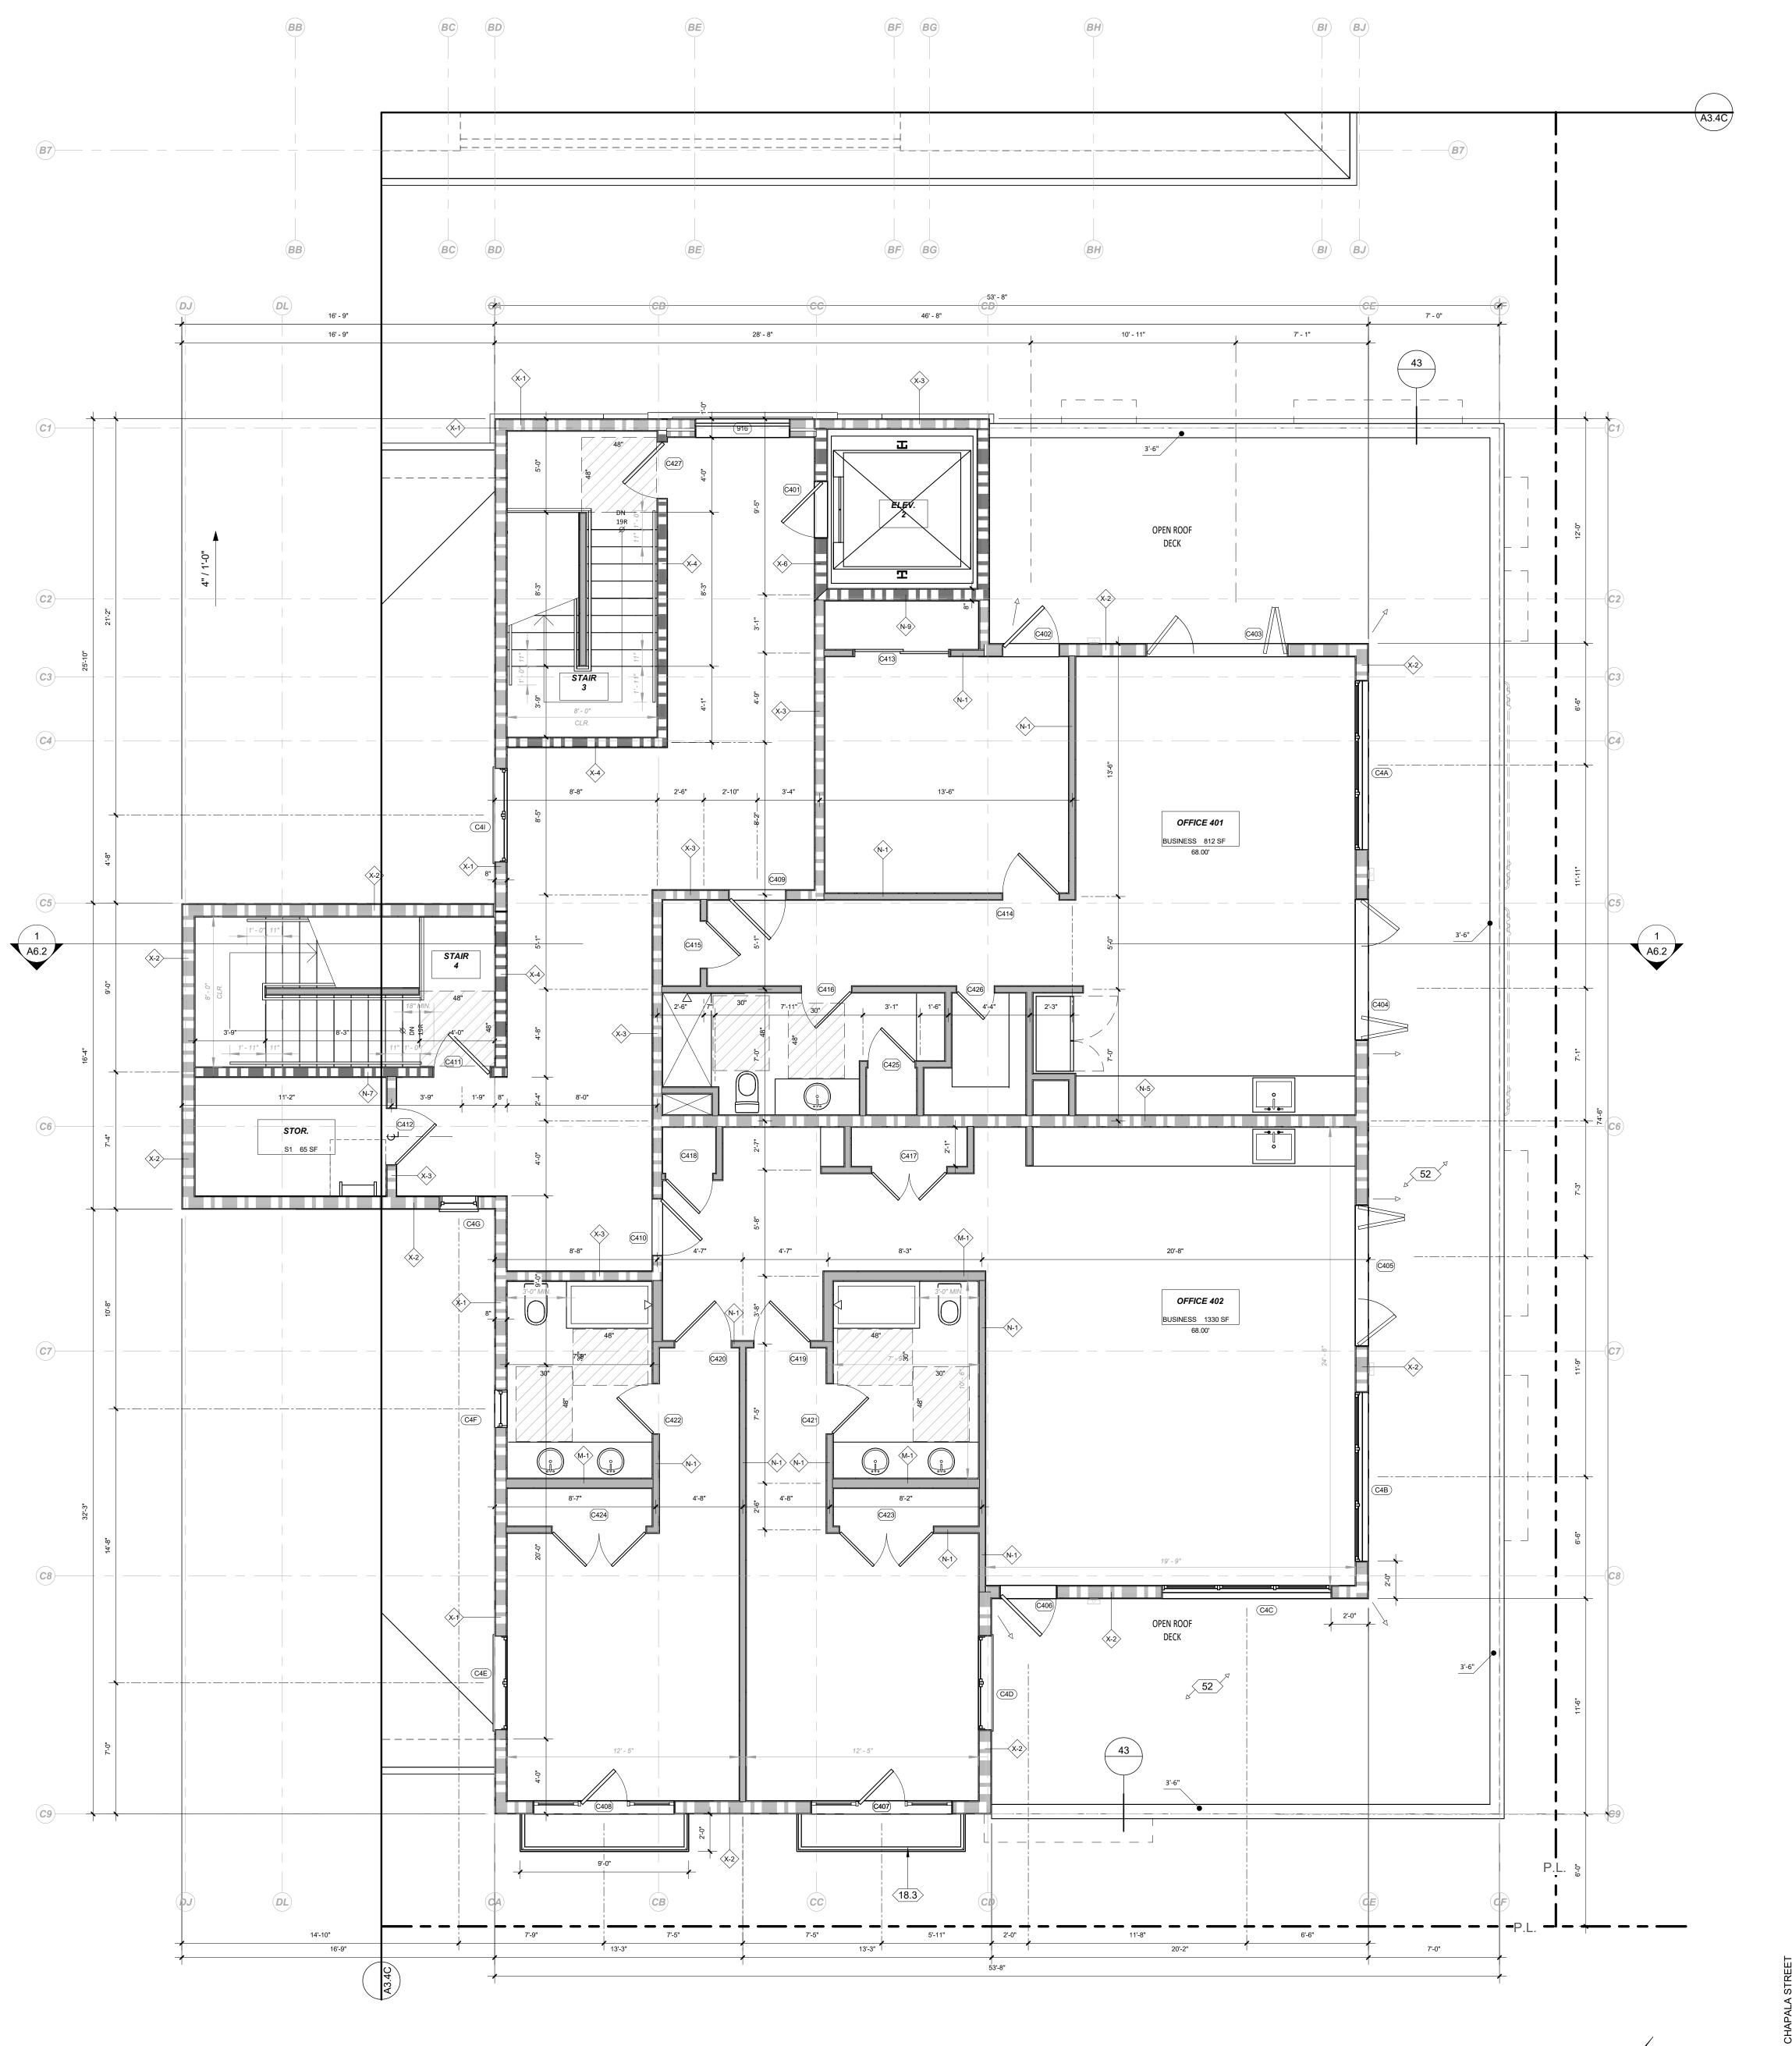

ORTEGA STREET

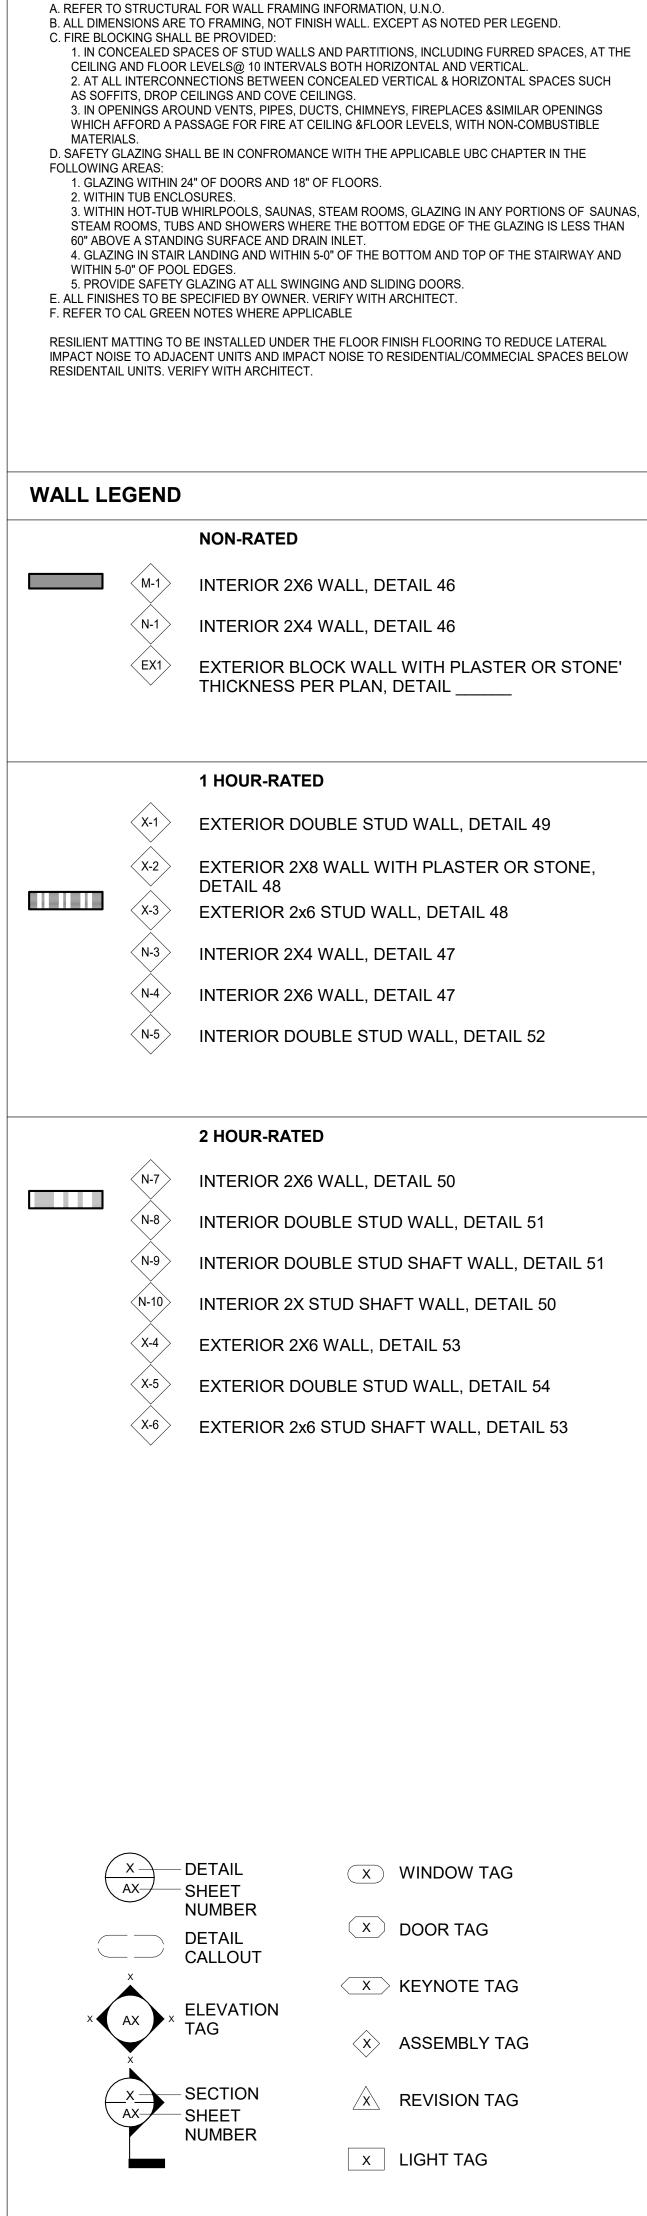

GENERAL NOTES

REFERENCE NOTES





LEVEL 4, BLDG C

REVISION SCHEDULE

NO. DESCRIPTION DATE

LEVEL 4, BLDG C FLOOR PLAN

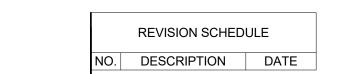

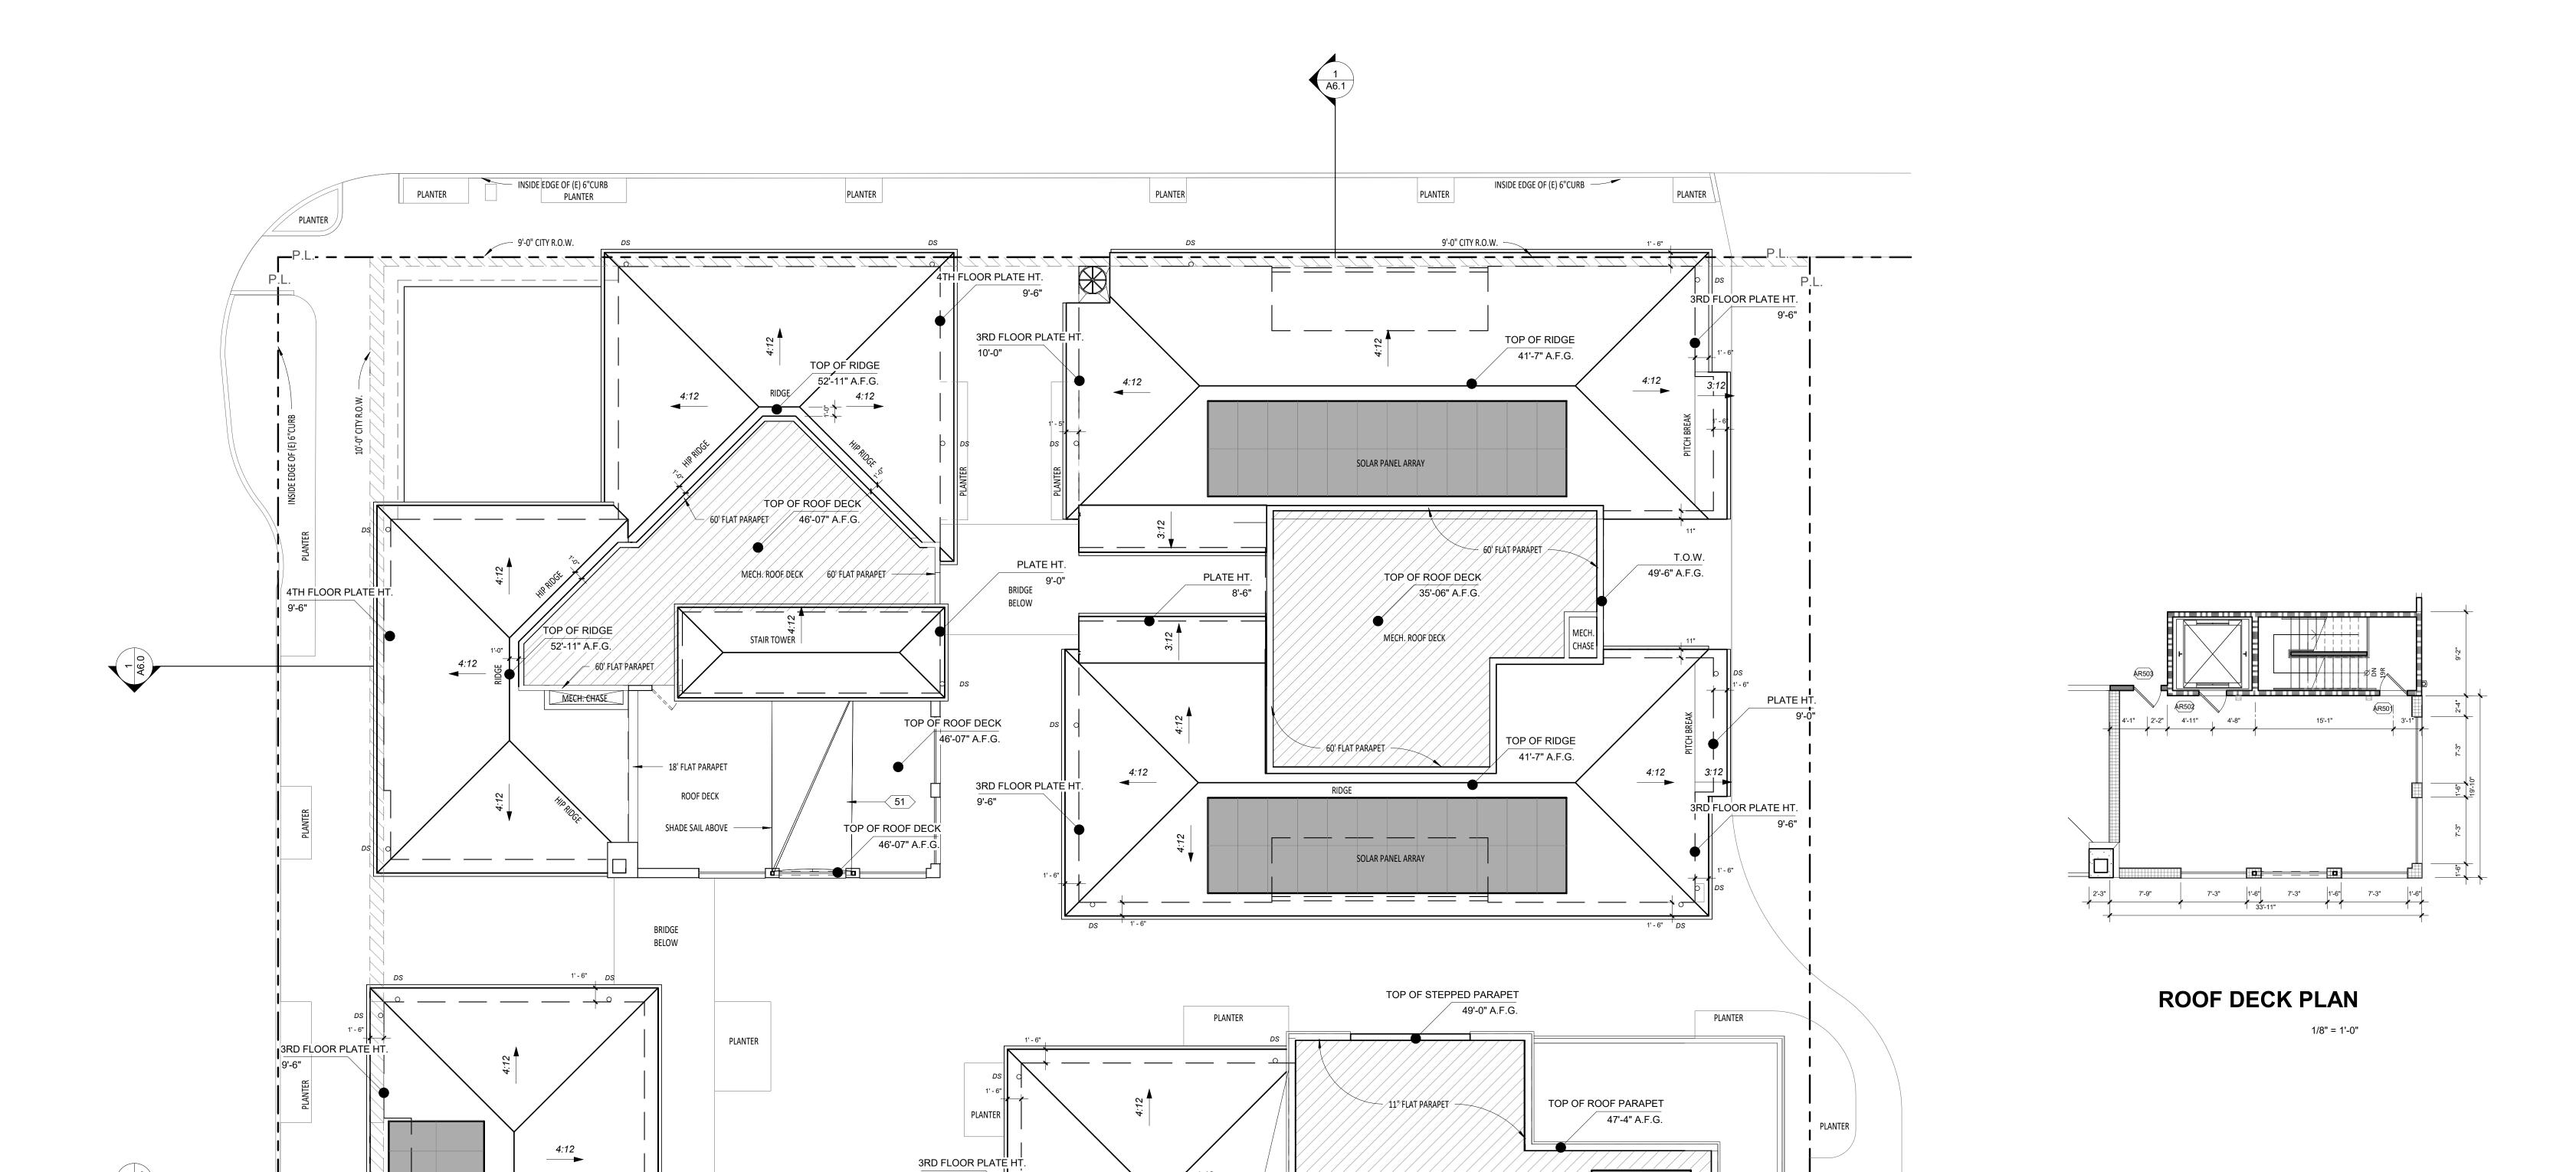

TOP OF RIDGE 41'-10" A.F.G.

-/11" FLAT PARAPET

MECH. ROOF DECK

ROOF ACCESS

PLANTER

4:12 **→**

SOLAR PANEL ARRAY

4:12 **⋖**

OPEN DECK BELOW

LINE OF WALL BELOW

TOP OF RIDGE 41'-10" A.F.G.

PLANTER

TOP OF RIDGE

41'-10" A.F.G.

4:12 **→**

14'-2"

MECH. ROOF DECK

TOP OF ROOF PARAPET

41'-10" A.F.G.

SOLAR PANEL ARRAY

630 CHAPALA STREET

OVERALL ROOF PLAN

No. C14606
Renew 8/31/25

No. C14606
Renew 8/31/25

OF CALIFORNIA

Date 2024-03-21
Scale 1/8" = 1'-0'
Drawn AW

SHEET NO.

A3.5

ROOF PLAN

1/8" = 1'-0"

MECH, ROOF DECK

TOP OF ROOF DECK

46'-6" A.F.G.


SOLAR PANEL ARRAY

— 11" FLAT PARAPET -

PLANTER


PLANTER

TOP OF ROOF PARAPET

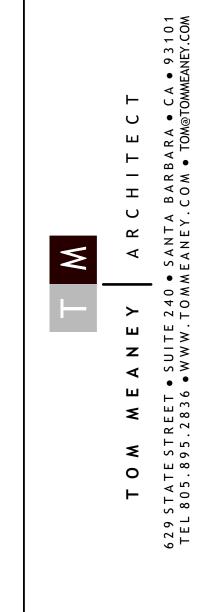



EAST ELEVATION1/8" = 1'-0"

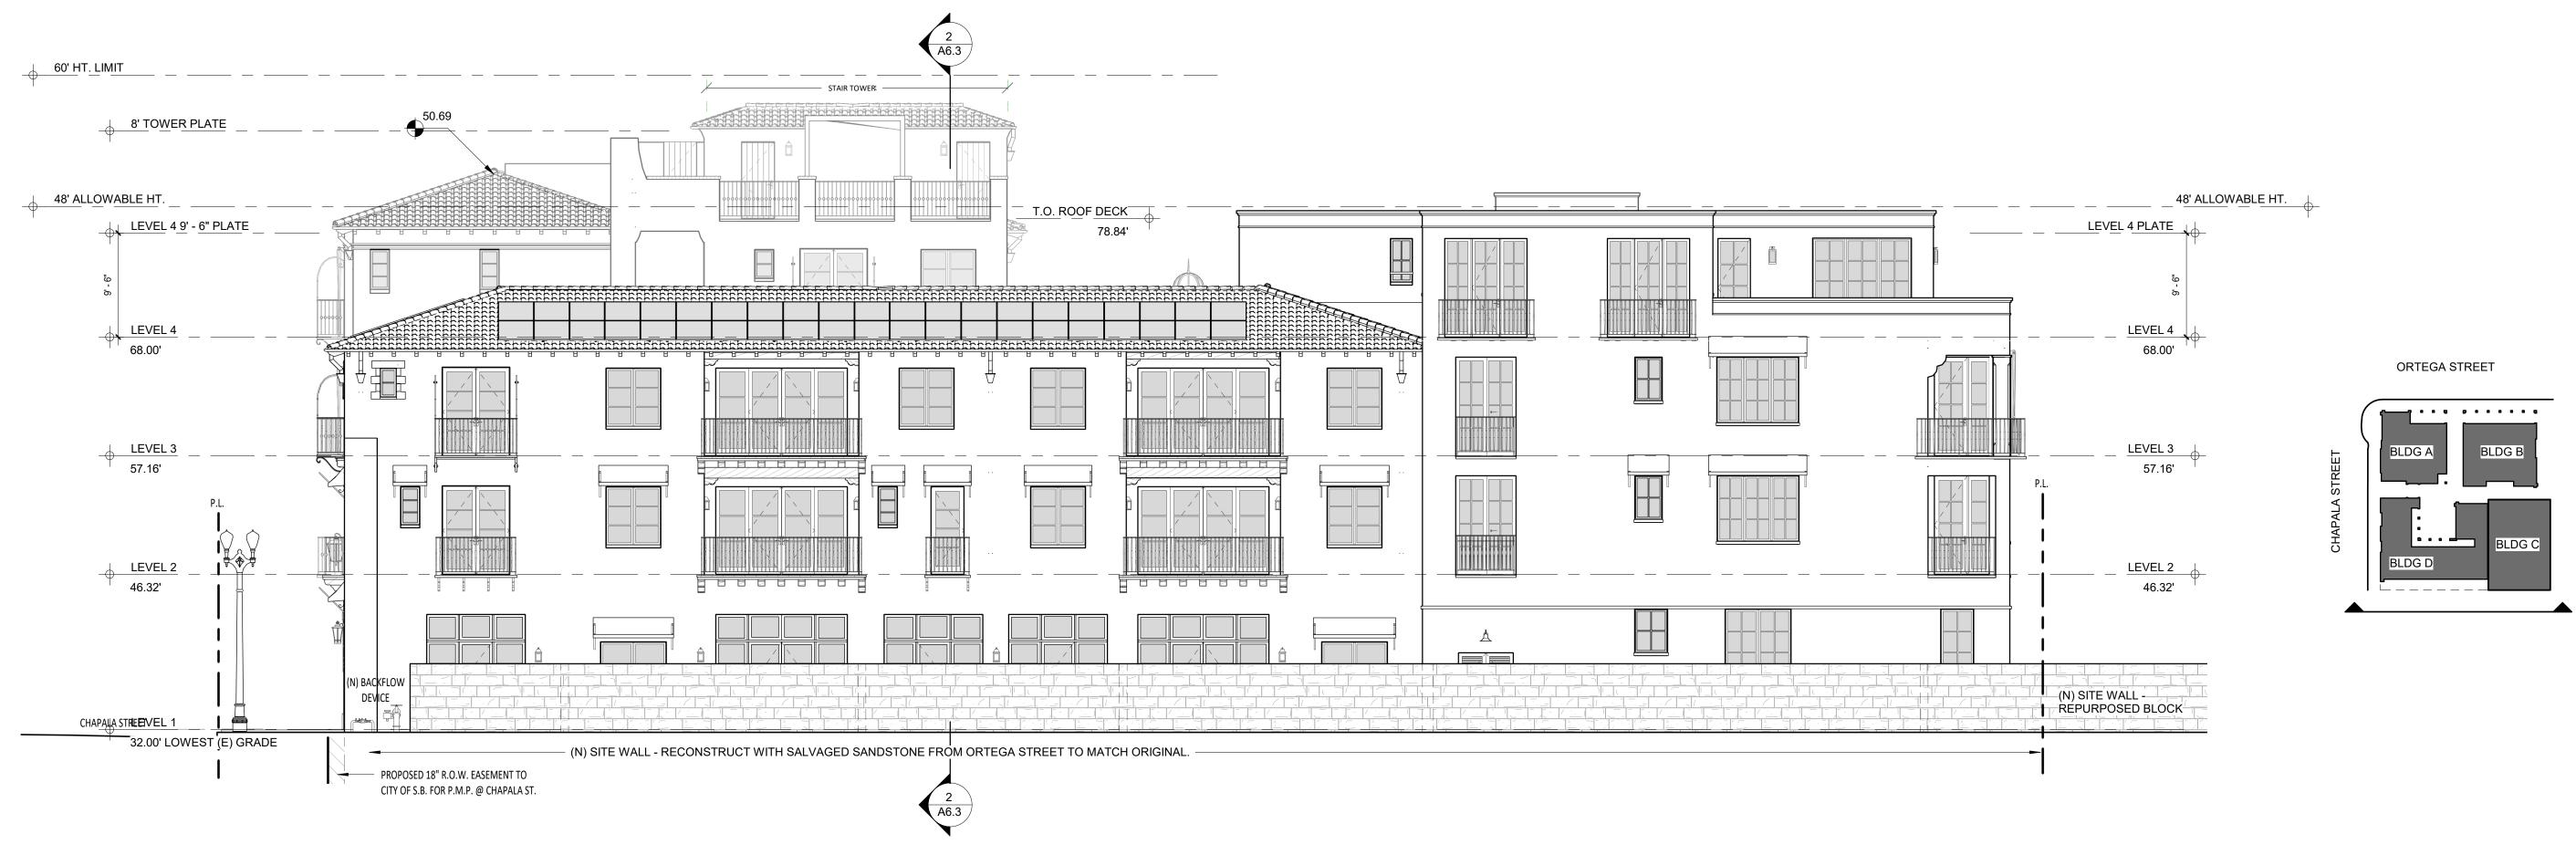

SOUTH ELEVATION

1/8" = 1'-0"

OVERALL EXTERIOR ELEVATIONS

OF CALIFORM

Date

2024-04-11

Scale

As indicated

SHEET NO.

A5.2

EXTERIOR SIGNAGE NOT SHOWN. UNDER SEPARATE PERMIT REFER TO STRUCTURAL PLANS FOR FOUNDATION AND SLAB INFORMATION

REFER TO ELECTRICAL PLANS FOR ALL EXTERIOR LIGHTING FIXTURES, NOTES AND WIRING CONTROL JOINTS NOT SHOWN BUT SHALL MEET THE FOLLOWING REQUIREMENTS NO PANELS OR SECTIONS SHALL EXCEED A SQUARE AREA OF 144 S.F.

DISTANCE BETWEEN CONTROL JOINTS SHALL NOT EXCEED 16' U.N.O. BY E.O.R. CONTROL JOINTS SHALL BE LOCATED ON BOTH SIDES OF OPENINGS LARGER THAN 6'-0"

U.N.O. BY E.O.R. CONTROL JOINTS SHALL BE LOCATED AT AT LEAST ONE SIDE OF OPENINGS SMALLER

THAN 6'-0" U.N.O. BY E.O.R. F. SEE FINISH SCHEDULE FOR COLORS AND MATERIALS 16B ARCADE LIGHTING. GLASS STAR LIGHT PENDANT. 18 POINT, 15" BY HOMETOWN EVOLUTION. CLEAR, 24" CHAIN

EXT. WALL MOUNTED INDIRECT CORNER LIGHT FIXTURE, HIGH EFFICIENCY LED LAMP W/ OBSCURE GLASS, 25 WATT OR EQUIVALENT MAX. BY HANDLEMAN STUDIOS 'ARLINGTON' LARGE COLOR: BLACK RUST, 16" X12".

16G EXT LIGHT FIXTURE. LED. HANDELMAN. 'BACARRA' LARGE BLACK. OBSCURE GLASS

IRON RAILING @ BLDG. A, PER DETAIL 34. PROVIDE SHOP DRAWINGS. GALVANIZED BLACK

IRON RAILING @ BLDG. B, PER DETAIL 35. PROVIDE SHOP DRAWINGS. GALVANIZED BLACK

IRON RAILING @ BRIDGES, PER DETAIL 38. PROVIDE SHOP DRAWINGS. GALVANIZED BLACK WEEP SCREED, PROFILE TO ALLOW PLASTER BELOW SCREED PER DETAIL. PROVIDE 26 GAUGE

MIN. GALVANIZED WEEP SCREED AT FOUNDATION, 4" MIN. ABOVE GRADE OR 2†MIN. ABOVE CONCRETE/PAVING WHERE OCCURS PER DET 21

IRON BALCONY 2 W/FULL HEIGHT WALL SUPPORT PER DETAIL 32/A10.5 PROVIDE SHOP DRAWINGS. GALVANIZED. BLACK SEMI GLOSS. BLDG A

21.4 IRON BALCONY 4 PER DETAIL 39. PROVIDE SHOP DRAWINGS. GALVANIZED. BLACK SEMI GLOSS

PLASTER BUTTRESS PER DETAIL 20,98,99

HAND FORGED IRON CHIMNEY CAP PER DETAIL 96. 29.1 CANVAS CURTAIN, STEEL ROD BLACK SEMI-GLOSS. BLDG. A COLOR: SUNBRELLA 'DUBONNET TWEED'

CANVAS AWNING, SUNBRELLA. BRACKET DESIGN AS APPROVED BY ARCHITECT. ORTEGA

BRIDGE BRACKET (SEMI-GLOSS) COLOR: SUNBRELLA 'BASIL' TILE WALL CAP. TERRA COTTA. PER DETAIL 15. 12X12X1.5

TILE WALL BASE @ BLDG. A PER DETAIL. TALAVERA, 'CAJEME' 6" SQ.

33.2 TILE WALL BASE @ BLDG. A PER DETAIL, TALAVERA, 'ATESSA' 6" SQ. 33.3 TILE WALL BASE @ BLDG. B PER DETAIL, TALAVERA, 'SOYOPA' 6" SQ.

POT, GLADDING MCBEAN MODEL 156.23, CHAPALA BRIDGE COLOR: GLADDEN MCBEAN 'CAVERN CLAY'

VW EMBLEM GFRC 30" DIAMETER

SIGNAGE, TBD

FORMED PLASTER SURROUND PER DETAIL

CLASS A ROOF, TILE CAPS AND STARTER PAN, REMAINING PANS NEW TO MATCH SUPPLIED. REDLANDS - VERIFY W/ARCHITECT. STAGGER TILE FIELD, WIRED INSTALLATION, STACK EAVE TILES TWO HIGH WITH STAGGERED OVERHANG TOP TILE OF 1"-3" MORTAR BIRDS MOUTH OPEING TO PREVENT THE INSTRUSION OF POTENTIAL FLAMES AND EMBERS, OVER EXTERIOR PLY AND 2 LAYERS CLASS A WATERPROOF BITUMINOUS UNDERLAYMENT (1 LAYER BASE SHEET NAILED AND 1 LAYER GRANULATED TOP SHEET TORCH DOWN), VALLEY FLASHING 26 GAUGE MIN. CORROSION RESISTANT SHEET METAL OVER 36" MIN. WIDE UNDERLAYMENT OF 72# MINERAL-SURFACED NON-PERFORMANCE CAP SHEET (ASTM D3909) RUN FULL LENGTH OF VALLEY. DETAIL 5/A10.1

5" HALF ROUND COPPER GUTTER W/4" DIA. COPPER DOWNSPOUT, LOCK ON STYLE, COMPATIBLE W/5" GUTTERS TO PREVENT THE ACCUMULATION OF LEAVES AND DEBRIS. CONNECT DRAINAGE TO STORM DRAIN SYSTEM

COPPER COLLECTOR BOX PER DETAIL 97/A10.10

7/8" EXTERIOR PLASTER, PAINTED COLOR: WARM WHITE - VERIFY TEXURE WITH ARCHITECT. PROVIDE SAMPLES IN FIELD. TIGHT HAND FORMED CORNERS AND SMOOTH STEEL TROWEL FINISH, INTEGRATE FIBERGLASS MESH INTO WET BASE BROWN COAT (OMEGA PRODUCTS INTERNATIONAL CRACK ISOLATION SYSTEM OR EQUIVALENT) OVER METAL LATHE, TYVEK (TWO LAYERS AT SHEAR WALLS) AND EXTERIOR PLY. EXTERIOR WALL FINISH TO EXTEND FROM TOP OF FOUNDATION TO ROOF TERMINATING AT 2" NOMINAL SOLID WOOD BLOCKING BETWEEN RAFTERS AT ALL ROOF OVERHANGS.


4X8 DOUGLAS FIR ROOF RAFTERS PER STRUCTUREL ENGINEER OR RAFTERS TAILS @ 24" O.C. MAX, U.N.O. SOLID BODY STAIN TO MATCH EAVES

METAL CLAD DOORS AND WINDOWS AT BLDG. A. ANDERSEN E SERIES DUAL LOW E. COLOR:

DYNAMIC 'ARTE ALUMINUM' STOREFRONT DOOR OR WINDOW PER DETAIL. MATCH BUILDING WINDOW COLOR

GFRC DECORATIVE PLASTER GRILLE PER DETAILS. SUPPLY: PACIFIC REGISTER COMPANY

EXT. WALL MOUNTED INDIRECT LIGHT FIXTURE, HIGH EFFICIENCY LED LAMP W/SHIELDED GLASS, 25 WATT OR EQUIVALENT MAX. BY HANDLEMAN STUDIOS 'ANACAPA-MEDIUM' COLOR: BLACK RUST, 10"X28". OBSCURE GLASS

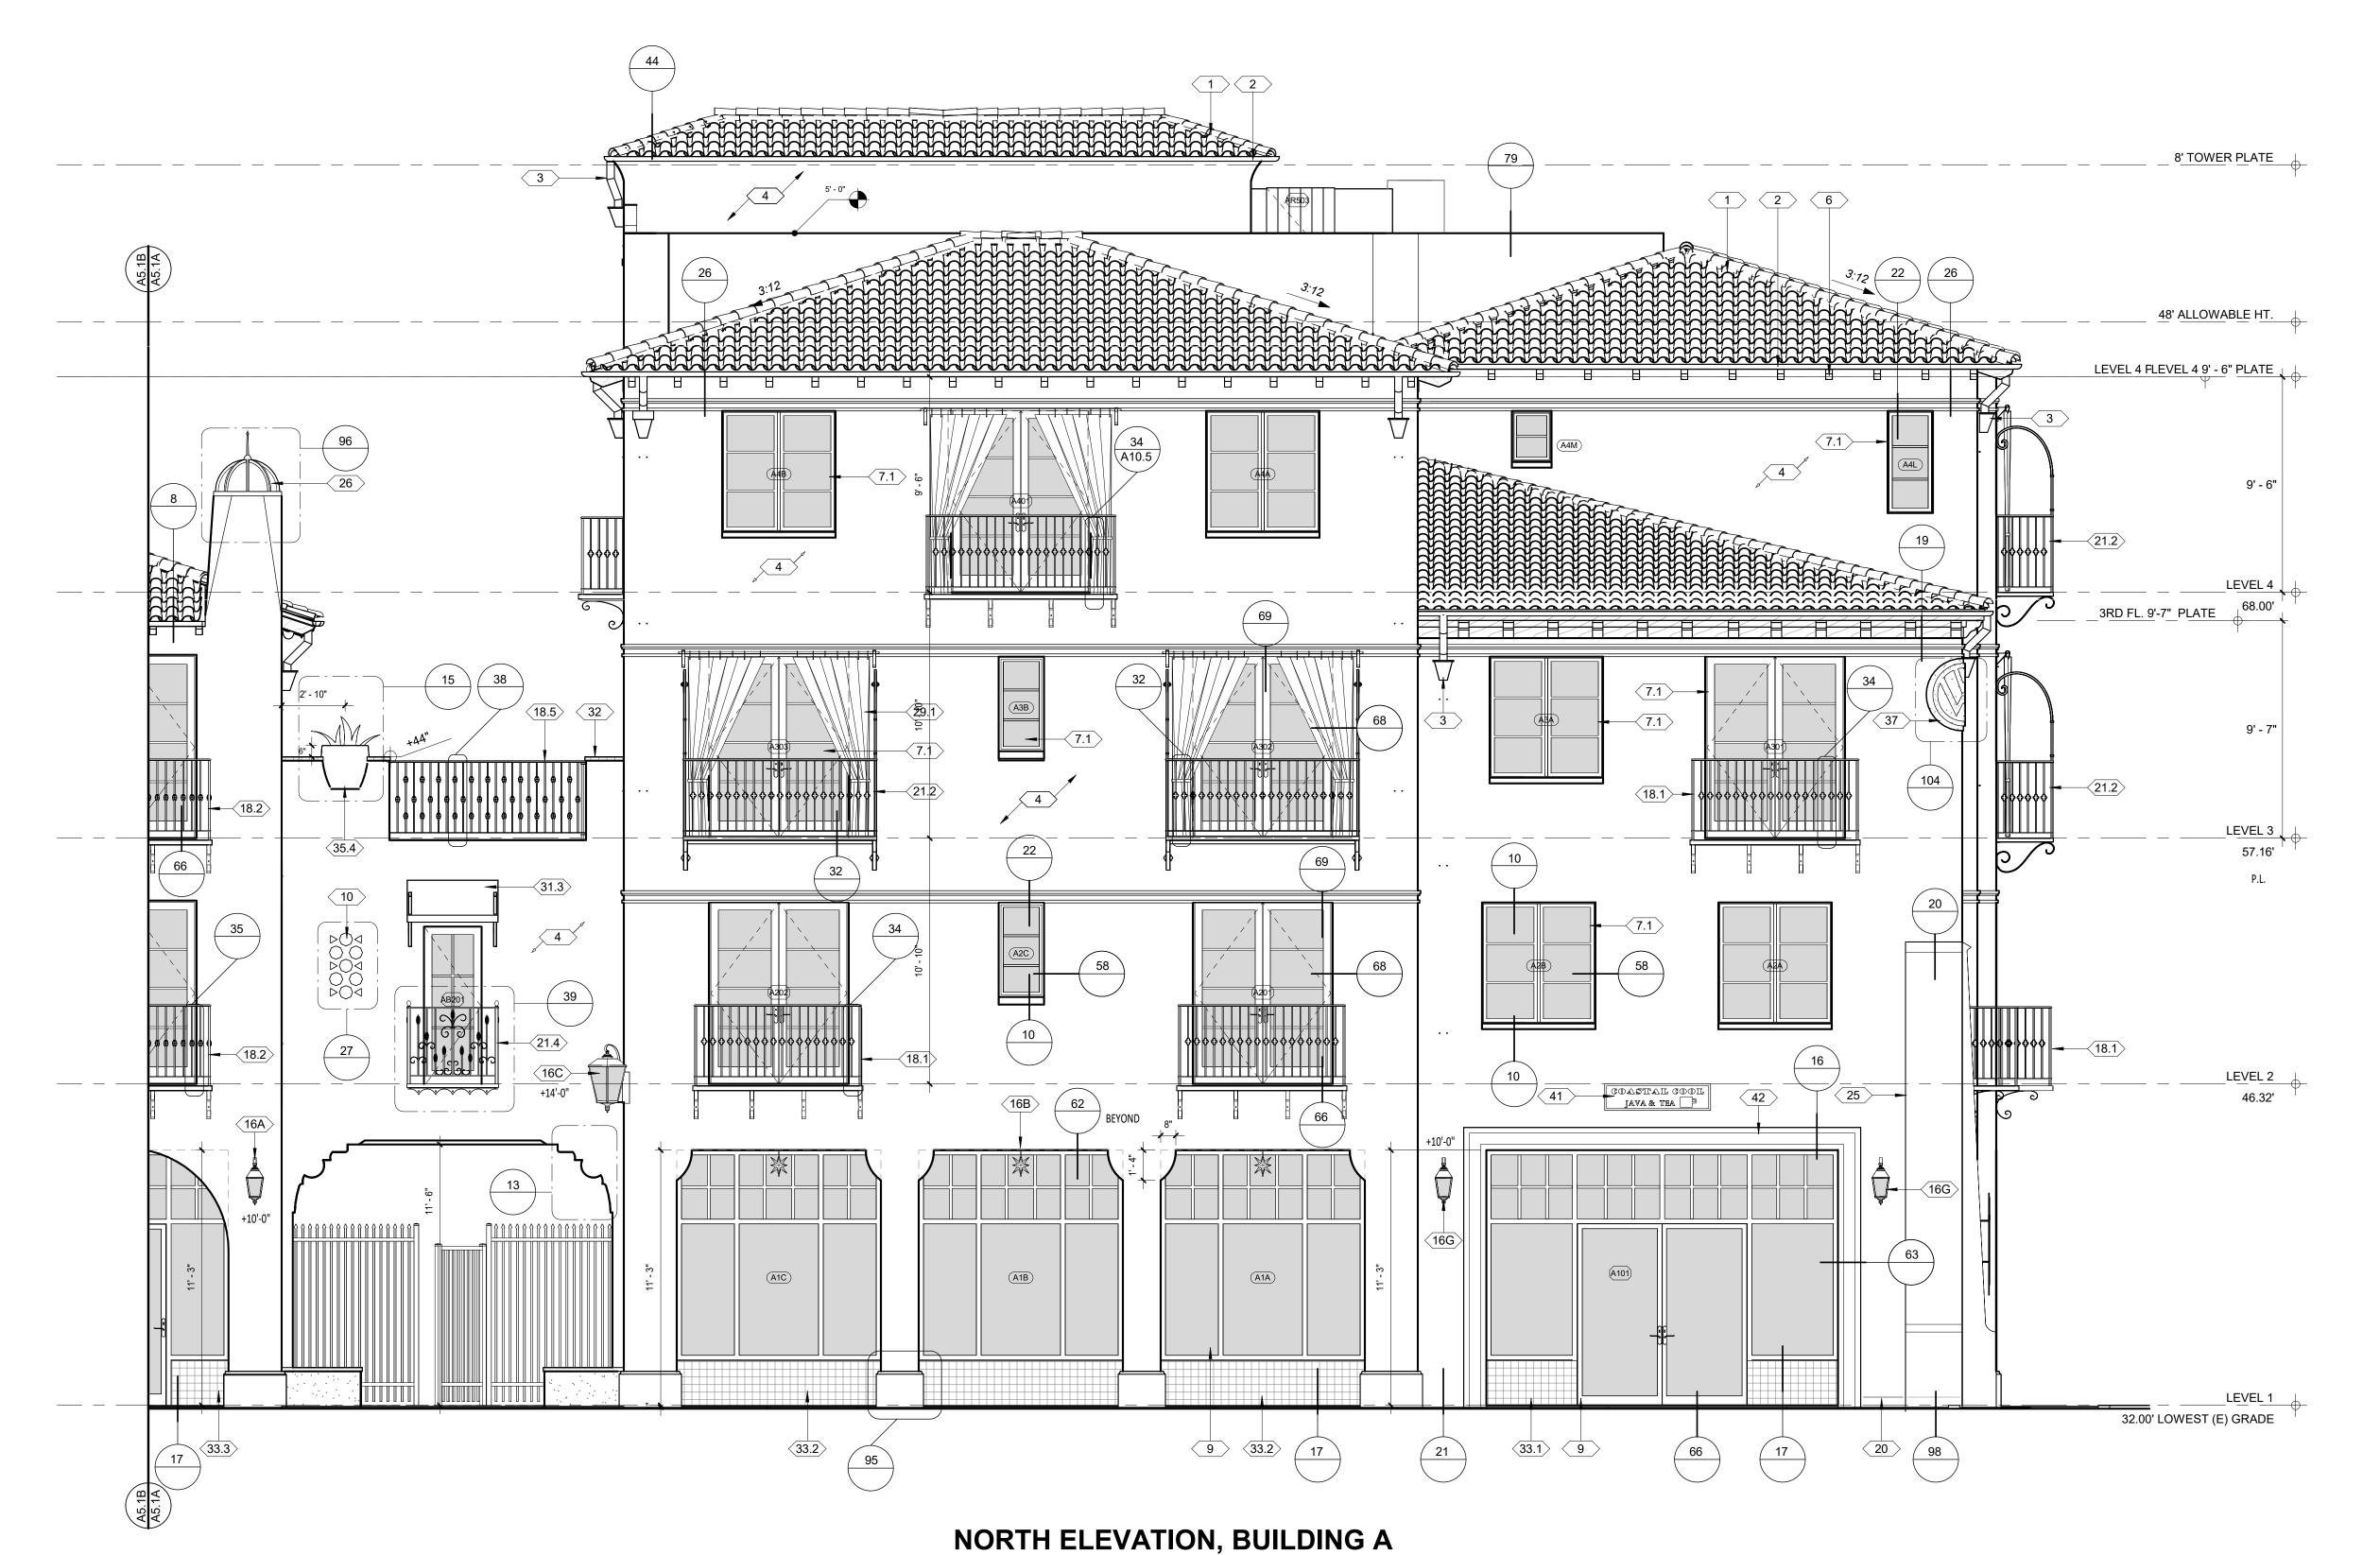

ORTEGA STREET

REVISION SCHEDULE O. DESCRIPTION DATE

 \circ

NORTH ELEVATION



REFER TO STRUCTURAL PLANS FOR FOUNDATION AND SLAB INFORMATION


- REFER TO ELECTRICAL PLANS FOR ALL EXTERIOR LIGHTING FIXTURES, NOTES AND WIRING CONTROL JOINTS NOT SHOWN BUT SHALL MEET THE FOLLOWING REQUIREMENTS NO PANELS OR SECTIONS SHALL EXCEED A SQUARE AREA OF 144 S.F.
- DISTANCE BETWEEN CONTROL JOINTS SHALL NOT EXCEED 16' U.N.O. BY E.O.R. CONTROL JOINTS SHALL BE LOCATED ON BOTH SIDES OF OPENINGS LARGER THAN 6'-0" U.N.O. BY E.O.R.
- CONTROL JOINTS SHALL BE LOCATED AT AT LEAST ONE SIDE OF OPENINGS SMALLER THAN 6'-0" U.N.O. BY E.O.R.
- F. SEE FINISH SCHEDULE FOR COLORS AND MATERIALS


EXTERIOR FINISHES

- 14 8X8 DOUGLAS FIR BEAM AT DECK PER DETAIL 40/A10.5. 12/A102, 5/A102, SMOOTH TEXTURE. SOLID BODY STAIN COLOR:
- 16A EXT. WALL MOUNTED INDIRECT LIGHT FIXTURE, HIGH EFFICIENCY LED LAMP W/SHIELDED GLASS, 25 WATT OR EQUIVALENT MAX. BY HANDLEMAN STUDIOS 'ANACAPA-MEDIUM' COLOR: BLACK RUST, 10"X28". OBSCURE GLASS
- 16B ARCADE LIGHTING. GLASS STAR LIGHT PENDANT. 18 POINT, 15" BY HOMETOWN EVOLUTION. CLEAR, 24" CHAIN
- 16C EXT. WALL MOUNTED INDIRECT CORNER LIGHT FIXTURE, HIGH EFFICIENCY LED LAMP W/ OBSCURE GLASS, 25 WATT OR EQUIVALENT MAX. BY HANDLEMAN STUDIOS 'ARLINGTON' LARGE COLOR: BLACK RUST, 16" X12".
- 16F EXT WALL SCONCE.LED. HANDELMAN. "CUMBERLAND" SMALL. OBSCURE GLASS.PER PLAN LOCATIONS
- 18.2 IRON RAILING @ BLDG. B, PER DETAIL 35. PROVIDE SHOP DRAWINGS. GALVANIZED BLACK
- IRON RAILING @ BRIDGES, PER DETAIL 38. PROVIDE SHOP DRAWINGS. GALVANIZED BLACK
- 21.4 IRON BALCONY 4 PER DETAIL 39. PROVIDE SHOP DRAWINGS. GALVANIZED. BLACK SEMI GLOSS
- HAND FORGED IRON CHIMNEY CAP PER DETAIL 96. 31.3 CANVAS AWNING, SUNBRELLA. BRACKET DESIGN AS APPROVED BY
 - ARCHITECT. ORTEGA BRIDGE BRACKET (SEMI-GLOSS) COLOR: SUNBRELLA
- TILE WALL CAP. TERRA COTTA. PER DETAIL 15. 12X12X1.5 33.3 TILE WALL BASE @ BLDG. B PER DETAIL, TALAVERA, 'SOYOPA' 6" SQ.
- POT, GLADDING MCBEAN MODEL 156.23, BLDG. B (X2) COLOR: GLADDEN MCBEAN 'HARVEST'
- 35.4 POT, GLADDING MCBEAN MODEL 156.23, CHAPALA BRIDGE COLOR: GLADDEN
- MCBEAN 'CAVERN CLAY' EXTERIOR STAIR TREADS AND BALCONY: PETRAIA LOTTO GRIP PORCELAIN.
- A852734. CUT NOSING TO 1-1/2"
- SCUPPER PER DETAIL

EXTERIOR FINISHES

- CLASS A ROOF, TILE CAPS AND STARTER PAN, REMAINING PANS NEW TO MATCH SUPPLIED. REDLANDS - VERIFY W/ARCHITECT. STAGGER TILE FIELD, WIRED INSTALLATION, STACK EAVE TILES TWO HIGH WITH STAGGERED OVERHANG TOP TILE OF 1"-3" MORTAR BIRDS MOUTH OPEING TO PREVENT THE INSTRUSION OF POTENTIAL FLAMES AND EMBERS, OVER EXTERIOR PLY AND 2 LAYERS CLASS A WATERPROOF BITUMINOUS UNDERLAYMENT (1 LAYER BASE SHEET NAILED AND 1 LAYER GRANULATED TOP SHEET TORCH DOWN), VALLEY FLASHING 26 GAUGE MIN. CORROSION RESISTANT SHEET METAL OVER 36" MIN. WIDE UNDERLAYMENT OF 72# MINERAL-SURFACED NON-PERFORMANCE CAP SHEET (ASTM D3909) RUN FULL LENGTH OF VALLEY. DETAIL 5/A10.1
- 5" HALF ROUND COPPER GUTTER W/4" DIA. COPPER DOWNSPOUT, LOCK ON STYLE, COMPATIBLE W/ 5" GUTTERS TO PREVENT THE ACCUMULATION OF LEAVES AND DEBRIS, CONNECT DRAINAGE TO STORM DRAIN SYSTEM
- COPPER COLLECTOR BOX PER DETAIL 97/A10.10 7/8" EXTERIOR PLASTER, PAINTED COLOR: WARM WHITE - VERIFY TEXURE WITH ARCHITECT. PROVIDE SAMPLES IN FIELD. TIGHT HAND FORMED CORNERS AND SMOOTH STEEL TROWEL FINISH, INTEGRATE FIBERGLASS MESH INTO WET BASE BROWN COAT (OMEGA PRODUCTS INTERNATIONAL CRACK ISOLATION SYSTEM OR EQUIVALENT) OVER METAL LATHE, TYVEK (TWO LAYERS AT SHEAR WALLS) AND EXTERIOR PLY. EXTERIOR WALL FINISH TO EXTEND FROM TOP OF FOUNDATION TO ROOF TERMINATING AT 2" NOMINAL SOLID WOOD BLOCKING BETWEEN RAFTERS AT ALL ROOF OVERHANGS.
- 2X6 T&G KILN DRIED DOUGLAS FIR EAVES PER DETAIL 8/A10.1, SMOOTH TEXTURE, SOLID BODY, STAIN COLOR: VERIFY W/ARCHITECT.
- 7.2 METAL CLAD DOORS AND WINDOWS AT BLDG. B. ANDERSEN E SERIES DUAL LOW E. COLOR: SLATE
- DYNAMIC 'ARTE ALUMINUM' STOREFRONT DOOR OR WINDOW PER DETAIL. MATCH BUILDING WINDOW COLOR
- GFRC DECORATIVE PLASTER GRILLE PER DETAILS. SUPPLY: PACIFIC REGISTER COMPANY
- DOUGLAS FIR CORBEL PER DETAIL 12/A10.2, SOLID BODY STAIN COLOR:

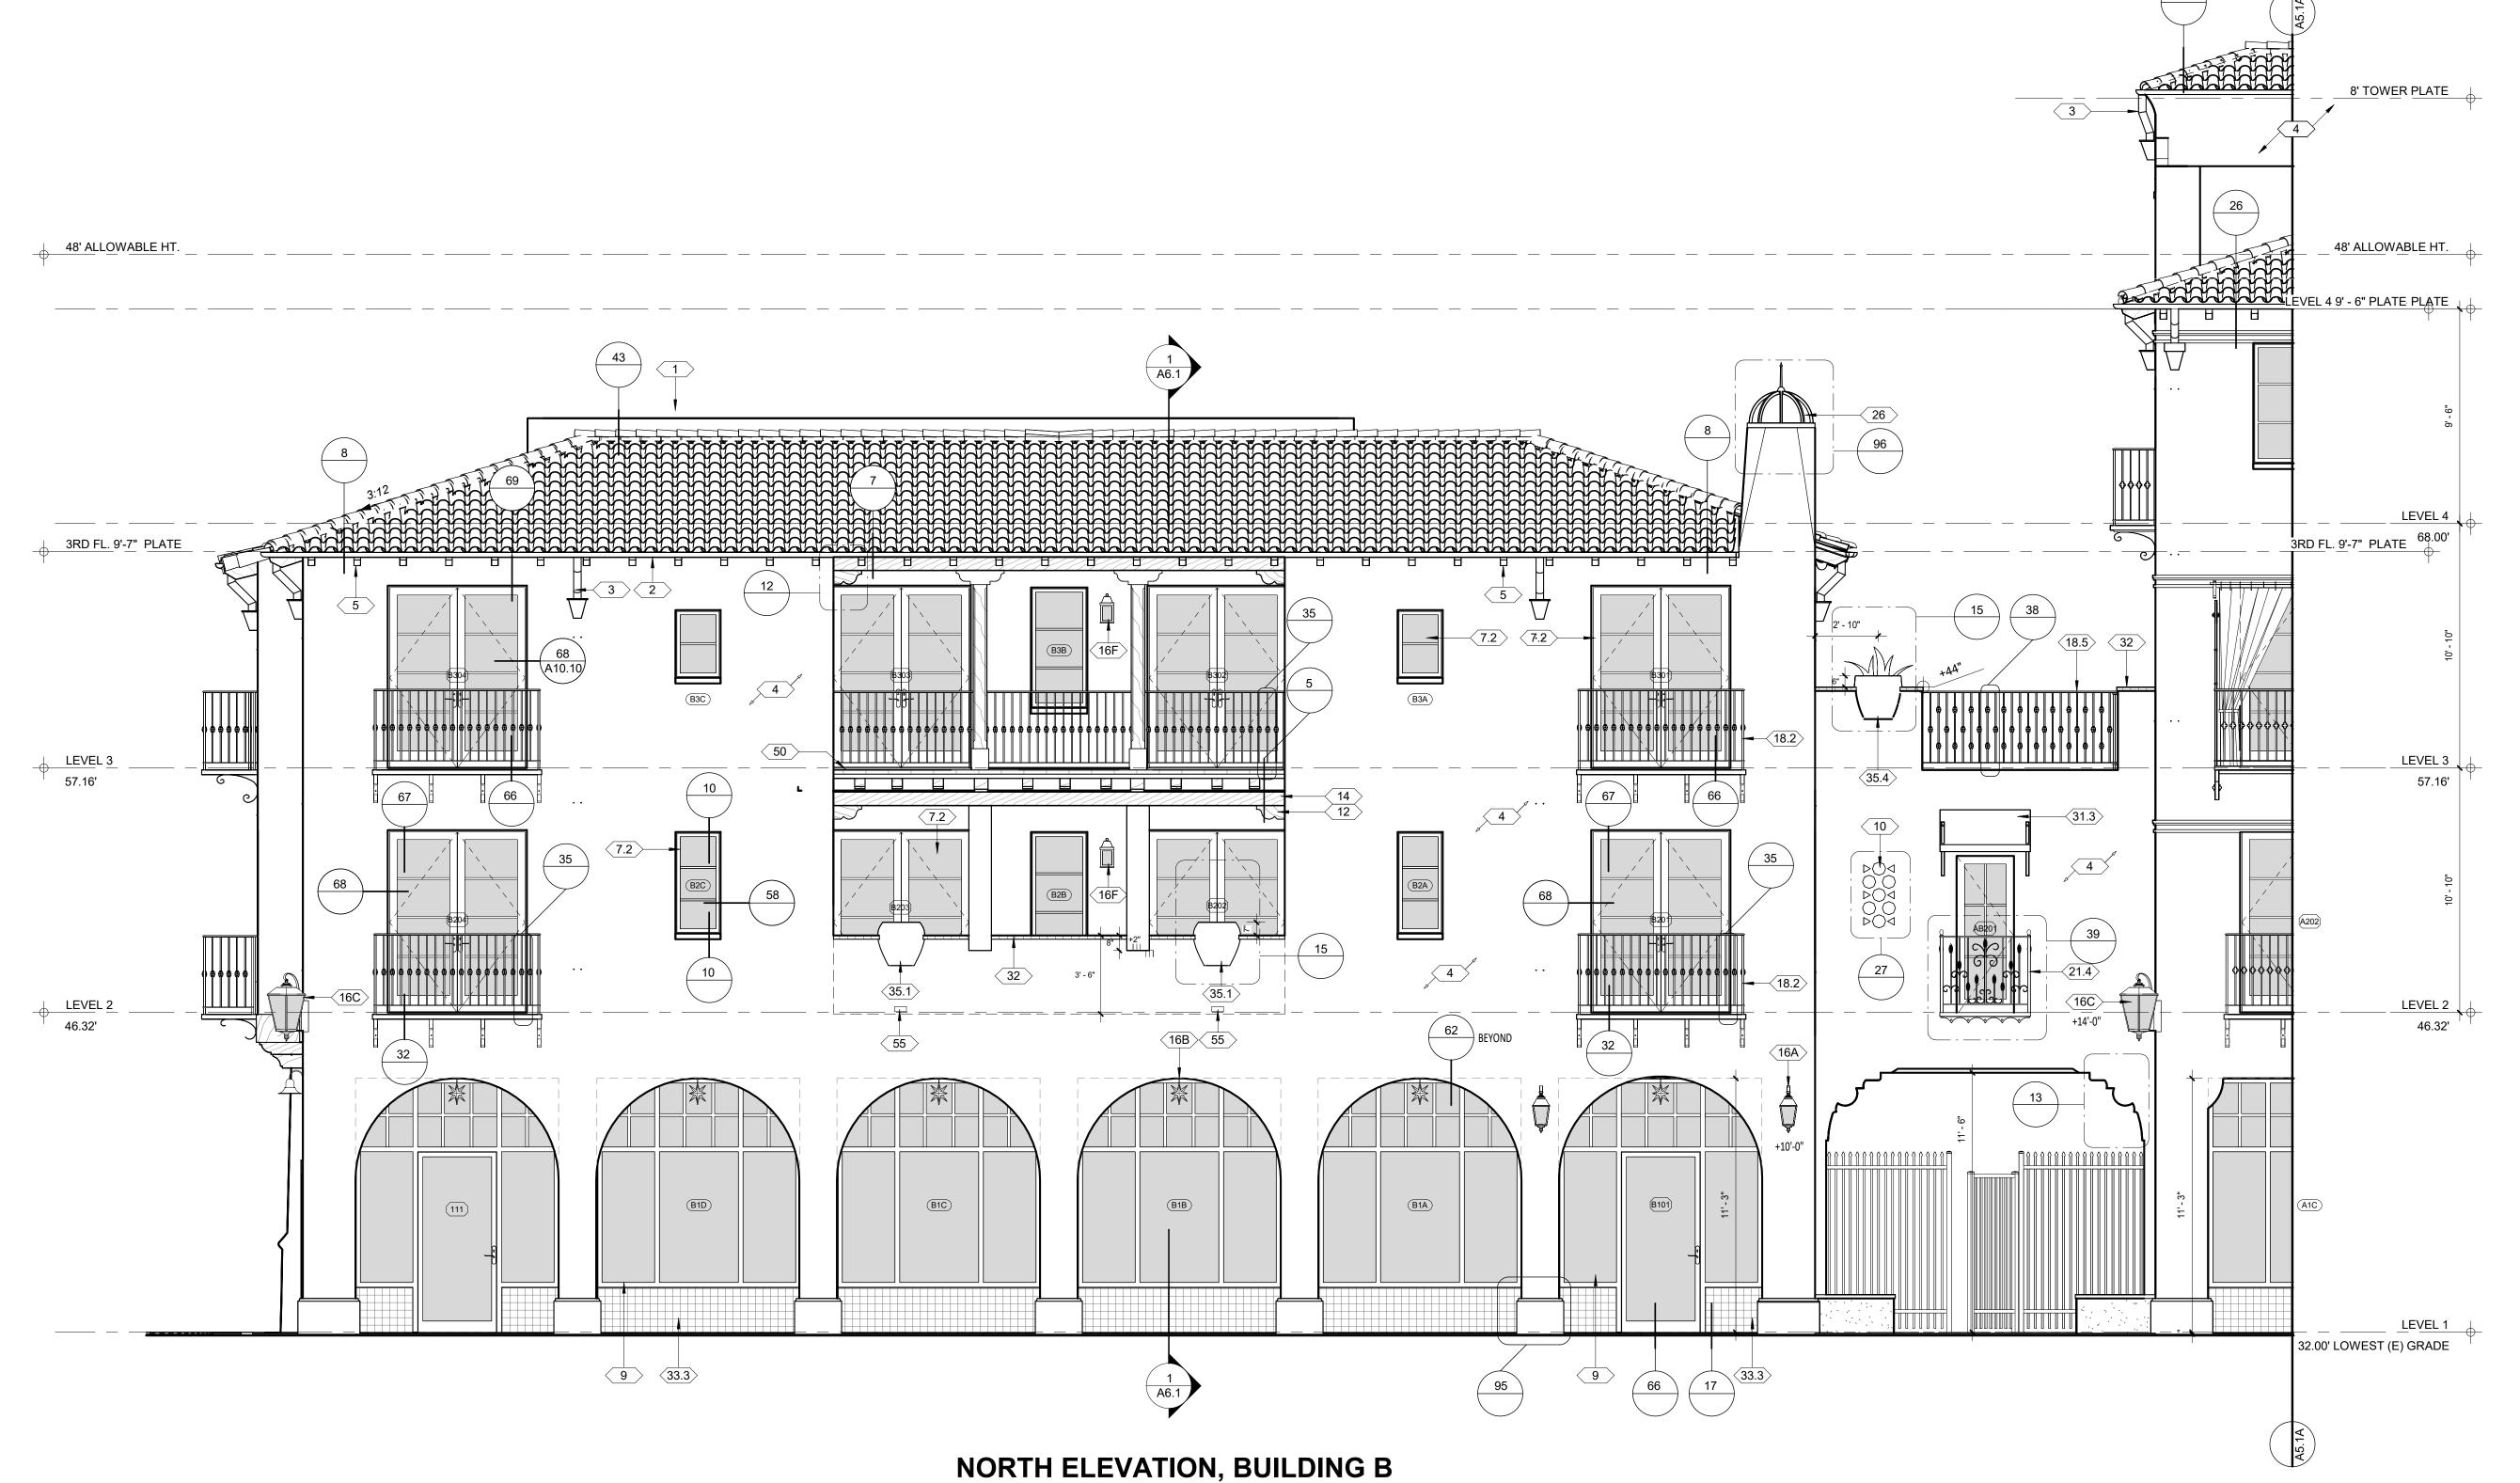

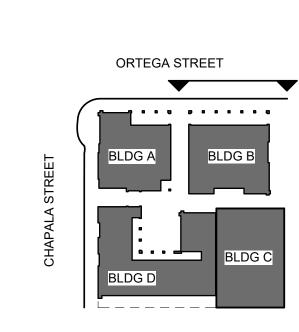

≨ 0

C


REVISION SCHEDULE

O. DESCRIPTION DATE

NORTH ELEVATION



EAST ELEVATION1/8" = 1'-0"

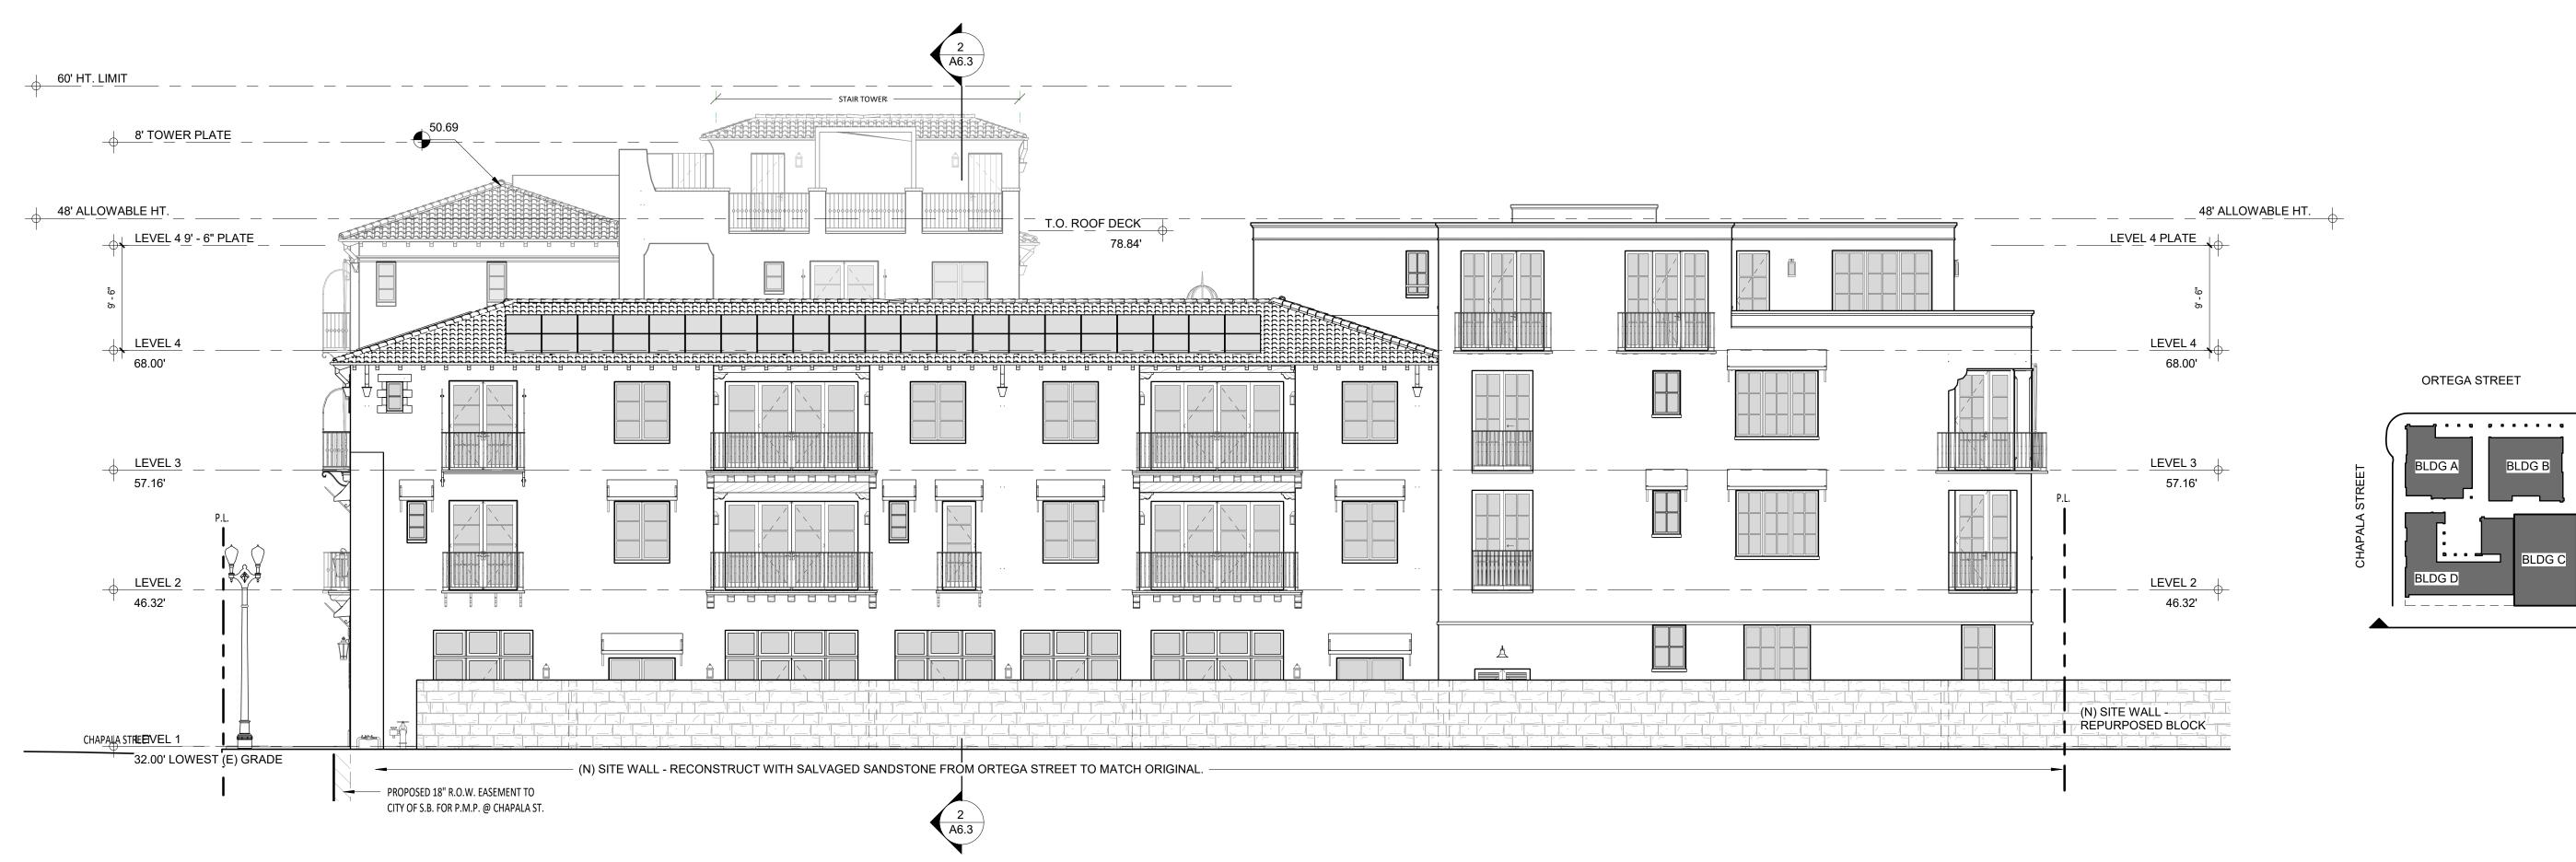

SOUTH ELEVATION

1/8" = 1'-0"

Date
Scale
Drawn

SHEET NO. **A5.2**

As indicated

OVERALL EXTERIOR ELEVATIONS

EXTERIOR SIGNAGE NOT SHOWN. UNDER SEPARATE PERMIT REFER TO STRUCTURAL PLANS FOR FOUNDATION AND SLAB INFORMATION

REFER TO STRUCTURAL PLANS FOR FOUNDATION AND SLAB INFORMATION

REFER TO ELECTRICAL PLANS FOR ALL EXTERIOR LIGHTING FIXTURES, NOTES AND WIRING

CONTROL JOINTS NOT SHOWN BUT SHALL MEET THE FOLLOWING REQUIREMENTS

NO PANELS OR SECTIONS SHALL EXCEED A SQUARE AREA OF 144 S.F.
 DISTANCE BETWEEN CONTROL JOINTS SHALL NOT EXCEED 16' U.N.O. BY E.O.R.
 CONTROL JOINTS SHALL BE LOCATED ON BOTH SIDES OF OPENINGS LARGER THAN 6'-0"

U.N.O. BY E.O.R.
4. CONTROL JOINTS SHALL BE LOCATED AT AT LEAST ONE SIDE OF OPENINGS SMALLER

THAN 6'-0" U.N.O. BY E.O.R.

F. SEE FINISH SCHEDULE FOR COLORS AND MATERIALS

CLASS A ROOF, TILE CAPS AND STARTER PAN, REMAINING PANS NEW TO MATCH SUPPLIED. REDLANDS - VERIFY W/ARCHITECT. STAGGER TILE FIELD, WIRED INSTALLATION, STACK EAVE TILES TWO HIGH WITH STAGGERED OVERHANG TOP TILE OF 1"-3" MORTAR BIRDS MOUTH OPEING TO PREVENT THE INSTRUSION OF POTENTIAL FLAMES AND EMBERS, OVER EXTERIOR PLY AND 2 LAYERS CLASS A WATERPROOF BITUMINOUS UNDERLAYMENT (1 LAYER BASE SHEET NAILED AND 1 LAYER GRANULATED TOP SHEET TORCH DOWN), VALLEY FLASHING 26 GAUGE MIN. CORROSION RESISTANT SHEET METAL OVER 36" MIN. WIDE UNDERLAYMENT OF 72# MINERAL-SURFACED NON-PERFORMANCE CAP SHEET (ASTM D3909) RUN FULL LENGTH OF VALLEY. DETAIL 5/A10.1

5" HALF ROUND COPPER GUTTER W/4" DIA. COPPER DOWNSPOUT, LOCK ON STYLE, COMPATIBLE W/ 5" GUTTERS TO PREVENT THE ACCUMULATION OF LEAVES AND DEBRIS, CONNECT DRAINAGE TO STORM DRAIN SYSTEM

3 COPPER COLLECTOR BOX PER DETAIL 97/A10.10

5 2X6 T&G KILN DRIED DOUGLAS FIR EAVES PER DETAIL 8/A10.1, SMOOTH TEXTURE, SOLID BODY, STAIN COLOR: VERIFY W/ARCHITECT.

7.2 METAL CLAD DOORS AND WINDOWS AT BLDG. B. ANDERSEN E SERIES DUAL LOW E. COLOR: SLATE

16A EXT. WALL MOUNTED INDIRECT LIGHT FIXTURE, HIGH EFFICIENCY LED LAMP W/SHIELDED GLASS, 25 WATT OR EQUIVALENT MAX. BY HANDLEMAN STUDIOS 'ANACAPA-MEDIUM' COLOR: BLACK RUST, 10"X28". OBSCURE GLASS

16B ARCADE LIGHTING. GLASS STAR LIGHT PENDANT. 18 POINT, 15" BY HOMETOWN EVOLUTION. CLEAR, 24" CHAIN

EXT. WALL MOUNTED INDIRECT CORNER LIGHT FIXTURE, HIGH EFFICIENCY LED LAMP W/ OBSCURE GLASS, 25 WATT OR EQUIVALENT MAX. BY HANDLEMAN STUDIOS 'ARLINGTON' LARGE COLOR: BLACK RUST, 16" X12".

16D EXT. LIGHT FIXTURE, HIGH EFFICIENCY LED LAMP 25 WATT OR EQUIVALENT MAX, BY BARN LIGHT ELECT. ORIGINAL VENTED GOOSENECK LIGHT, COLOR: BLACK RUST, 12" W/16" EXTENSION
 18.2 IRON RAILING @ BLDG. B, PER DETAIL 35. PROVIDE SHOP DRAWINGS. GALVANIZED BLACK

WEEP SCREED, PROFILE TO ALLOW PLASTER BELOW SCREED PER DETAIL. PROVIDE 26 GAUGE MIN. GALVANIZED WEEP SCREED AT FOUNDATION, 4" MIN. ABOVE GRADE OR 2†MIN. ABOVE CONCRETE/PAVING WHERE OCCURS PER DET 21

23 C.M.U. EXT. BLOCK WALL PER DETAIL WITH SANDSTONE VENEER. REUSE EXISTING STONE

25 PLASTER BUTTRESS PER DETAIL 20,98,99


38 PV SOLAR PANELS FLUSH MOUNT


FORMED PLASTER SURROUND PER DETAIL

8X12 DOUGLAS FIR BEAM PER PLAN AND DETAIL, SMOOTH TEXTURE. SOLID BODY STAIN COLOR:

44 8X8 DOUGLAS FIR CORBEL PER DETAIL, SMOOTH TEXTURE. SOLID BODY STAIN COLOR: _____

KILN DRIED VERTICAL GROOVE DOUG. FIR. TRIM PER DETAIL 41/A10.5

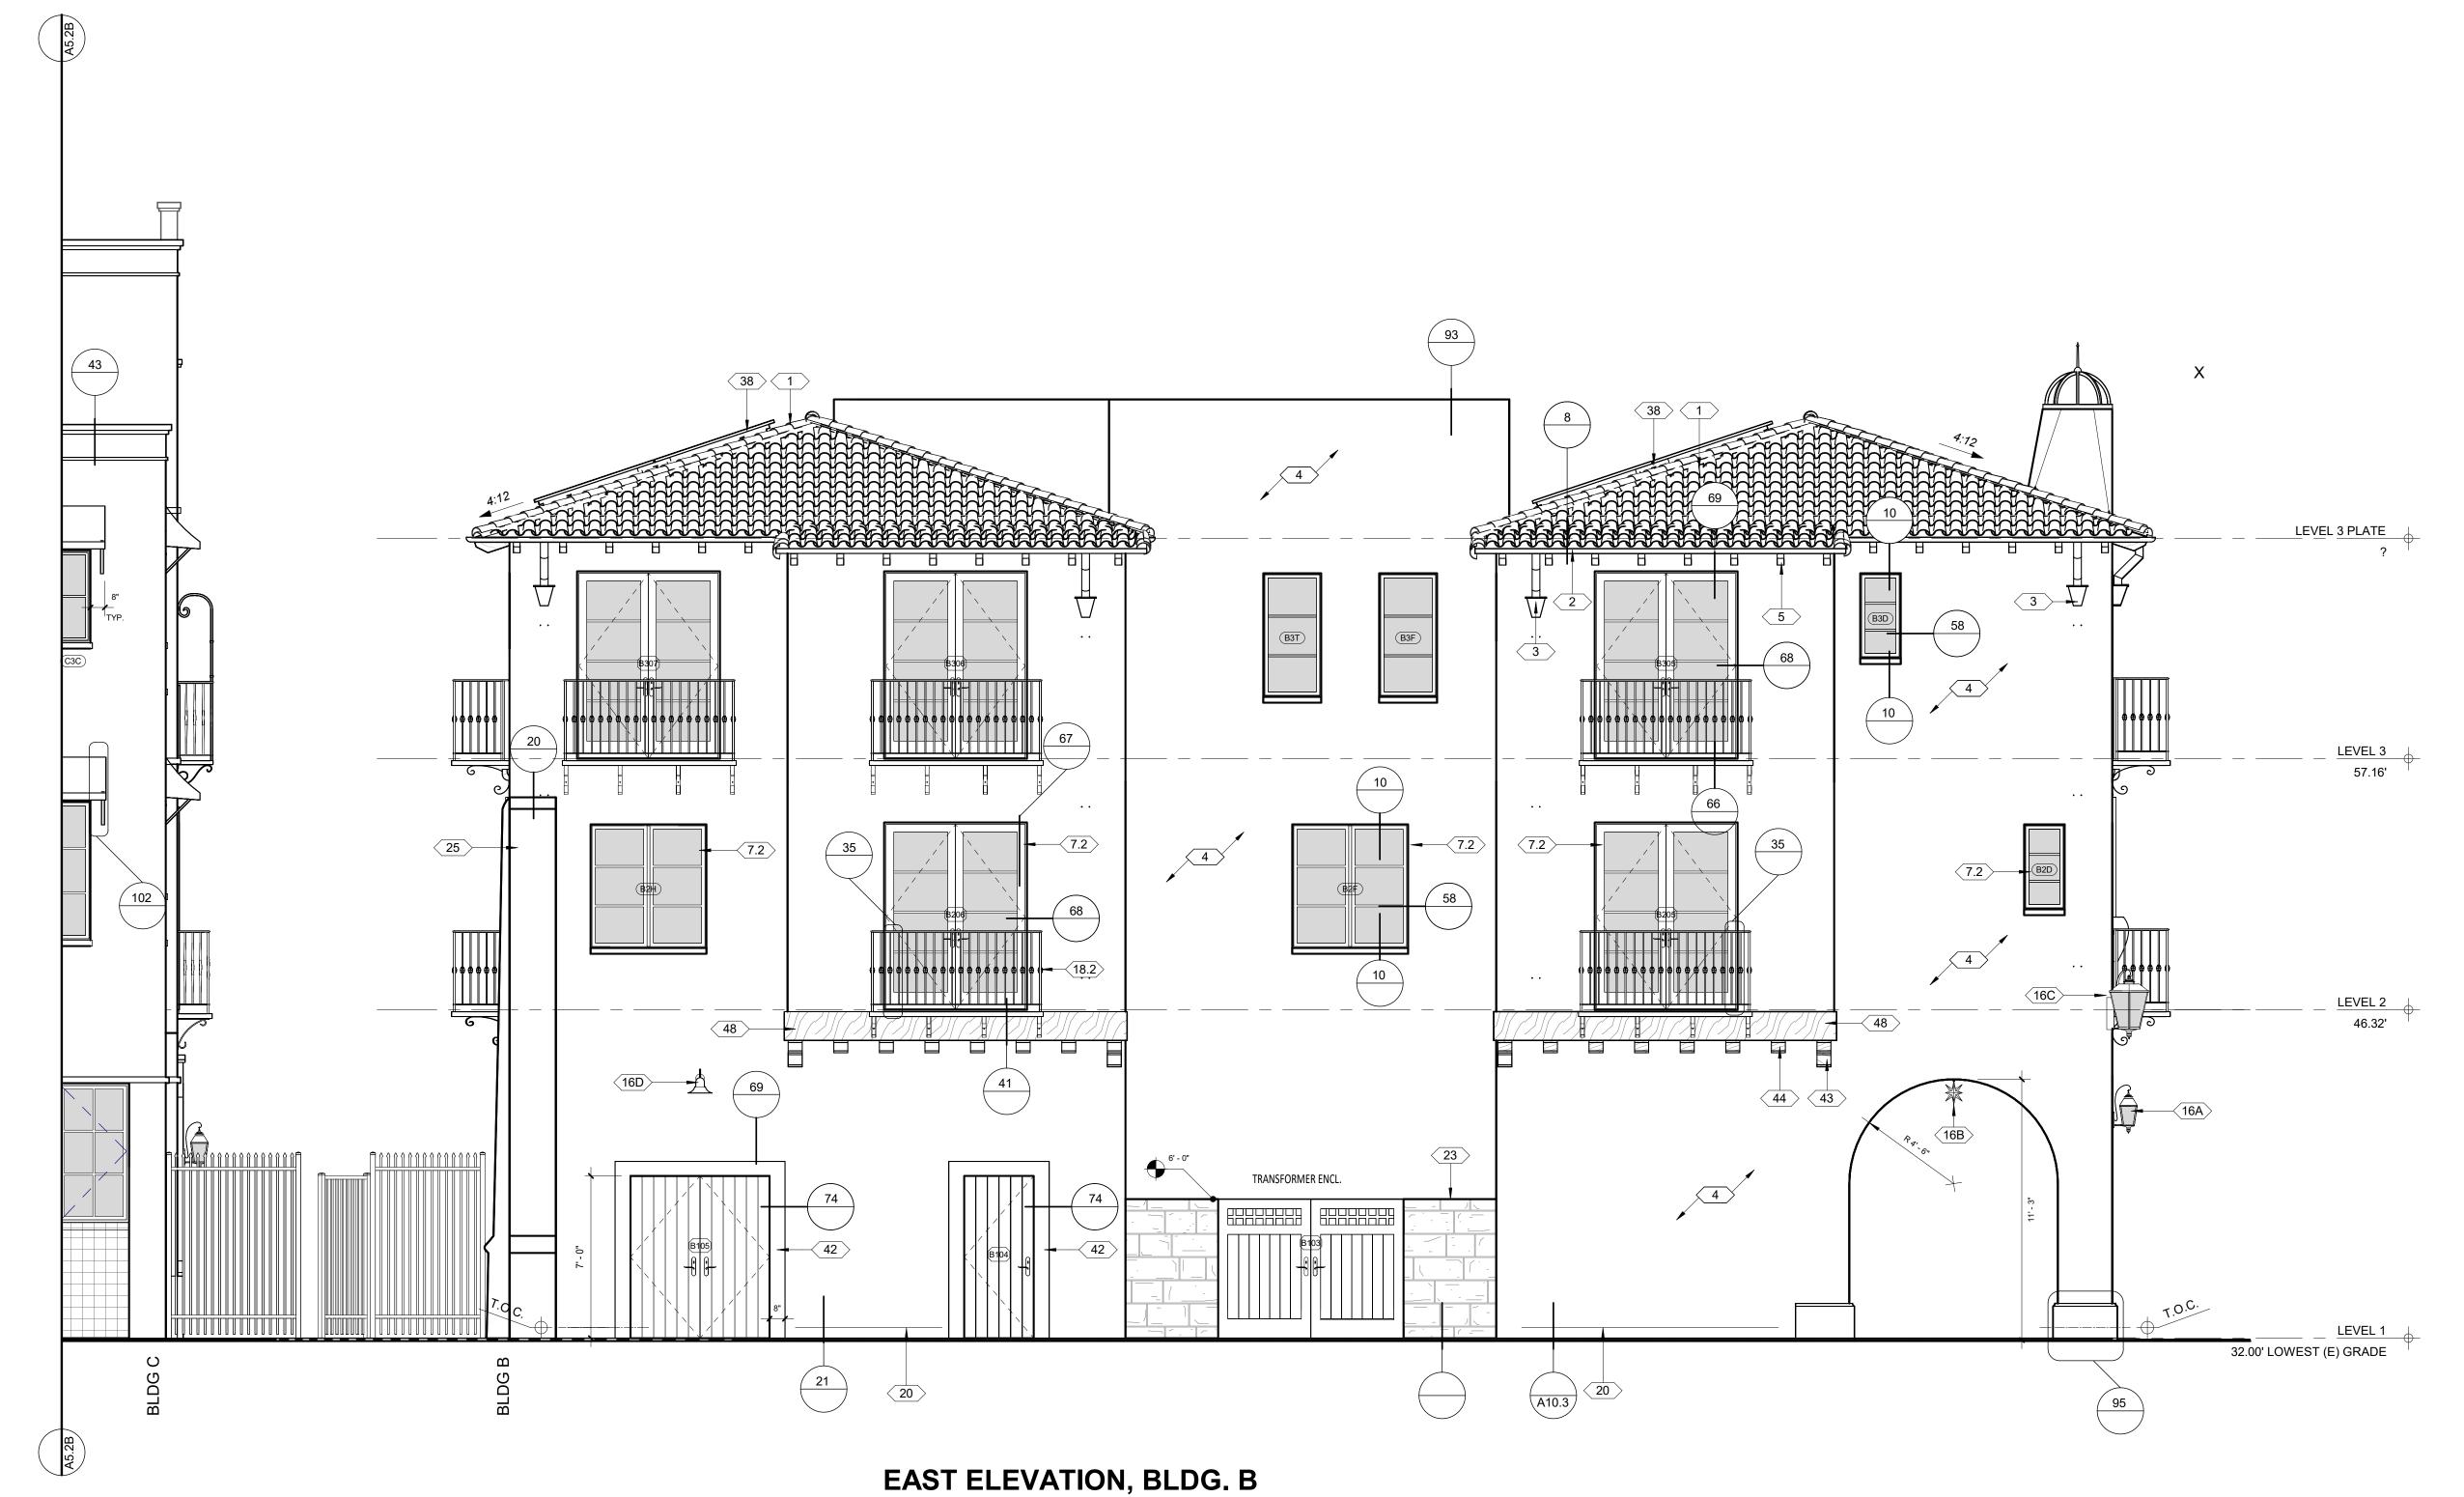

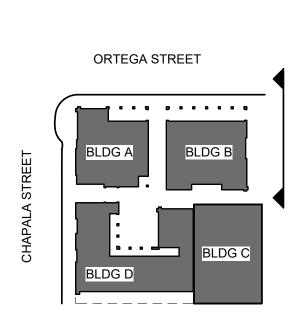

630 CHAPALA STREET

EAST ELEVATION BLDG B 1/4"

REVISION SCHEDULE

NO. DESCRIPTION DATE



Date 2024-04
Scale As indicate
Drawn

SHEET NO.


EXTERIOR SIGNAGE NOT SHOWN. UNDER SEPARATE PERMIT

REFER TO STRUCTURAL PLANS FOR FOUNDATION AND SLAB INFORMATION REFER TO ELECTRICAL PLANS FOR ALL EXTERIOR LIGHTING FIXTURES, NOTES AND WIRING

CONTROL JOINTS NOT SHOWN BUT SHALL MEET THE FOLLOWING REQUIREMENTS NO PANELS OR SECTIONS SHALL EXCEED A SQUARE AREA OF 144 S.F. DISTANCE BETWEEN CONTROL JOINTS SHALL NOT EXCEED 16' U.N.O. BY E.O.R.


CONTROL JOINTS SHALL BE LOCATED ON BOTH SIDES OF OPENINGS LARGER THAN 6'-0" U.N.O. BY E.O.R. CONTROL JOINTS SHALL BE LOCATED AT AT LEAST ONE SIDE OF OPENINGS SMALLER

THAN 6'-0" U.N.O. BY E.O.R. F. SEE FINISH SCHEDULE FOR COLORS AND MATERIALS

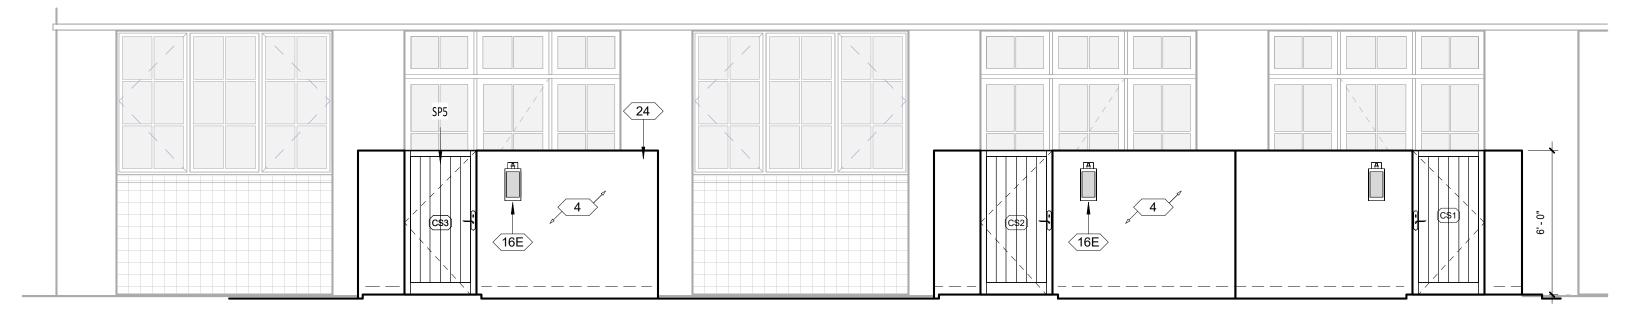

BLDG. C ENTRY COURTYARD WALL ELEVATIONS

1/4" = 1'-0"

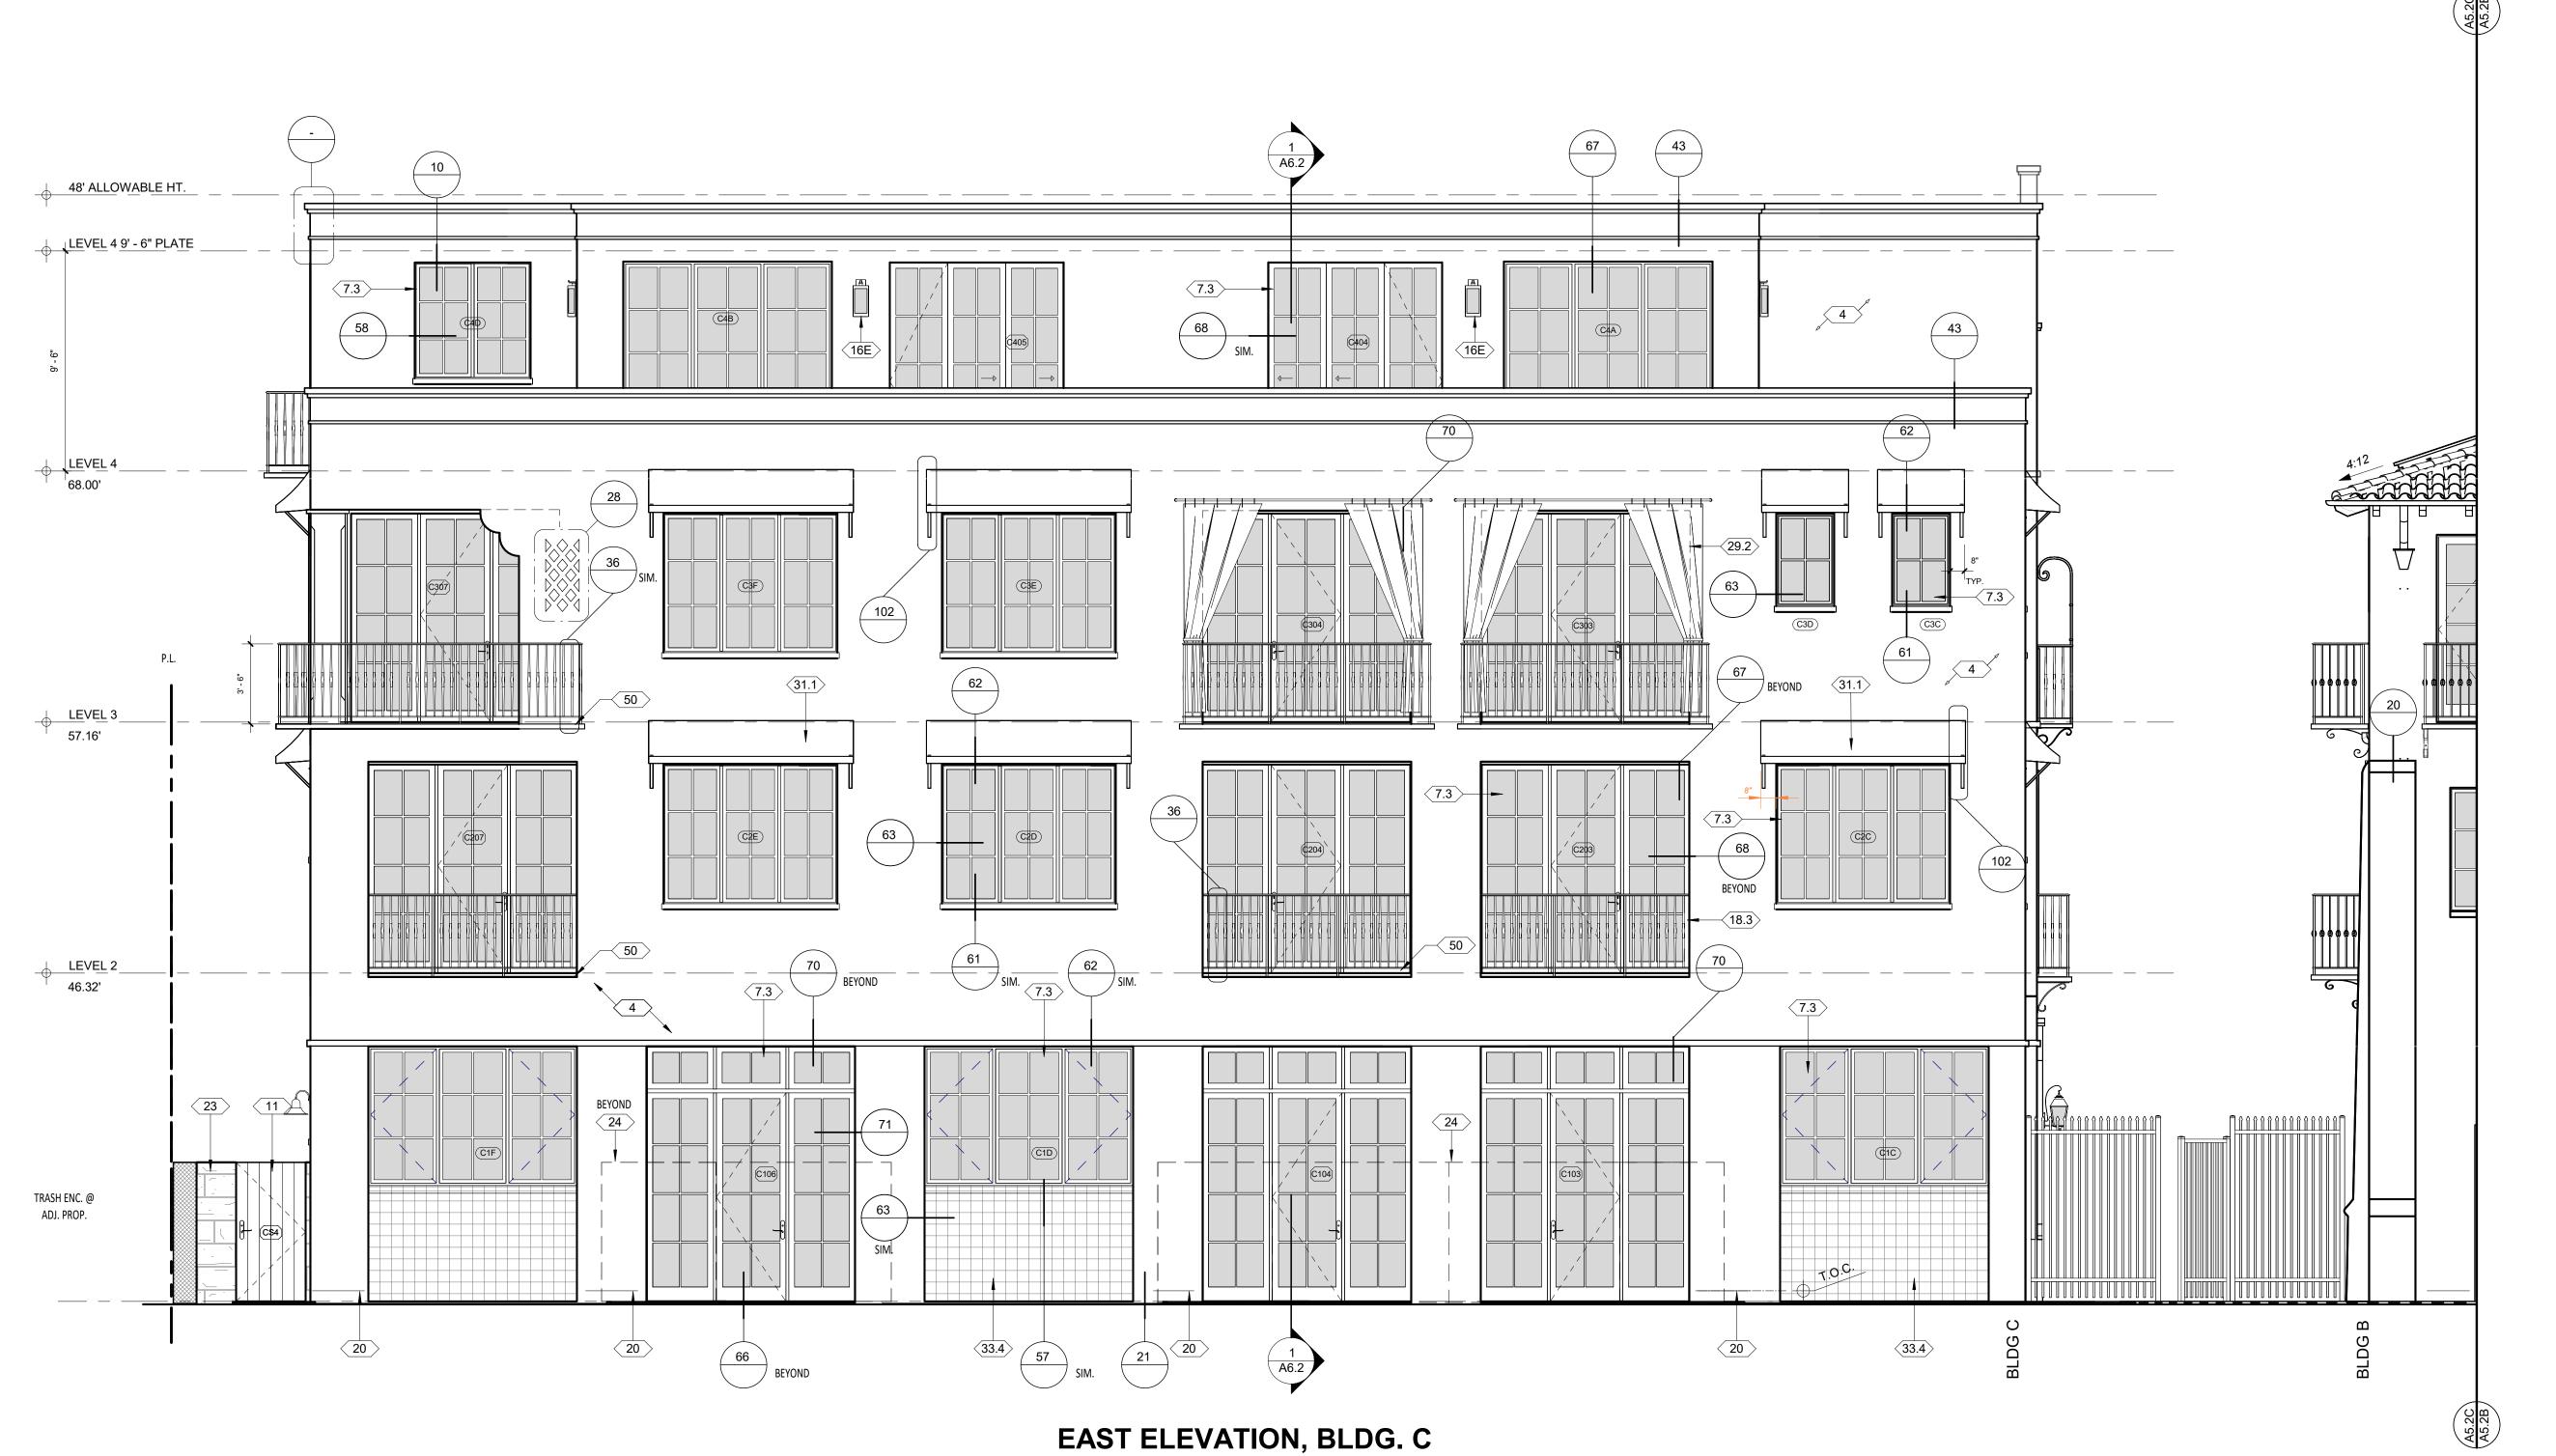

EXTERIOR FINISHES

7/8" EXTERIOR PLASTER, PAINTED COLOR: WARM WHITE - VERIFY TEXURE WITH ARCHITECT. PROVIDE SAMPLES IN FIELD. TIGHT HAND FORMED CORNERS AND SMOOTH STEEL TROWEL FINISH, INTEGRATE FIBERGLASS MESH INTO WET BASE BROWN COAT (OMEGA PRODUCTS INTERNATIONAL CRACK ISOLATION SYSTEM OR EQUIVALENT) OVER METAL LATHE, TYVEK (TWO LAYERS AT SHEAR WALLS) AND EXTERIOR PLY. EXTERIOR WALL FINISH TO EXTEND FROM TOP OF FOUNDATION TO ROOF TERMINATING AT 2" NOMINAL SOLID WOOD BLOCKING BETWEEN RAFTERS AT ALL ROOF OVERHANGS.

7.3 METAL CLAD DOORS AND WINDOWS AT BLDG. C. ARCADIA STEEL LOOK ALUMINUM DUAL LOW E. COLOR: MIDNIGHT BLACK

11 PLANK DOOR. REFER TO DOOR SCHEDULE

16E EXT. WALL SCONCE LIGHT FIXTURE, HIGH EFFICIENCY LED LAMP W/ OBSCURE GLASS, 25 WATT OR EQUIVALENT MAX. BY HANDLEMAN STUDIOS â€"BOZEMAN â€" SMALL COLOR: BLACK RUST. FLUSH MOUNT

18.3 IRON RAILING @ BLDG. C, PER DETAIL 36. PROVIDE SHOP DRAWINGS. GALVANIZED BLACK WEEP SCREED, PROFILE TO ALLOW PLASTER BELOW SCREED PER DETAIL. PROVIDE 26 GAUGE

CONCRETE/PAVING WHERE OCCURS PER DET 21 23 C.M.U. EXT. BLOCK WALL PER DETAIL WITH SANDSTONE VENEER. REUSE EXISTING STONE

MIN. GALVANIZED WEEP SCREED AT FOUNDATION, 4" MIN. ABOVE GRADE OR 2†MIN. ABOVE

C.M.U. EXT. BLOCK WALL PER DETAIL WITH EXTERIOR PLASTER, PER DETAIL CANVAS CURTAIN, STEEL ROD BLACK SEMI-GLOSS. BLDG. C COLOR: SUNBRELLA 'BEAUFORT SAGEBRUSH'

31.1 CANVAS AWNING, SUNBRELLA. BRACKET DESIGN AS APPROVED BY ARCHITECT. BLDG. C

BRACKET (SEMI-GLOSS) COLOR: SUNBRELLA 'BASIL'

33.4 TILE WALL BASE @ BLDG. C PER DETAIL, RANDOM TALAVERA TILE. 4.24" SW. BLUE AND WHITE EXTERIOR STAIR TREADS AND BALCONY: PETRAIA LOTTO GRIP PORCELAIN. A852734. CUT

NOSING TO 1-1/2"


REVISION SCHEDULE


NO. DESCRIPTION DATE


EAST ELEVATION



ORTEGA STREET

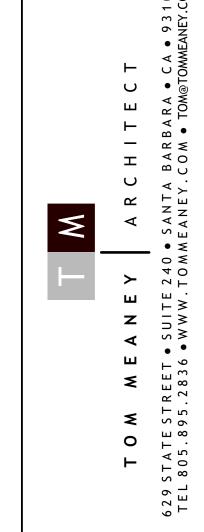

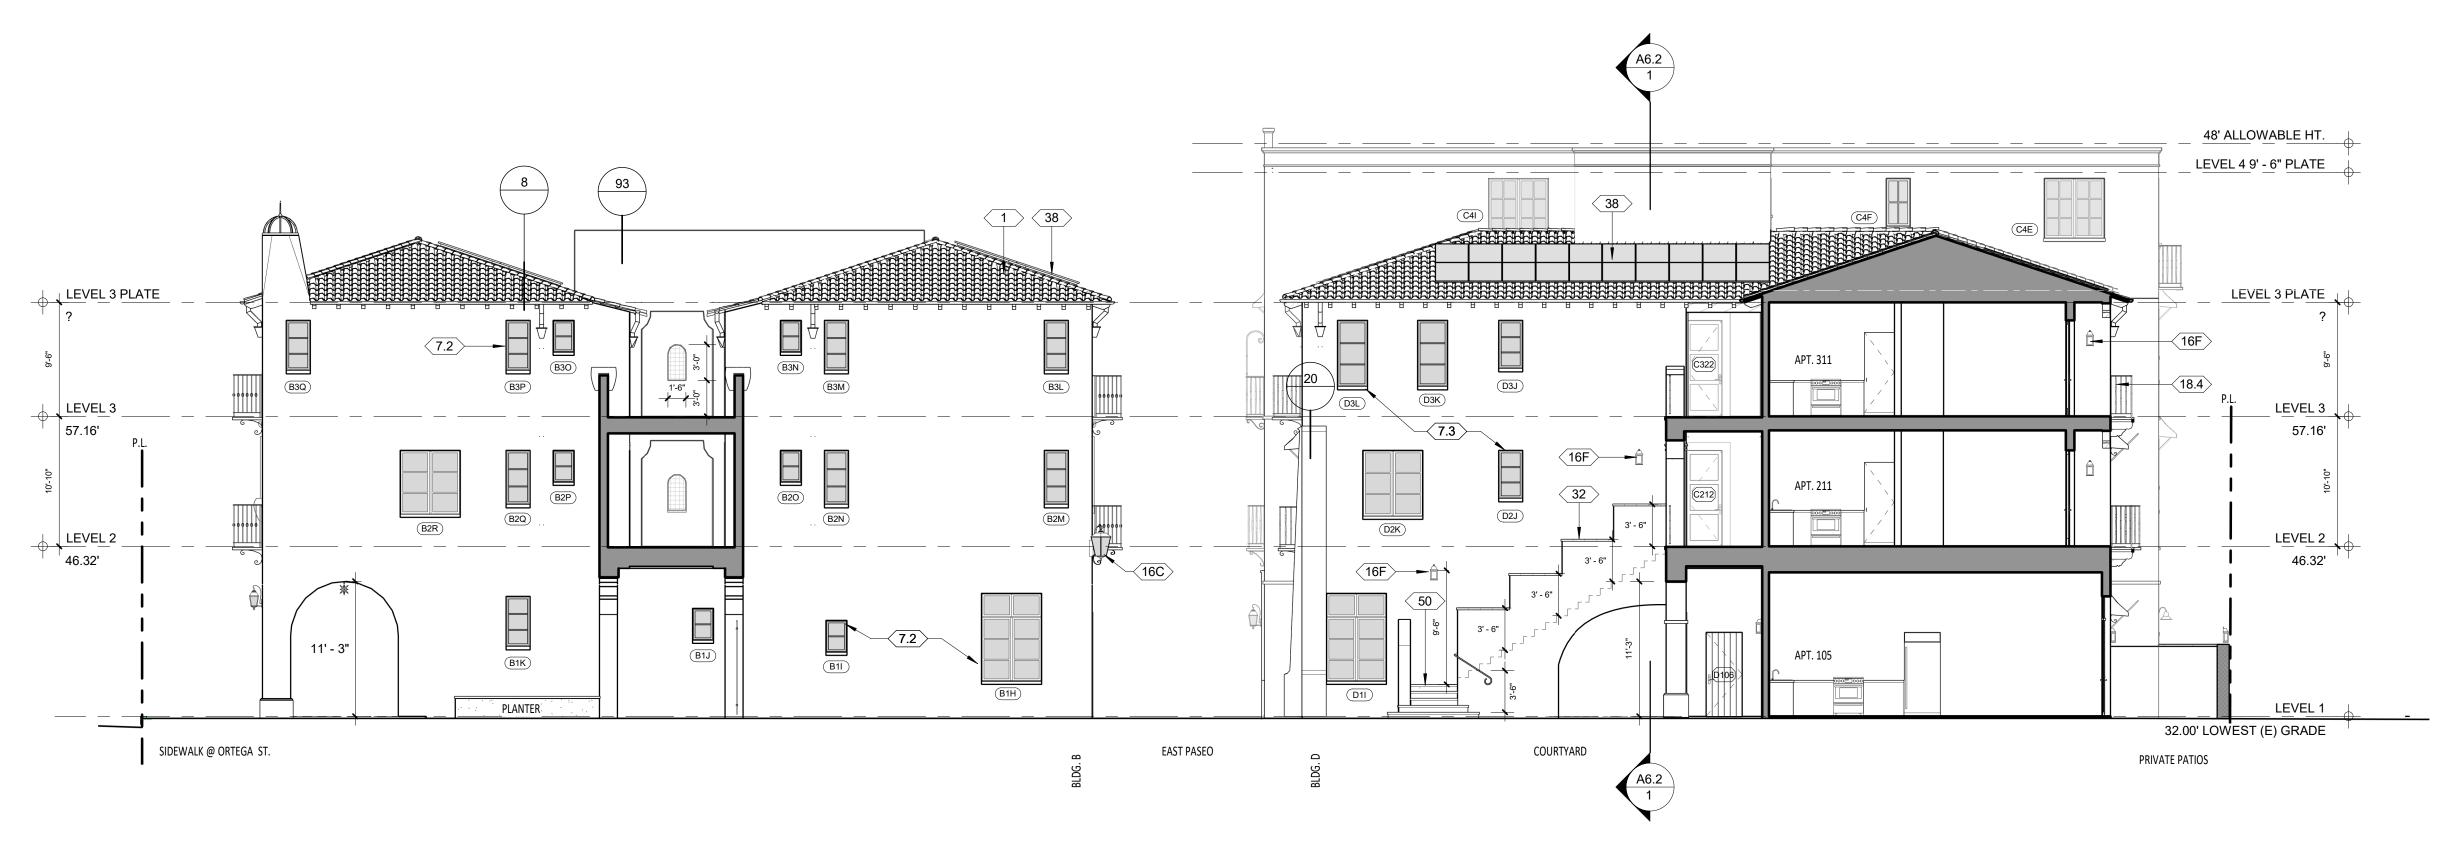

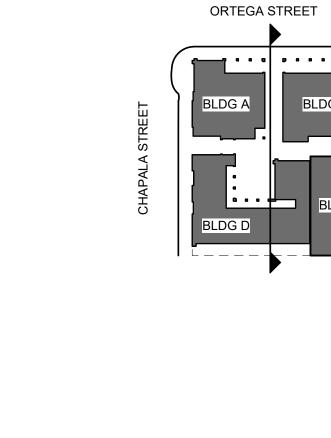

WEST COURTYARD ELEVATION

SCH LOWIST E, ONCO.

SCHOOL STORE ST

BLDG D
BLDG C

ORTEGA STREET

BLDG A

BLDG B

COL

OVERALL
COURTYARD EXT.
ELEVATIONS

No. C14606
Renew 8/31/25

No. C14606
Renew 8/31/25

No. C14606

Date 2024-04
Scale As indicated Drawn

SHEET NO.

EXTERIOR FINISHES

GRADE LINE SHOWN FOR SCHEMATIC PURPOSES. REFER TO CIVIL ENGINEER'S PLANS TYP.

EXTERIOR SIGNAGE NOT SHOWN. UNDER SEPARATE PERMIT REFER TO STRUCTURAL PLANS FOR FOUNDATION AND SLAB INFORMATION

REFER TO ELECTRICAL PLANS FOR ALL EXTERIOR LIGHTING FIXTURES, NOTES AND WIRING CONTROL JOINTS NOT SHOWN BUT SHALL MEET THE FOLLOWING REQUIREMENTS NO PANELS OR SECTIONS SHALL EXCEED A SQUARE AREA OF 144 S.F.

DISTANCE BETWEEN CONTROL JOINTS SHALL NOT EXCEED 16' U.N.O. BY E.O.R. CONTROL JOINTS SHALL BE LOCATED ON BOTH SIDES OF OPENINGS LARGER THAN 6'-0" U.N.O. BY E.O.R.

CONTROL JOINTS SHALL BE LOCATED AT AT LEAST ONE SIDE OF OPENINGS SMALLER

THAN 6'-0" U.N.O. BY E.O.R. F. SEE FINISH SCHEDULE FOR COLORS AND MATERIALS CLASS A ROOF, TILE CAPS AND STARTER PAN, REMAINING PANS NEW TO MATCH SUPPLIED. REDLANDS - VERIFY W/ARCHITECT. STAGGER TILE FIELD, WIRED INSTALLATION, STACK EAVE TILES TWO HIGH WITH STAGGERED OVERHANG TOP TILE OF 1"-3" MORTAR BIRDS MOUTH OPEING TO PREVENT THE INSTRUSION OF POTENTIAL FLAMES AND EMBERS, OVER EXTERIOR PLY AND 2 LAYERS CLASS A WATERPROOF BITUMINOUS UNDERLAYMENT (1 LAYER BASE SHEET NAILED AND 1 LAYER GRANULATED TOP SHEET TORCH DOWN), VALLEY FLASHING 26 GAUGE MIN. CORROSION RESISTANT SHEET METAL OVER 36" MIN. WIDE UNDERLAYMENT OF 72# MINERAL-SURFACED NON-PERFORMANCE CAP SHEET (ASTM D3909) RUN FULL LENGTH OF VALLEY. DETAIL 5/A10.1

7/8" EXTERIOR PLASTER, PAINTED COLOR: WARM WHITE - VERIFY TEXURE WITH ARCHITECT. PROVIDE SAMPLES IN FIELD. TIGHT HAND FORMED CORNERS AND SMOOTH STEEL TROWEL FINISH, INTEGRATE FIBERGLASS MESH INTO WET BASE BROWN COAT (OMEGA PRODUCTS INTERNATIONAL CRACK ISOLATION SYSTEM OR EQUIVALENT) OVER METAL LATHE, TYVEK (TWO LAYERS AT SHEAR WALLS) AND EXTERIOR PLY. EXTERIOR WALL FINISH TO EXTEND FROM TOP OF FOUNDATION TO ROOF TERMINATING AT 2" NOMINAL SOLID WOOD BLOCKING BETWEEN RAFTERS AT ALL ROOF OVERHANGS.

7.3 METAL CLAD DOORS AND WINDOWS AT BLDG. C. ARCADIA STEEL LOOK ALUMINUM DUAL LOW E. COLOR: MIDNIGHT BLACK


16D EXT. LIGHT FIXTURE, HIGH EFFICIENCY LED LAMP 25 WATT OR EQUIVALENT MAX, BY BARN LIGHT ELECT. ORIGINAL VENTED GOOSENECK LIGHT, COLOR: BLACK RUST, 12" W/16" EXTENSION

16E EXT. WALL SCONCE LIGHT FIXTURE, HIGH EFFICIENCY LED LAMP W/ OBSCURE GLASS, 25 WATT OR EQUIVALENT MAX. BY HANDLEMAN STUDIOS â€"BOZEMAN â€" SMALL COLOR: BLACK RUST. FLUSH MOUNT

18.3 IRON RAILING @ BLDG. C, PER DETAIL 36. PROVIDE SHOP DRAWINGS. GALVANIZED BLACK 19 RE-USE EXISTING SANDSTONE. 12" VENEER WITH FULL CUT CORNERS PER DETAIL. EXTEND VENEER 6" BELOW GRADE. WEEP SCREED AS REQUIRED OVER FRAMING

31.1 CANVAS AWNING, SUNBRELLA. BRACKET DESIGN AS APPROVED BY ARCHITECT. BLDG. C BRACKET (SEMI-GLOSS) COLOR: SUNBRELLA 'BASIL'

EXTERIOR STAIR TREADS AND BALCONY: PETRAIA LOTTO GRIP PORCELAIN. A852734. CUT NOSING TO 1-1/2"

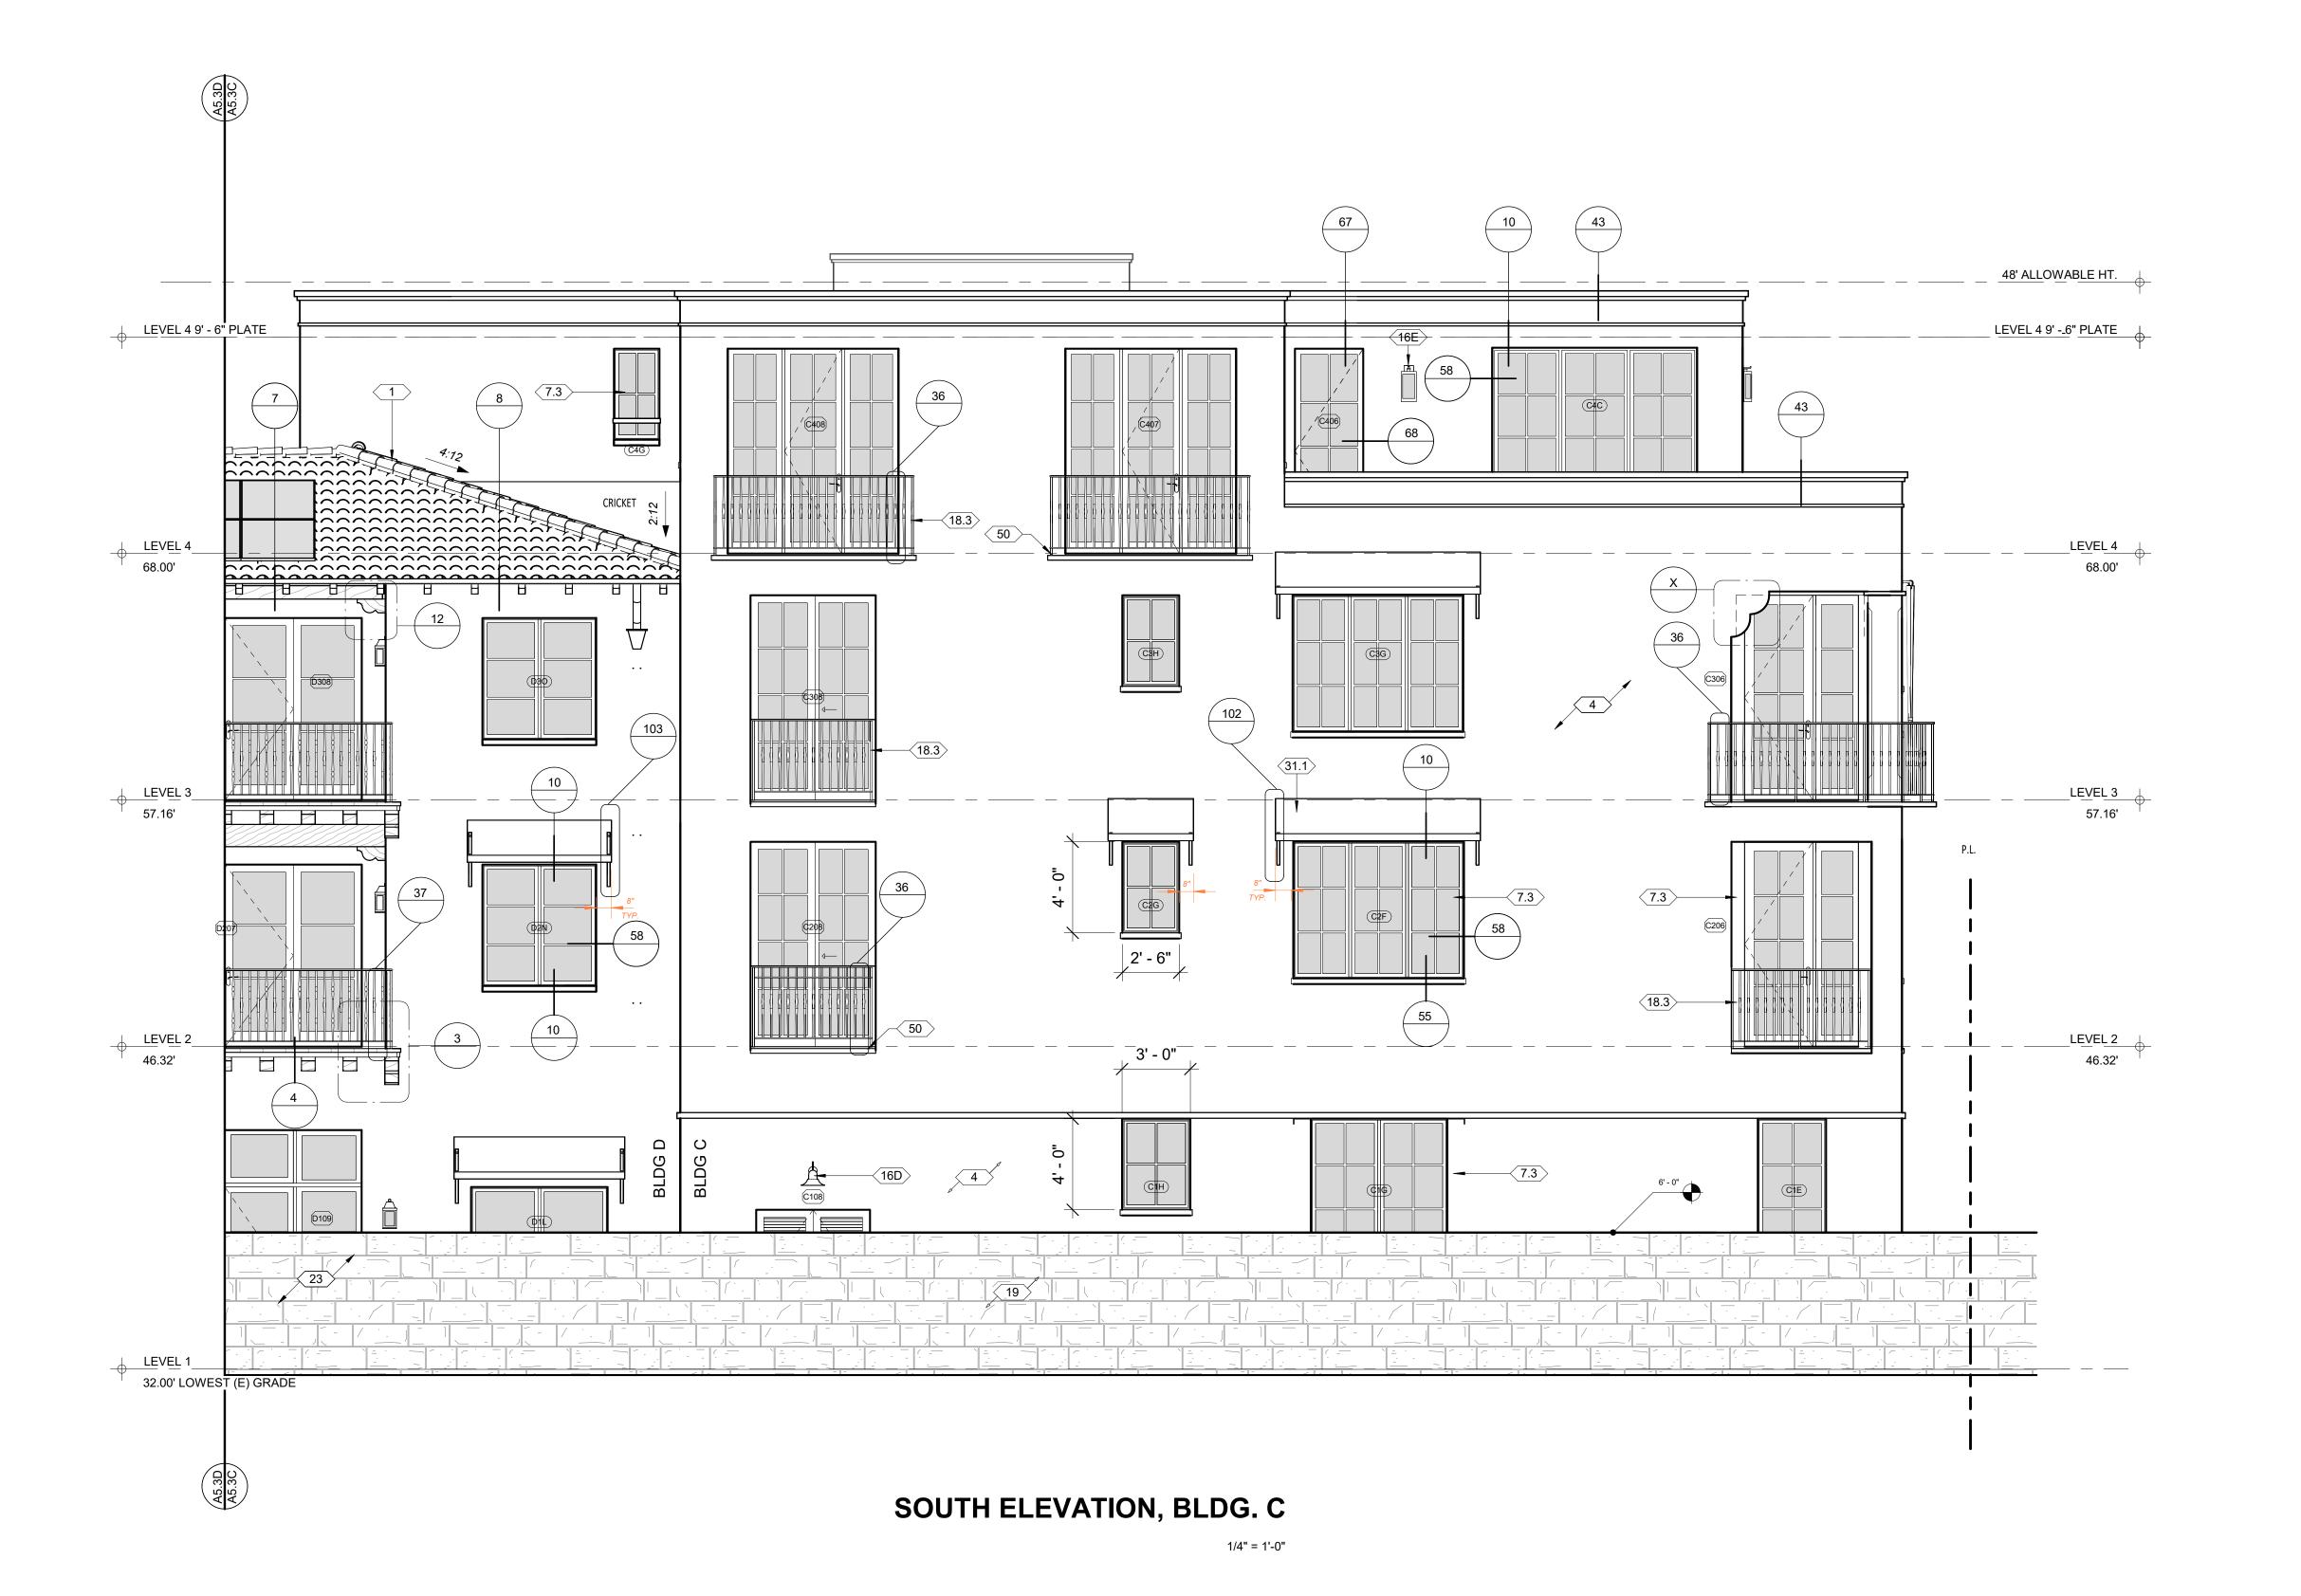

ORTEGA STREET

REVISION SCHEDULE

NO. DESCRIPTION DATE

C

SOUTH ELEVATION BLDG C 1/4"



U.N.O. BY E.O.R.

THAN 6'-0" U.N.O. BY E.O.R.

F. SEE FINISH SCHEDULE FOR COLORS AND MATERIALS

GRADE LINE SHOWN FOR SCHEMATIC PURPOSES. REFER TO CIVIL ENGINEER'S PLANS TYP.

REFER TO ELECTRICAL PLANS FOR ALL EXTERIOR LIGHTING FIXTURES, NOTES AND WIRING

DISTANCE BETWEEN CONTROL JOINTS SHALL NOT EXCEED 16' U.N.O. BY E.O.R.

CONTROL JOINTS SHALL BE LOCATED ON BOTH SIDES OF OPENINGS LARGER THAN 6'-0"

CONTROL JOINTS SHALL BE LOCATED AT AT LEAST ONE SIDE OF OPENINGS SMALLER

EXTERIOR SIGNAGE NOT SHOWN. UNDER SEPARATE PERMIT

REFER TO STRUCTURAL PLANS FOR FOUNDATION AND SLAB INFORMATION

CONTROL JOINTS NOT SHOWN BUT SHALL MEET THE FOLLOWING REQUIREMENTS

NO PANELS OR SECTIONS SHALL EXCEED A SQUARE AREA OF 144 S.F.

NO. DESCRIPTION DATE

C

OPEING TO PREVENT THE INSTRUSION OF POTENTIAL FLAMES AND EMBERS, OVER EXTERIOR PLY AND 2 LAYERS CLASS A WATERPROOF BITUMINOUS UNDERLAYMENT (1 LAYER BASE SHEET NAILED AND 1 LAYER GRANULATED TOP SHEET TORCH DOWN), VALLEY FLASHING 26 GAUGE MIN. CORROSION RESISTANT SHEET METAL OVER 36" MIN. WIDE UNDERLAYMENT OF 72# MINERAL-SURFACED NON-PERFORMANCE CAP SHEET (ASTM D3909) RUN FULL LENGTH OF VALLEY. DETAIL 5/A10.1

CLASS A ROOF, TILE CAPS AND STARTER PAN, REMAINING PANS NEW TO MATCH SUPPLIED.

TILES TWO HIGH WITH STAGGERED OVERHANG TOP TILE OF 1"-3" MORTAR BIRDS MOUTH

REDLANDS - VERIFY W/ARCHITECT. STAGGER TILE FIELD, WIRED INSTALLATION, STACK EAVE

5" HALF ROUND COPPER GUTTER W/4" DIA. COPPER DOWNSPOUT, LOCK ON STYLE. COMPATIBLE W/5" GUTTERS TO PREVENT THE ACCUMULATION OF LEAVES AND DEBRIS, CONNECT DRAINAGE TO STORM DRAIN SYSTEM

COPPER COLLECTOR BOX PER DETAIL 97/A10.10

4X8 DOUGLAS FIR ROOF RAFTERS PER STRUCTUREL ENGINEER OR RAFTERS TAILS @ 24" O.C. MAX, U.N.O. SOLID BODY STAIN TO MATCH EAVES

7.3 METAL CLAD DOORS AND WINDOWS AT BLDG. C. ARCADIA STEEL LOOK ALUMINUM DUAL LOW E. COLOR: MIDNIGHT BLACK

7.4 METAL CLAD DOORS AND WINDOWS AT BLDG. D. ANDERSEN E SERIES DUAL LOW E. COLOR:

14 8X8 DOUGLAS FIR BEAM AT DECK PER DETAIL 40/A10.5. 12/A102, 5/A102, SMOOTH TEXTURE. SOLID BODY STAIN COLOR:

EXT WALL SCONCE.LED. HANDELMAN. "CUMBERLAND" SMALL. OBSCURE GLASS.PER PLAN


18.4 IRON RAILING @ BLDG. D, PER DETAIL 37. PROVIDE SHOP DRAWINGS. GALVANIZED BLACK 25 PLASTER BUTTRESS PER DETAIL 20,98,99

31.2 CANVAS AWNING, SUNBRELLA. BRACKET DESIGN AS APPROVED BY ARCHITECT. BLDG. D

BRACKET (SEMI-GLOSS) COLOR: SUNBRELLA 'FERN' 39 TERRA COTTA HEADER PER DETAIL

SUNSHADE STRUCTURE PER STRUCTURAL. SUN SHADE: SHADEMART 8'-9" X 19'-2" APPROX. BEIGE TRIANGLE SUN SHADE SAIL SMSLT CANOPY FABRIC CLOTH SCREEN, VERIFY W/ ARCHITECT

46 BRICK HEAD PER DETAIL 56/A10.7

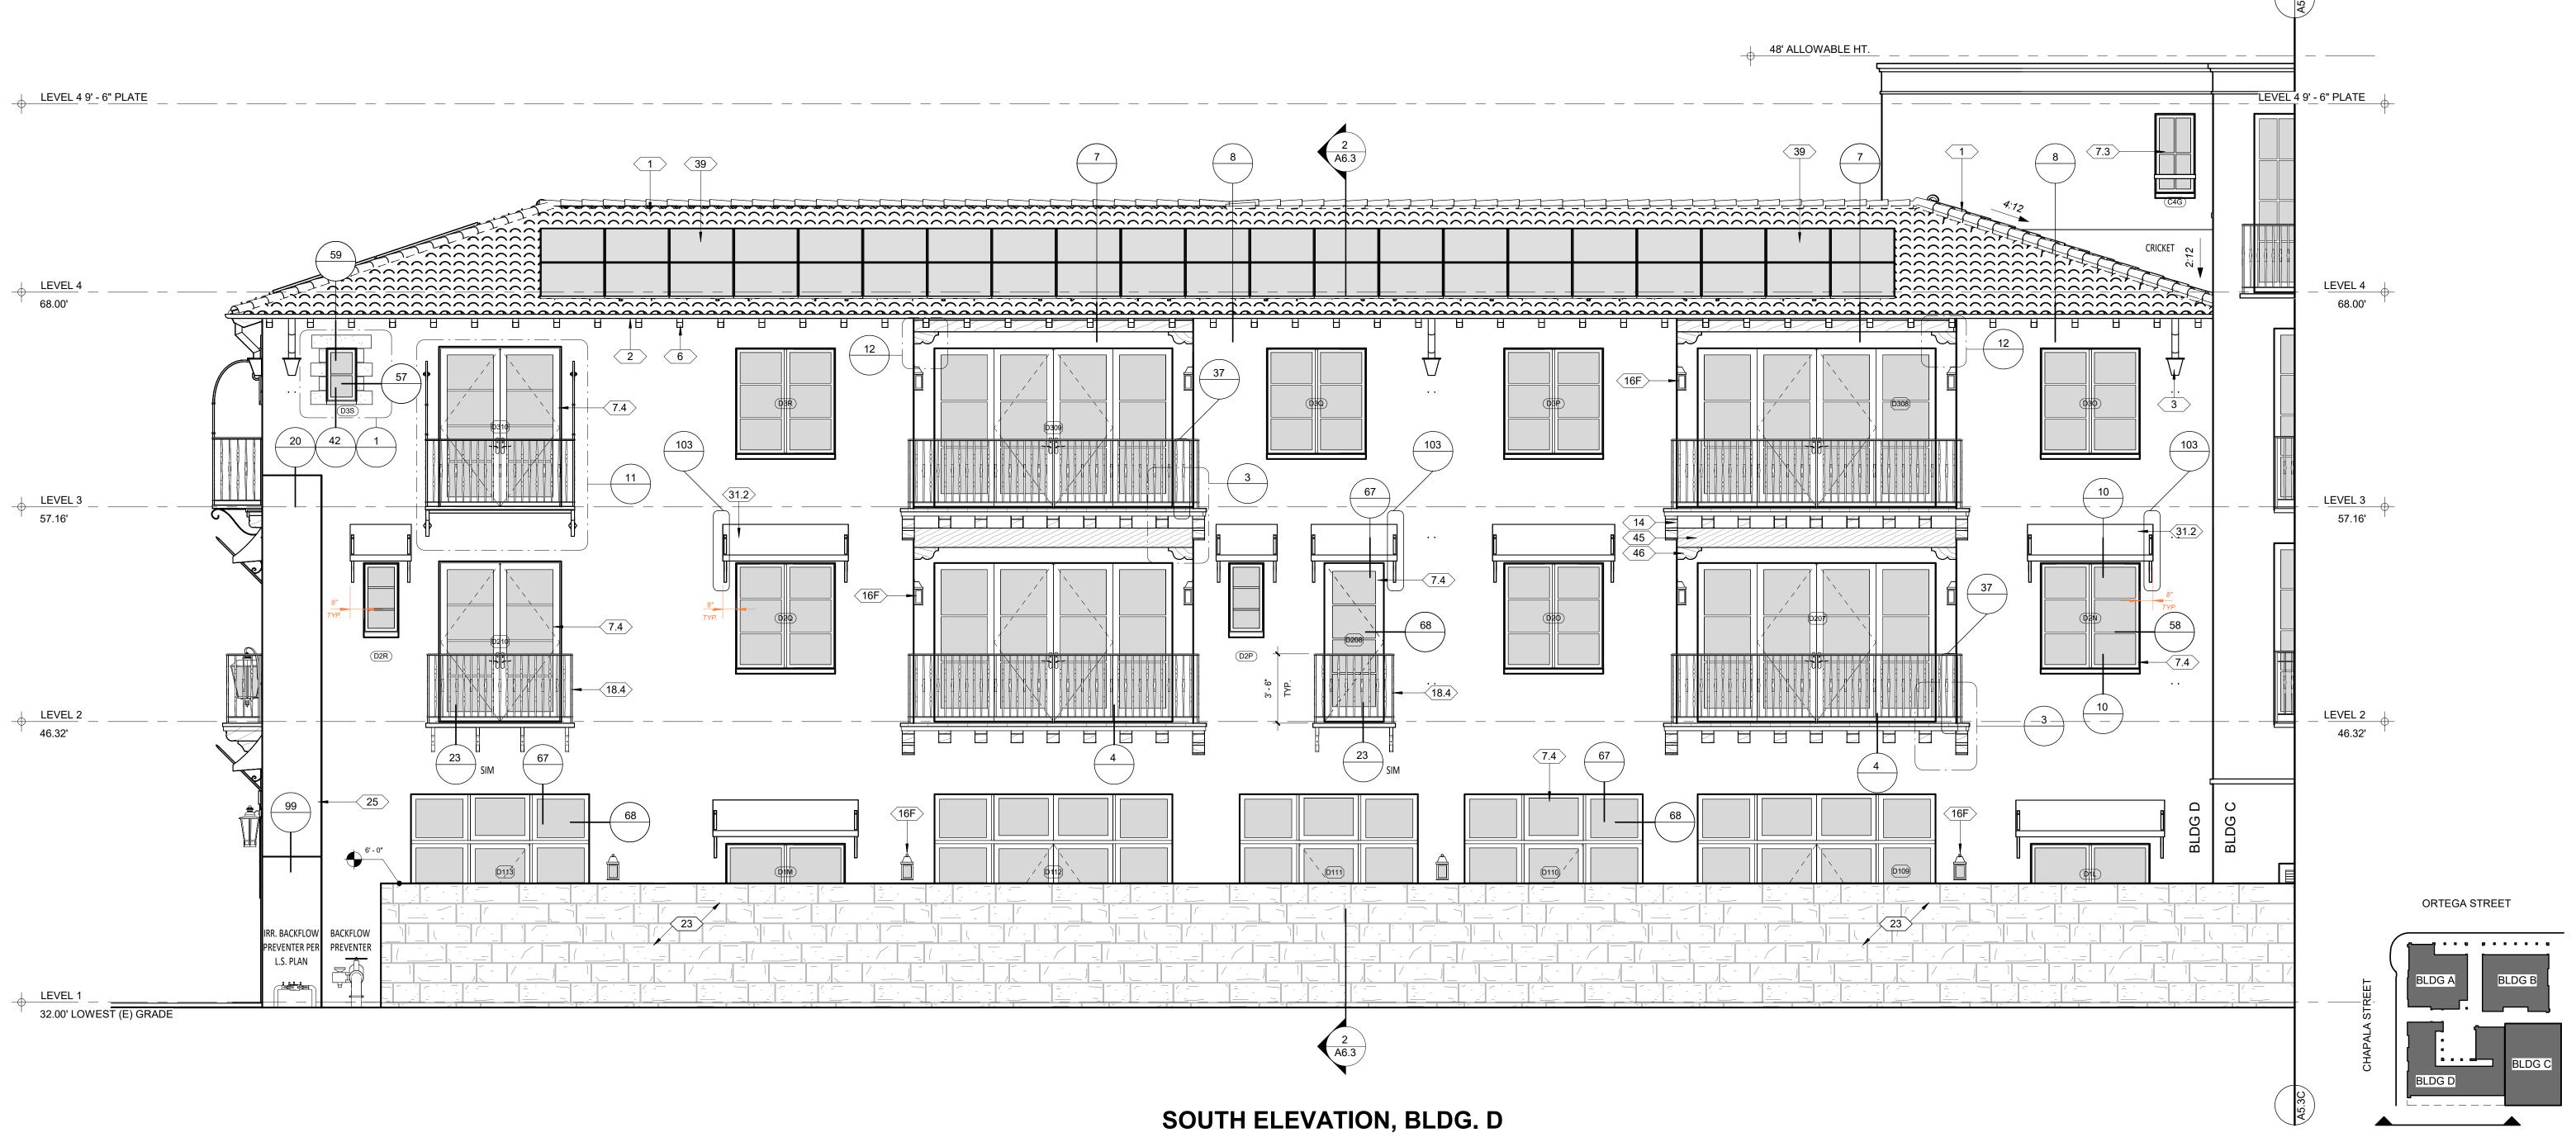

SOUTH ELEVATION



_ 48' ALLOWABLE HT.

LEVEL 4 9' -_6" PLATE

LEVEL 3

LEVEL 1 32.00' LOWEST (E) GRADE

SIDEWALK @ ORTEGA ST.

PLANTER


COURTYARD

46.32'

LEVEL 1

32.00' LOWEST (E) GRADE

PRIVATE PATIOS

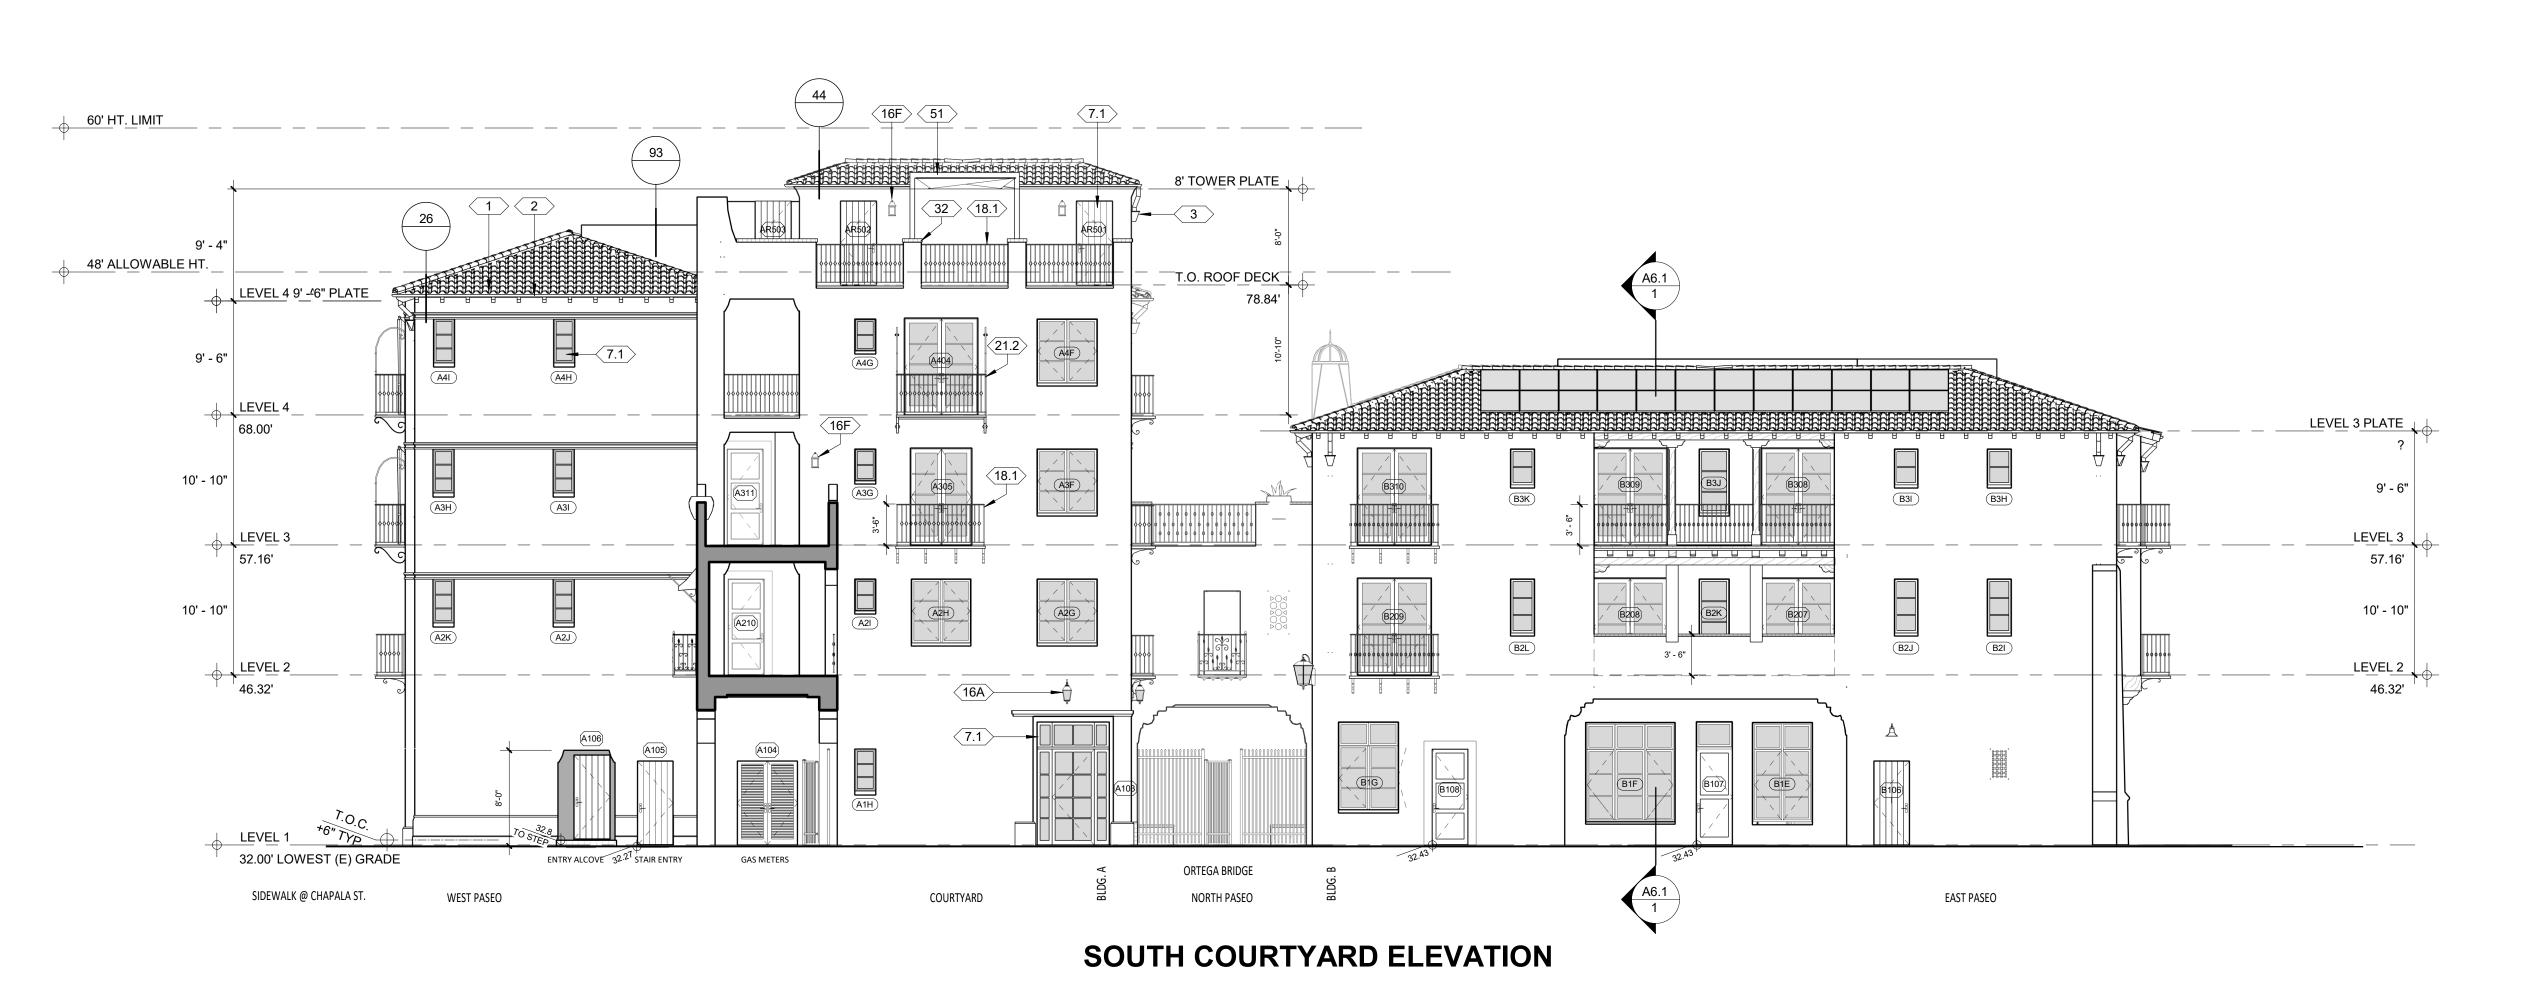

BLDG D BLDG C

ORTEGA STREET

Date
Scale
Drawn

SHEET NO.

A5.4

OVERALL COURTYARD EXTERIOR ELEVATIONS EXTERIOR SIGNAGE NOT SHOWN. UNDER SEPARATE PERMIT

REFER TO STRUCTURAL PLANS FOR FOUNDATION AND SLAB INFORMATION
REFER TO ELECTRICAL PLANS FOR ALL EXTERIOR LIGHTING FIXTURES, NOTES AND WIRING
CONTROL JOINTS NOT SHOWN BUT SHALL MEET THE FOLLOWING REQUIREMENTS

NO PANELS OR SECTIONS SHALL EXCEED A SQUARE AREA OF 144 S.F.
 DISTANCE BETWEEN CONTROL JOINTS SHALL NOT EXCEED 16' U.N.O. BY E.O.R.
 CONTROL JOINTS SHALL BE LOCATED ON BOTH SIDES OF OPENINGS LARGER THAN 6'-0"

U.N.O. BY E.O.R.
4. CONTROL JOINTS SHALL BE LOCATED AT AT LEAST ONE SIDE OF OPENINGS SMALLER

THAN 6'-0" U.N.O. BY E.O.R.

F. SEE FINISH SCHEDULE FOR COLORS AND MATERIALS

48' ALLOWABLE HT. LEVEL 4 9' -46" PLATE LEVEL 4 ___3RØ FL. 9'-7" PLATE 4

WEST ELEVATION @ CHAPALA ST., BLDG A

EXTERIOR FINISHES

1 CLASS A ROOF, TILE CAPS AND STARTER PAN, REMAINING PANS NEW TO MATCH SUPPLIED. REDLANDS - VERIFY W/ARCHITECT. STAGGER TILE FIELD, WIRED INSTALLATION, STACK EAVE TILES TWO HIGH WITH STAGGERED OVERHANG TOP TILE OF 1"-3" MORTAR BIRDS MOUTH OPEING TO PREVENT THE INSTRUSION OF POTENTIAL FLAMES AND EMBERS, OVER EXTERIOR PLY AND 2 LAYERS CLASS A WATERPROOF BITUMINOUS UNDERLAYMENT (1 LAYER BASE SHEET NAILED AND 1 LAYER GRANULATED TOP SHEET TORCH DOWN), VALLEY FLASHING 26 GAUGE MIN. CORROSION RESISTANT SHEET METAL OVER 36" MIN. WIDE UNDERLAYMENT OF 72# MINERAL-SURFACED NON-PERFORMANCE CAP SHEET (ASTM D3909) RUN FULL LENGTH OF VALLEY. DETAIL 5/A10.1

5" HALF ROUND COPPER GUTTER W/4" DIA. COPPER DOWNSPOUT, LOCK ON STYLE, COMPATIBLE W/ 5" GUTTERS TO PREVENT THE ACCUMULATION OF LEAVES AND DEBRIS, CONNECT DRAINAGE TO STORM DRAIN SYSTEM

3 COPPER COLLECTOR BOX PER DETAIL 97/A10.10

5 2X6 T&G KILN DRIED DOUGLAS FIR EAVES PER DETAIL 8/A10.1, SMOOTH TEXTURE, SOLID BODY, STAIN COLOR: VERIFY W/ARCHITECT.

7.1 METAL CLAD DOORS AND WINDOWS AT BLDG. A. ANDERSEN E SERIES DUAL LOW E. COLOR: OLIVE

METAL CLAD DOORS AND WINDOWS @ BRIDGES, ANDERSEN E SERIES DUAL LOW E. COLOR: 'MOODY BLUE'

DYNAMIC 'ARTE ALUMINUM' STOREFRONT DOOR OR WINDOW PER DETAIL. MATCH BUILDING WINDOW COLOR

GFRC DECORATIVE PLASTER GRILLE PER DETAILS. SUPPLY: PACIFIC REGISTER COMPANY

DOUGLAS FIR CORBEL PER DETAIL 12/A10.2, SOLID BODY STAIN COLOR: ______

C EXT. WALL MOUNTED INDIRECT CORNER LIGHT FIXTURE, HIGH EFFICIENCY LED LAMP W/
OBSCURE GLASS, 25 WATT OR EQUIVALENT MAX. BY HANDLEMAN STUDIOS 'ARLINGTON' LARGE

COLOR: BLACK RUST, 16" X12".

18.1 IRON RAILING @ BLDG. A, PER DETAIL 34. PROVIDE SHOP DRAWINGS. GALVANIZED BLACK

18.5 IRON RAILING @ BRIDGES, PER DETAIL 38. PROVIDE SHOP DRAWINGS. GALVANIZED BLACK

WEEP SCREED, PROFILE TO ALLOW PLASTER BELOW SCREED PER DETAIL. PROVIDE 26 GAUGE MIN. GALVANIZED WEEP SCREED AT FOUNDATION, 4" MIN. ABOVE GRADE OR 2†MIN. ABOVE CONCRETE/PAVING WHERE OCCURS PER DET 21

21 NOT USED

21.4 IRON BALCONY 4 PER DETAIL 39. PROVIDE SHOP DRAWINGS. GALVANIZED. BLACK SEMI GLOSS

29.1 CANVAS CURTAIN, STEEL ROD BLACK SEMI-GLOSS. BLDG. A COLOR: SUNBRELLA 'DUBONNET TWEED'

31.4 CANVAS AWNING, SUNBRELLA. BRACKET DESIGN AS APPROVED BY ARCHITECT. CHAPALA BRIDGE BRACKET (SEMI-GLOSS) COLOR: SUNBRELLA 'BASIL'

33.1 TILE WALL BASE @ BLDG. A PER DETAIL. TALAVERA, 'CAJEME' 6" SQ.

35.3 POT, GLADDING MCBEAN MODEL 156.23, ORTEGA BRIDGE (X2) COLOR: GLADDEN MCBEAN 'CAVERN CLAY'

35.4 POT, GLADDING MCBEAN MODEL 156.23, CHAPALA BRIDGE COLOR: GLADDEN MCBEAN 'CAVERN CLAY'

37 VW EMBLEM GFRC 30" DIAMETER

42 FORMED PLASTER SURROUND PER DETAIL

8X8 DOUGLAS FIR CORBEL PER DETAIL, SMOOTH TEXTURE. SOLID BODY STAIN COLOR: ____

51 SUNSHADE STRUCTURE PER STRUCTURAL. SUN SHADE: SHADEMART 8'-9" X 19'-2" APPROX. BEIGE TRIANGLE SUN SHADE SAIL SMSLT CANOPY FABRIC CLOTH SCREEN, VERIFY W/ARCHITECT

57 GFRC DRYER WALL VENT PER DETAIL 105



ORTEGA STREET

WEST ELEVATION

Date 2024-04Scale As indicated
Drawn A

SHEET NO.

A 5 4 4

GRADE LINE SHOWN FOR SCHEMATIC PURPOSES. REFER TO CIVIL ENGINEER'S PLANS TYP. EXTERIOR SIGNAGE NOT SHOWN. UNDER SEPARATE PERMIT

REFER TO STRUCTURAL PLANS FOR FOUNDATION AND SLAB INFORMATION REFER TO ELECTRICAL PLANS FOR ALL EXTERIOR LIGHTING FIXTURES, NOTES AND WIRING

CONTROL JOINTS NOT SHOWN BUT SHALL MEET THE FOLLOWING REQUIREMENTS NO PANELS OR SECTIONS SHALL EXCEED A SQUARE AREA OF 144 S.F. DISTANCE BETWEEN CONTROL JOINTS SHALL NOT EXCEED 16' U.N.O. BY E.O.R.

CONTROL JOINTS SHALL BE LOCATED ON BOTH SIDES OF OPENINGS LARGER THAN 6'-0" U.N.O. BY E.O.R.

CONTROL JOINTS SHALL BE LOCATED AT AT LEAST ONE SIDE OF OPENINGS SMALLER

THAN 6'-0" U.N.O. BY E.O.R. F. SEE FINISH SCHEDULE FOR COLORS AND MATERIALS CLASS A ROOF, TILE CAPS AND STARTER PAN, REMAINING PANS NEW TO MATCH SUPPLIED. REDLANDS - VERIFY W/ARCHITECT. STAGGER TILE FIELD, WIRED INSTALLATION, STACK EAVE TILES TWO HIGH WITH STAGGERED OVERHANG TOP TILE OF 1"-3" MORTAR BIRDS MOUTH OPEING TO PREVENT THE INSTRUSION OF POTENTIAL FLAMES AND EMBERS, OVER EXTERIOR PLY AND 2 LAYERS CLASS A WATERPROOF BITUMINOUS UNDERLAYMENT (1 LAYER BASE SHEET NAILED AND 1 LAYER GRANULATED TOP SHEET TORCH DOWN), VALLEY FLASHING 26 GAUGE MIN. CORROSION RESISTANT SHEET METAL OVER 36" MIN. WIDE UNDERLAYMENT OF 72# MINERAL-SURFACED NON-PERFORMANCE CAP SHEET (ASTM D3909) RUN FULL LENGTH OF VALLEY. DETAIL 5/A10.1

EXTERIOR FINISHES

5" HALF ROUND COPPER GUTTER W/4" DIA. COPPER DOWNSPOUT, LOCK ON STYLE, COMPATIBLE W/5" GUTTERS TO PREVENT THE ACCUMULATION OF LEAVES AND DEBRIS. CONNECT DRAINAGE TO STORM DRAIN SYSTEM

COPPER COLLECTOR BOX PER DETAIL 97/A10.10

7/8" EXTERIOR PLASTER, PAINTED COLOR: WARM WHITE - VERIFY TEXURE WITH ARCHITECT. PROVIDE SAMPLES IN FIELD. TIGHT HAND FORMED CORNERS AND SMOOTH STEEL TROWEL FINISH, INTEGRATE FIBERGLASS MESH INTO WET BASE BROWN COAT (OMEGA PRODUCTS INTERNATIONAL CRACK ISOLATION SYSTEM OR EQUIVALENT) OVER METAL LATHE, TYVEK (TWO LAYERS AT SHEAR WALLS) AND EXTERIOR PLY. EXTERIOR WALL FINISH TO EXTEND FROM TOP OF FOUNDATION TO ROOF TERMINATING AT 2" NOMINAL SOLID WOOD BLOCKING BETWEEN RAFTERS AT ALL ROOF OVERHANGS.

4X8 DOUGLAS FIR ROOF RAFTERS PER STRUCTUREL ENGINEER OR RAFTERS TAILS @ 24" O.C. MAX, U.N.O. SOLID BODY STAIN TO MATCH EAVES

METAL CLAD DOORS AND WINDOWS AT BLDG. D. ANDERSEN E SERIES DUAL LOW E. COLOR:

METAL CLAD DOORS AND WINDOWS @ BRIDGES, ANDERSEN E SERIES DUAL LOW E. COLOR:

DYNAMIC 'ARTE ALUMINUM' STOREFRONT DOOR OR WINDOW PER DETAIL. MATCH BUILDING WINDOW COLOR

GFRC DECORATIVE PLASTER GRILLE PER DETAILS. SUPPLY: PACIFIC REGISTER COMPANY

DOUGLAS FIR CORBEL PER DETAIL 12/A10.2, SOLID BODY STAIN COLOR: 8X8 DOUGLAS FIR BEAM AT DECK PER DETAIL 40/A10.5. 12/A102, 5/A102, SMOOTH TEXTURE. SOLID BODY STAIN COLOR:

EXT. WALL MOUNTED INDIRECT LIGHT FIXTURE, HIGH EFFICIENCY LED LAMP W/SHIELDED GLASS, 25 WATT OR EQUIVALENT MAX. BY HANDLEMAN STUDIOS 'ANACAPA-MEDIUM' COLOR: BLACK RUST, 10"X28". OBSCURE GLASS

16C EXT. WALL MOUNTED INDIRECT CORNER LIGHT FIXTURE, HIGH EFFICIENCY LED LAMP W/ OBSCURE GLASS, 25 WATT OR EQUIVALENT MAX. BY HANDLEMAN STUDIOS 'ARLINGTON' LARGE COLOR: BLACK RUST, 16" X12".

18.4 IRON RAILING @ BLDG. D, PER DETAIL 37. PROVIDE SHOP DRAWINGS. GALVANIZED BLACK

18.5 IRON RAILING @ BRIDGES, PER DETAIL 38. PROVIDE SHOP DRAWINGS. GALVANIZED BLACK 19 RE-USE EXISTING SANDSTONE. 12" VENEER WITH FULL CUT CORNERS PER DETAIL. EXTEND

VENEER 6" BELOW GRADE. WEEP SCREED AS REQUIRED OVER FRAMING WEEP SCREED, PROFILE TO ALLOW PLASTER BELOW SCREED PER DETAIL. PROVIDE 26 GAUGE

MIN. GALVANIZED WEEP SCREED AT FOUNDATION, 4" MIN. ABOVE GRADE OR 2†MIN. ABOVE CONCRETE/PAVING WHERE OCCURS PER DET 21

21.4 IRON BALCONY 4 PER DETAIL 39. PROVIDE SHOP DRAWINGS. GALVANIZED. BLACK SEMI GLOSS HAMMERED STONE VENEER SURROUND PER DETAIL, OVER SCRATCH COAT, FULL CORNERS.

REUSE EXISTING STONE

25 PLASTER BUTTRESS PER DETAIL 20,98,99

NOT USED

31.2 CANVAS AWNING, SUNBRELLA, BRACKET DESIGN AS APPROVED BY ARCHITECT, BLDG, D


31.4 CANVAS AWNING, SUNBRELLA. BRACKET DESIGN AS APPROVED BY ARCHITECT. CHAPALA

35.4 POT, GLADDING MCBEAN MODEL 156.23, CHAPALA BRIDGE COLOR: GLADDEN MCBEAN 'CAVERN

SUNSHADE STRUCTURE PER STRUCTURAL. SUN SHADE: SHADEMART 8'-9" X 19'-2" APPROX. BEIGE TRIANGLE SUN SHADE SAIL SMSLT CANOPY FABRIC CLOTH SCREEN. VERIFY W/

EXTERIOR BALCONY: PETRAIA LOTTO GRIP PORCELAIN 13X13X3.5. A8527GH. EDGE PER 105

INFRARED HEATERS: INFRATECH WD.60 WH FLUSH MOUNT. WHITE

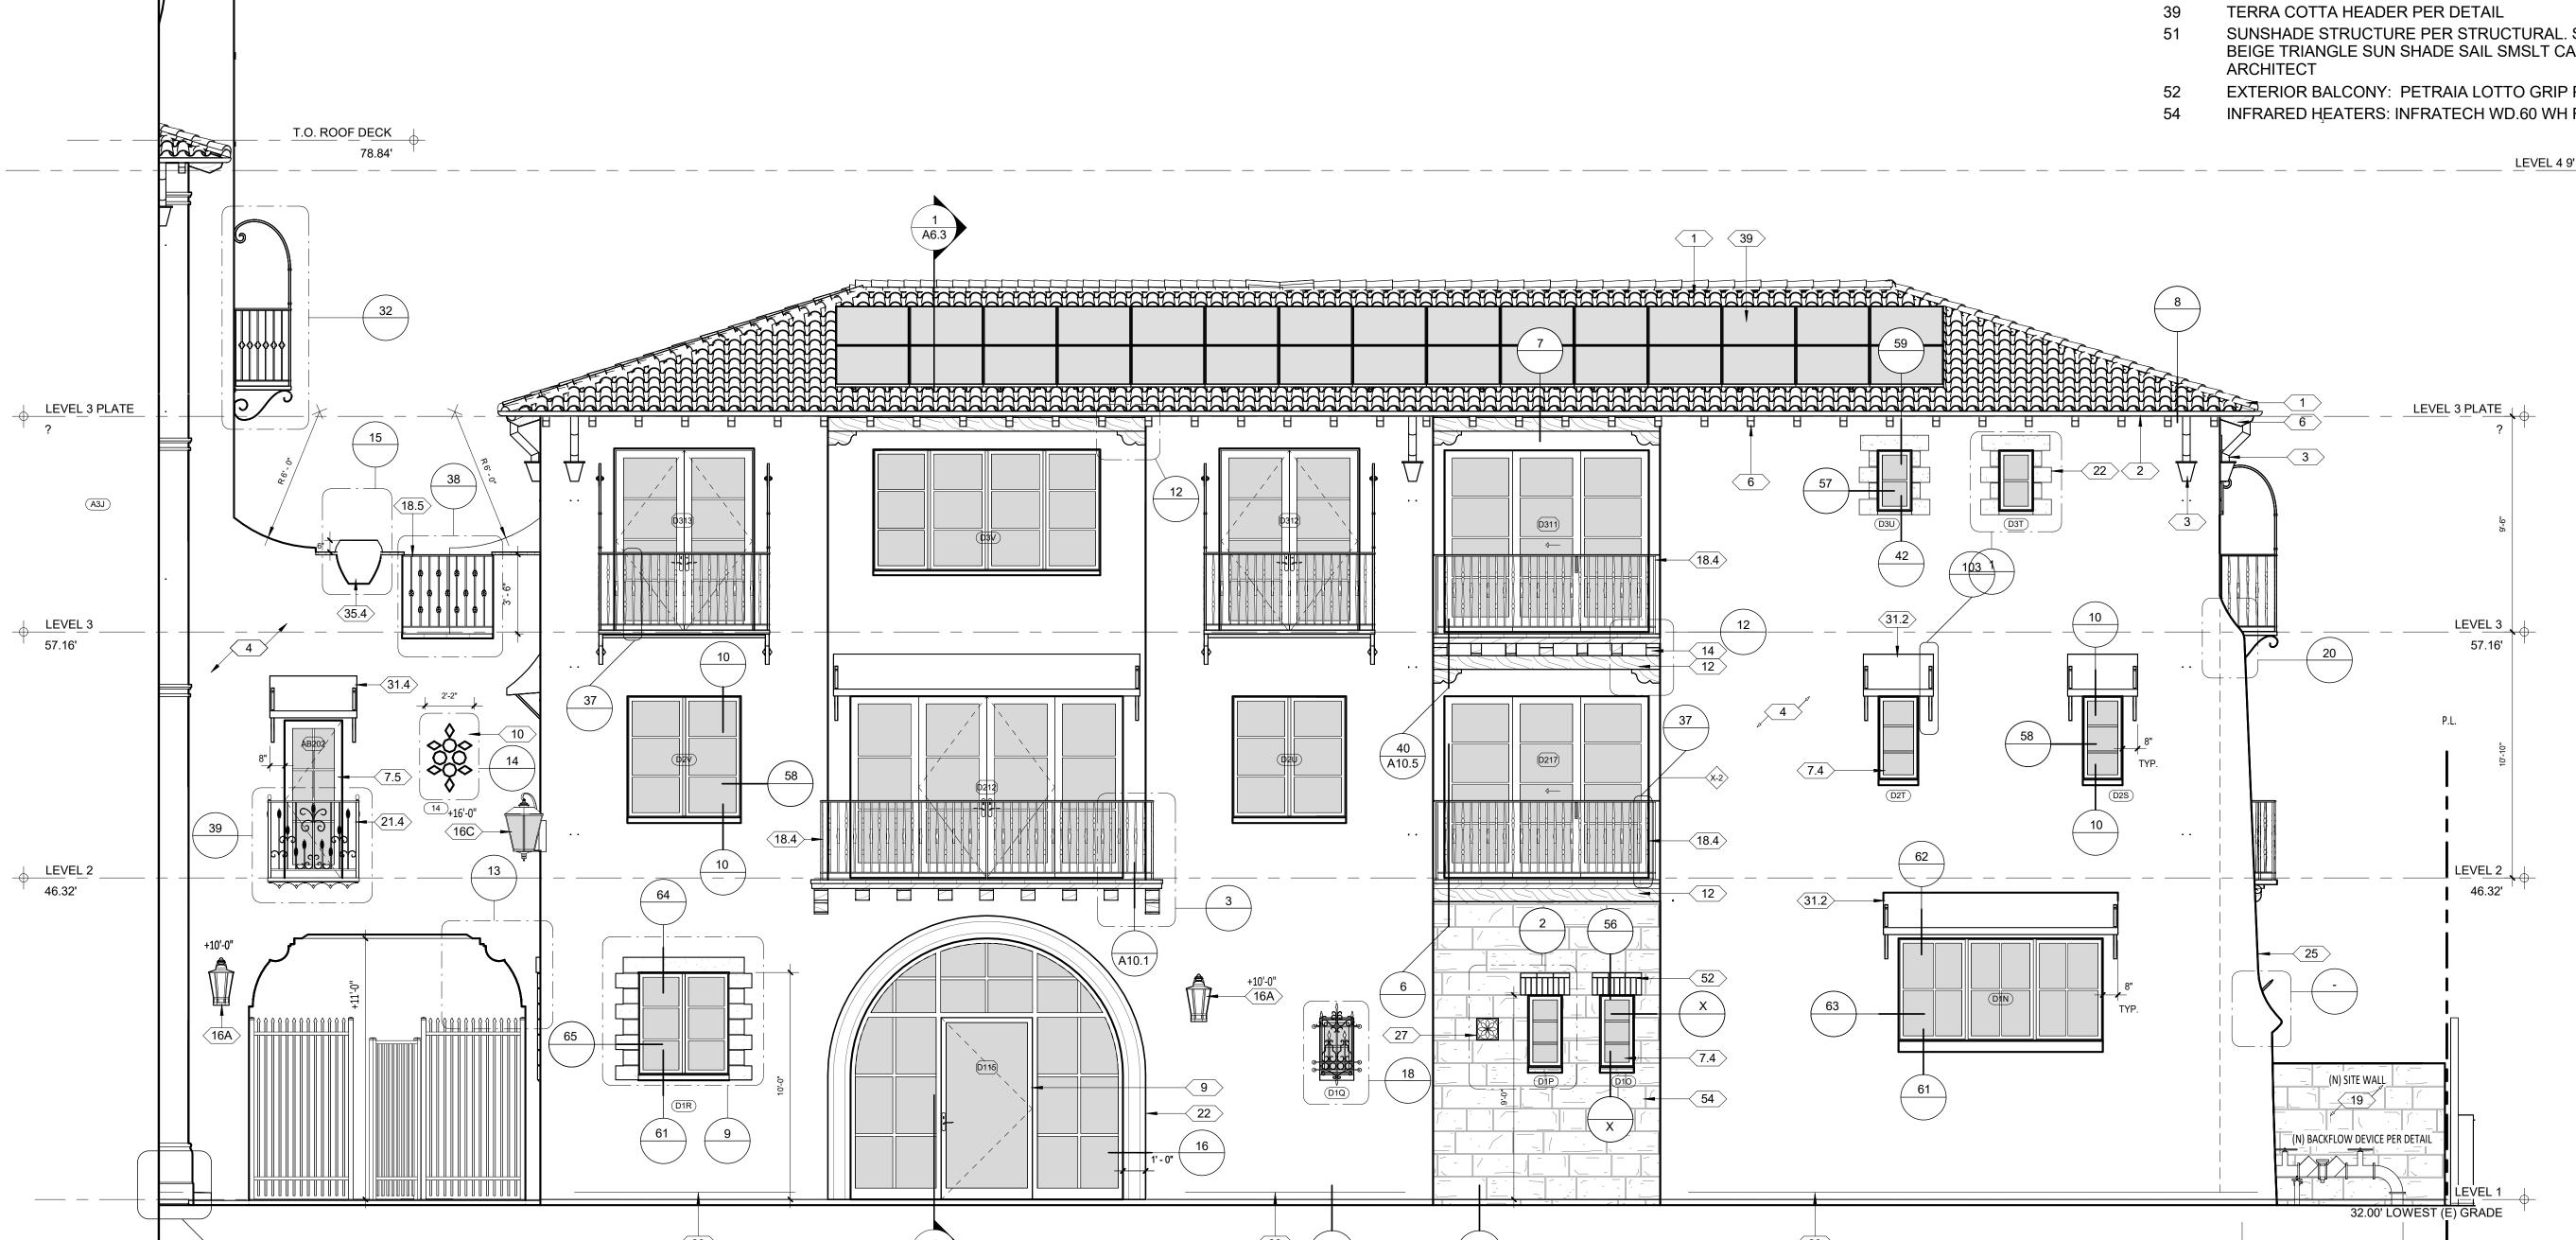

WEST ELEVATION @ CHAPALA ST., BLDG D

ORTEGA STREET

WEST ELEVATION

REVISION SCHEDULE

O. DESCRIPTION DATE

C




ROOF TILE - TYP.



1 - REDLANDS CLAY - CONFIRM COLOR W/ ARCHITECT

EXT. WALL FINISH - TYP.

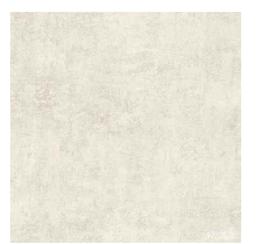

6 - 7/8" EXT. PLASTER



EXTERIOR FLOORING -TYP.

ORTEGA STREET



49 - 12"x12" PORCELAIN TERRA COTTA TILE

EXT. LIGHT FIXTURES

16F - HANDLEMAN STUDIOS -'CUMBERLAND - SMALL'

BUILDING A FINISHES

DOOR / WINDOW COLOR




7.1 - ANDERSON DOORS AND WINDOWS, 'OLIVE'

TILE @ CORNER



33.1, TILE A: TALAVERA 'ATESSA' 4.25"X4.25"

CURTAINS

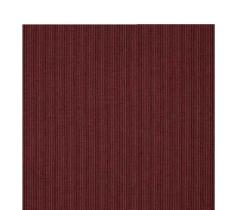

29.1 - SUNBRELLA 'DUBONNET TWEED'





33.2, TILE B: TALAVERA 'CAJEME' 4.25"X4.25"

SUN SHADE



51 - SUN SHADE BY: SHADEMART 'BEIGE'



EXT. PENDENT LIGHTS



53 - POINTED STAR LIGHT

DOOR / WINDOW COLOR



7.5 - ANDERSON DOORS AND WINDOWS, 'WATERCOLOR BLUE'

AWNINGS



CHAPALA BRIDGE FINISHES



BY PAPER LANTERN STORE



31.1 - SUNBRELLA 'SAPHIRE'

EXT. CORNER LIGHT FIXTURES

16C - HANDLEMAN STUDIOS -'ARLINGTON - LARGE'



16J PATIO STRING LIGHT BLACK

CERAMIC PLANTERS





35.1 - GLADDING McBEAN SERIES 156 PLANTER, COLOR: CAVERN CLAY - CONFIRM

BUILDING D FINISHES



DOOR / WINDOW COLOR

ANDERSON DOORS AND WINDOWS, 'SAGE'

AWNINGS



SUNBRELLA 'FERN'








EXTERIOR STONE



54 - SANDSTONE VENEER TO MATCH RE-CLAIMED SITE STONE

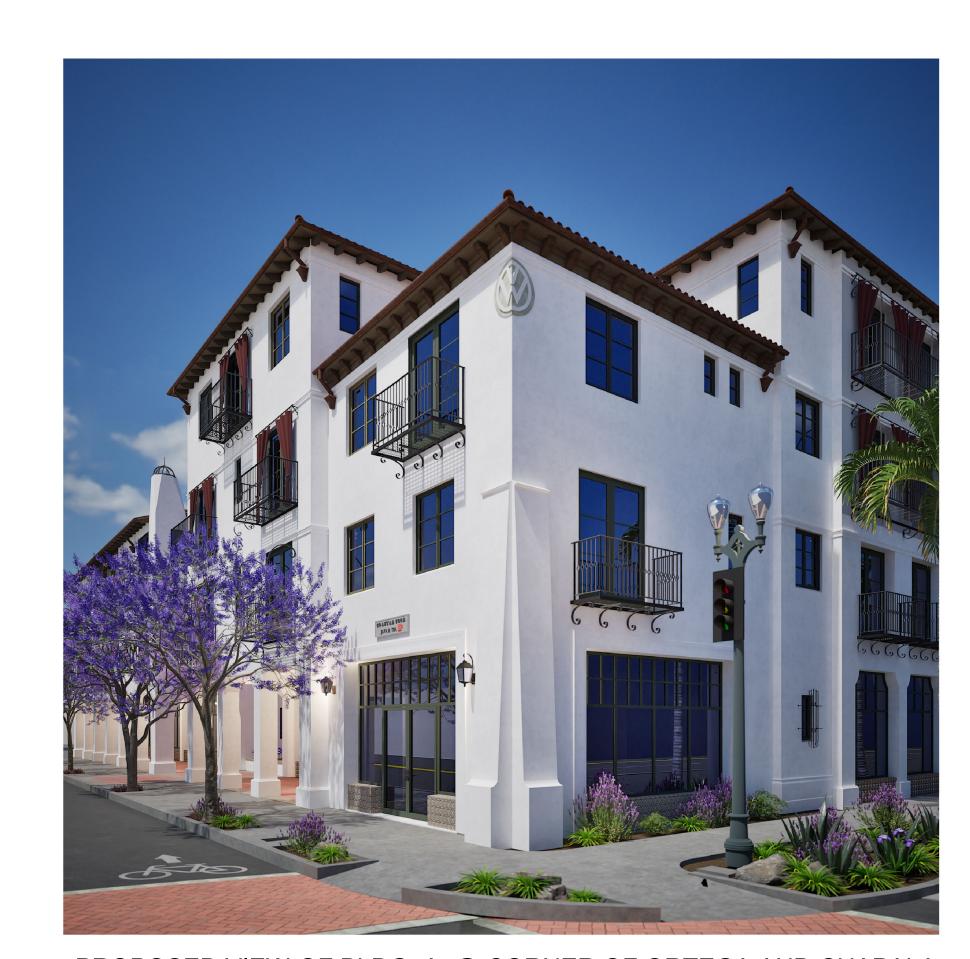

PROPOSED VIEW OF BLDG. A @ CORNER OF ORTEGA AND CHAPALA



PROPOSED VIEW OF BLDGS. A, D AND BRIDGE @ CHAPALA ST.



PROPOSED VIEW OF BLDG. D @ CHAPALA ST.



EXTERIOR FINISHES


NORTH ELEVATION @ ORTEGA ST.

ROOF TILE - TYP.




1 - REDLANDS CLAY - CONFIRM COLOR W/ ARCHITECT

EXT. WALL FINISH - TYP.

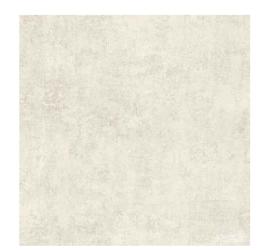

6 - 7/8" EXT. PLASTER



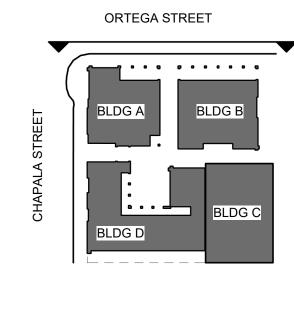

EXTERIOR FLOORING -TYP.



49 - 12"x12" PORCELAIN TERRA COTTA TILE

BUILDING B FINISHES

DOOR / WINDOW COLOR



7.1 - ANDERSON DOORS AND WINDOWS, 'SLATE'

33.1, TILE A: TALAVERA 'ATESSA' 4.25"X4.25"

CERAMIC PLANTERS


TILE @ ARCADE

EXT. LIGHT FIXTURES



16G - HANDLEMAN STUDIOS -

DOOR / WINDOW COLOR

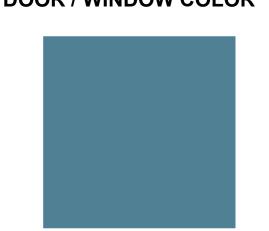

7.5 - ANDERSON DOORS AND WINDOWS, 'WATERCOLOR BLUE'

EXT. CORNER LIGHT FIXTURES



ORTEGA BRIDGE FINISHES




16J PATIO STRING LIGHT BLACK

DOOR / WINDOW COLOR



7.1 - ANDERSON DOORS AND WINDOWS, 'OLIVE'

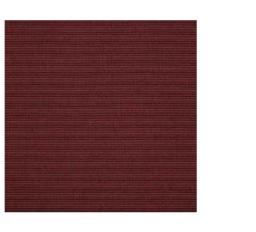

BUILDING A FINISHES

CURTAINS




53 - POINTED STAR LIGHT

EXT. PENDENT LIGHTS

29.1 - SUNBRELLA 'DUBONNET TWEED'

SUN SHADE

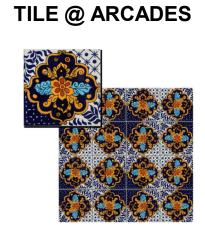

33.2, TILE B: TALAVERA 'CAJEME' 4.25"X4.25"







53 - POINTED STAR LIGHT

35.1 - GLADDING McBEAN SERIES 156 PLANTER, COLOR: HARVEST - CONFIRM



31.1 - SUNBRELLA 'SAPHIRE'

CERAMIC PLANTERS



16C - HANDLEMAN STUDIOS -'ARLINGTON - LARGE'

35.1 - GLADDING McBEAN SERIES 156 PLANTER, COLOR: CAVERN CLAY - CONFIRM



BY PAPER LANTERN STORE

TILE @ CORNER

33.1, TILE A: TALAVERA 'ATESSA' 4.25"X4.25"



51 - SUN SHADE BY: SHADEMART 'BEIGE'



PROPOSED VIEW OF BLDG. B @ ORTEGA ST.



PROPOSED VIEW OF BLDGS. A, B AND BRIDGE @ ORTEGA ST.






PROPOSED VIEW OF BLDG. A @ CORNER OF ORTEGA AND CHAPALA

EXTERIOR FINISHES




1 - REDLANDS CLAY - CONFIRM COLOR W/ ARCHITECT

EXT. WALL FINISH - TYP.

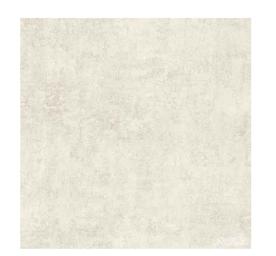



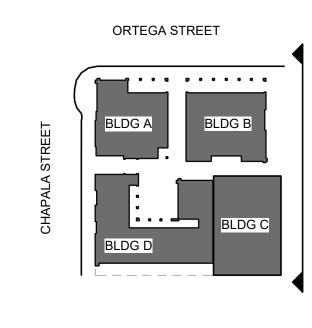


EXTERIOR FLOORING - TYP.



49 - 12"x12" PORCELAIN TERRA COTTA TILE

BUILDING C FINISHES

DOOR / WINDOW COLOR

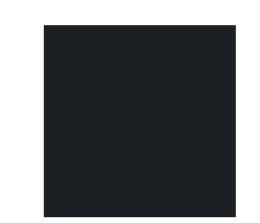

7.3 - ANDERSON DOORS AND WINDOWS, 'MIDNIGHT BLACK' MATTE

WOOD STAIN COLOR



ARCHITECTURAL TRADITIONS WIRE BRUSHED CEDAR STAIN 'V6:82459

TILE



33.4 - TALAVERA TILE, ASSORTED,

4.25"X4.25" PER ARCHITECT - VERIFY

EXT. LIGHT FIXTURES




16-E - WALL SCONCE, HANDLEMAN STUDIOS - 'BOZEMAN' SMALL, BLACK

EXT. CURTAINS



22.9 - SUNBRELLA 'BEAUFORT SAGEBRUSH'

AWNINGS

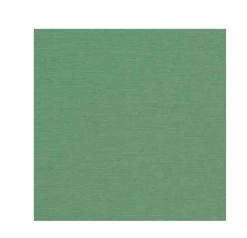

31.1 - SUNBRELLA 'BASIL'

BUILDING B FINISHES

DOOR / WINDOW COLOR



7.1 - ANDERSON DOORS AND WINDOWS, 'SAGE'

TILE @ ARCADE



33.1, TILE A: TALAVERA 'ATESSA' 4.25"X4.25"

EXT. LIGHT FIXTURES



16G - HANDLEMAN STUDIOS -'BACARA'

EXT. PENDENT LIGHTS




53 - POINTED STAR LIGHT





CERAMIC PLANTERS

35.1 - GLADDING McBEAN SERIES 156 PLANTER, COLOR: HARVEST - CONFIRM

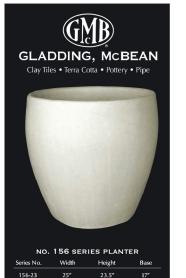







ORTEGA STREET

EXTERIOR FLOORING -TYP.

49 - 12"x12" PORCELAIN TERRA COTTA TILE

EXT. CURTAINS

22.9 - SUNBRELLA 'BEAUFORT SAGEBRUSH'

AWNINGS


31.1 - SUNBRELLA 'BASIL'

ROOF TILE - TYP.



1 - REDLANDS CLAY - CONFIRM COLOR W/ ARCHITECT

EXT. WALL FINISH - TYP.

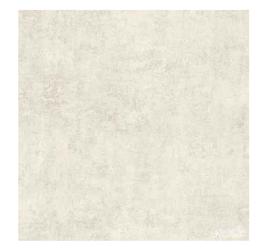

6 - 7/8" EXT. PLASTER



BUILDING D FINISHES

DOOR / WINDOW COLOR



ANDERSON DOORS AND WINDOWS, 'SAGE'

AWNINGS



SUNBRELLA 'FERN'

EXT. LIGHT FIXTURES



16A - HANDLEMAN STUDIOS -'ANACAPA - MEDIUM'

EXTERIOR STONE




54 - SANDSTONE VENEER TO MATCH RE-CLAIMED SITE STONE



BUILDING C FINISHES

DOOR / WINDOW COLOR

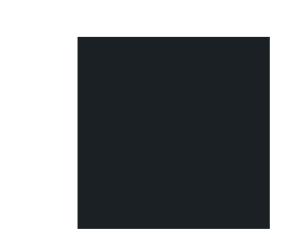

7.3 - ANDERSON DOORS AND WINDOWS, 'MIDNIGHT BLACK' MATTE





WOOD STAIN COLOR

ARCHITECTURAL TRADITIONS WIRE BRUSHED CEDAR STAIN 'V6:82459



TILE

33.4 - TALAVERA TILE, ASSORTED, 4.25"X4.25" PER ARCHITECT - VERIFY

EXT. LIGHT FIXTURES





16-E - WALL SCONCE, HANDLEMAN STUDIOS - 'BOZEMAN' SMALL, BLACK



PROPOSED VIEW FROM S.W.@ CHAPALA ST.

MAX. ALLOWABLE HEIGHT 48'-0" (PROPOSED 47'-9")

BUILDING A SECTION SCALE 1/4"=1'-0"


 PL


NOT FOR

BUILDING A SECTION

SHEET NO.

MAX. ALLOWABLE HEIGHT 48'-0" (PROPOSED 47'-9")

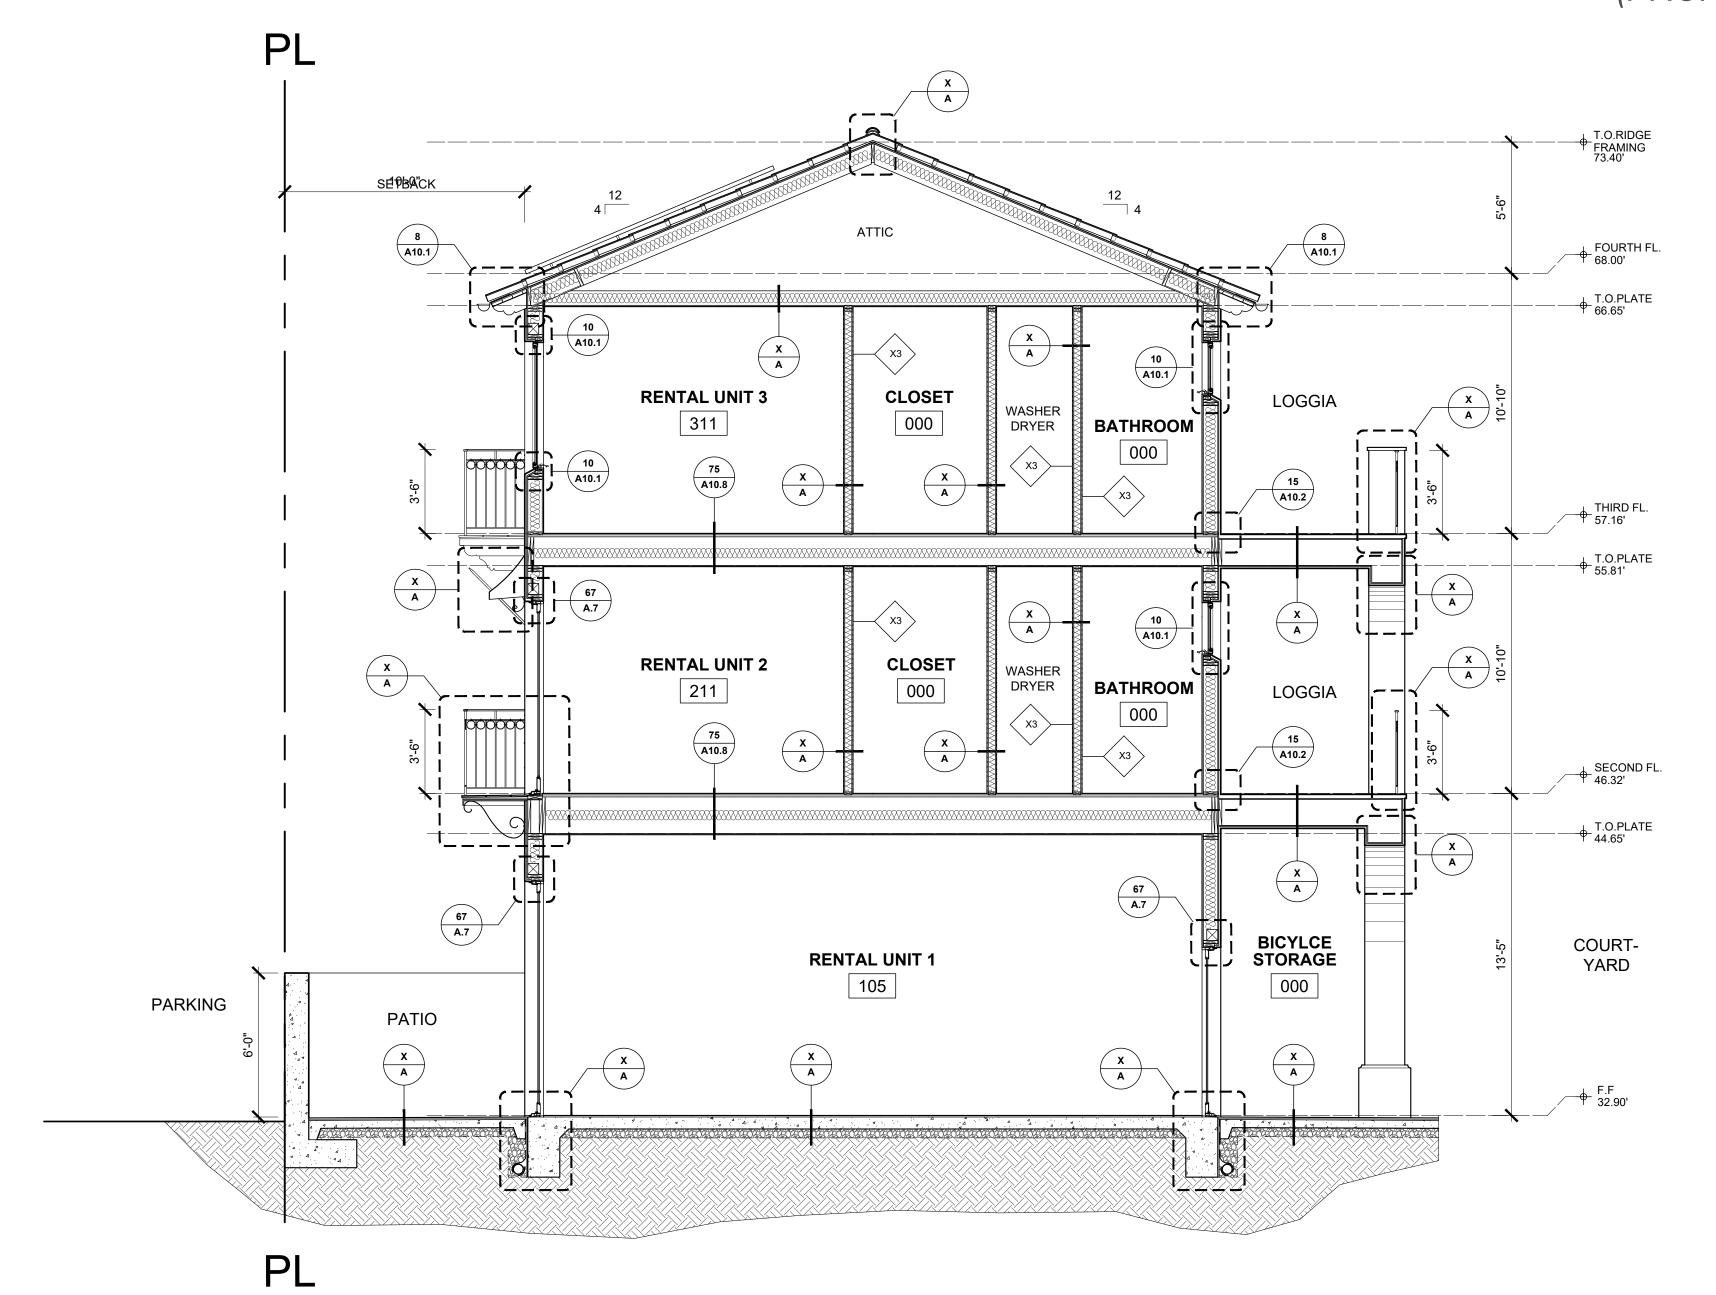

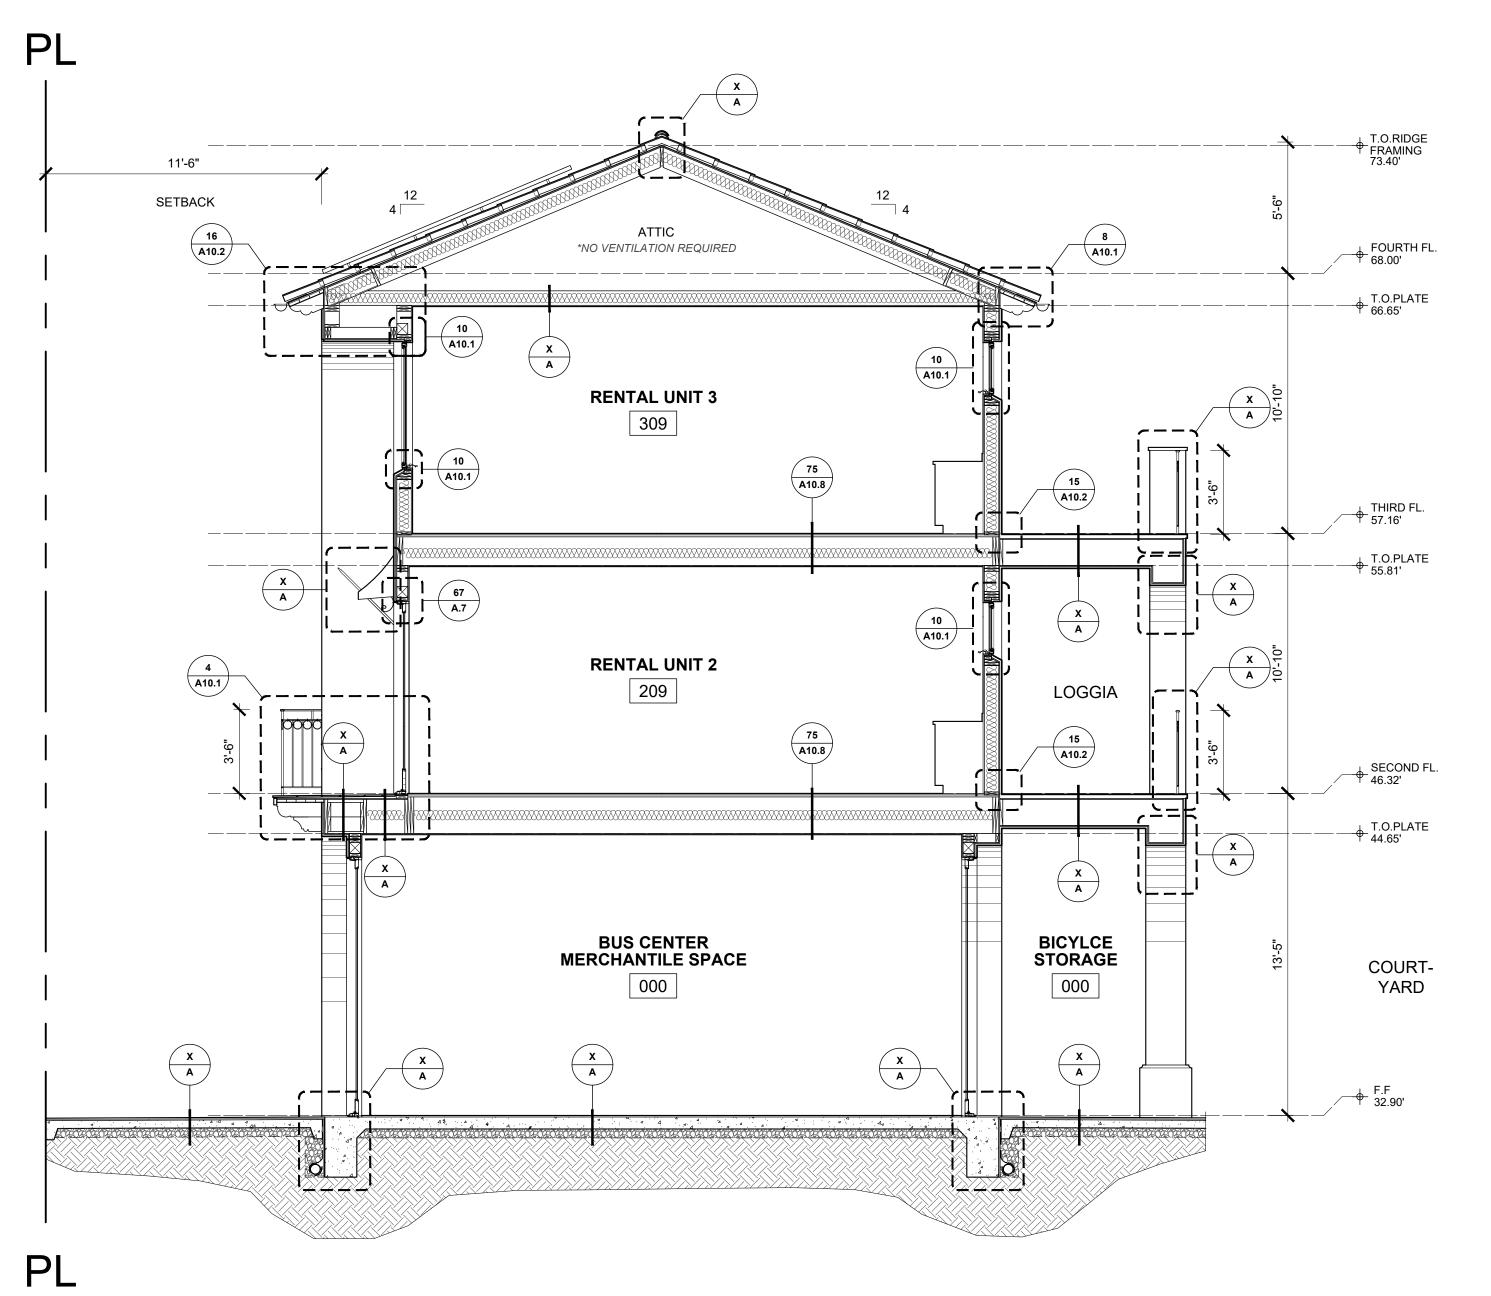

BUILDING D SECTIONS

1/4" = 1'-0"

RENTAL UNIT 2

APARTMENT

101

10 A10.1

BUILDING B SECTION
SCALE 1/4"=1'-0"

CITY R.O.W

SETBACK SIDEWALK

LOGGIA

SECOND FL. 46.32'


ORTEGA

STREET

SHEET NO.

1/4" = 1'-0" TALLON

BUILDING B SECTION

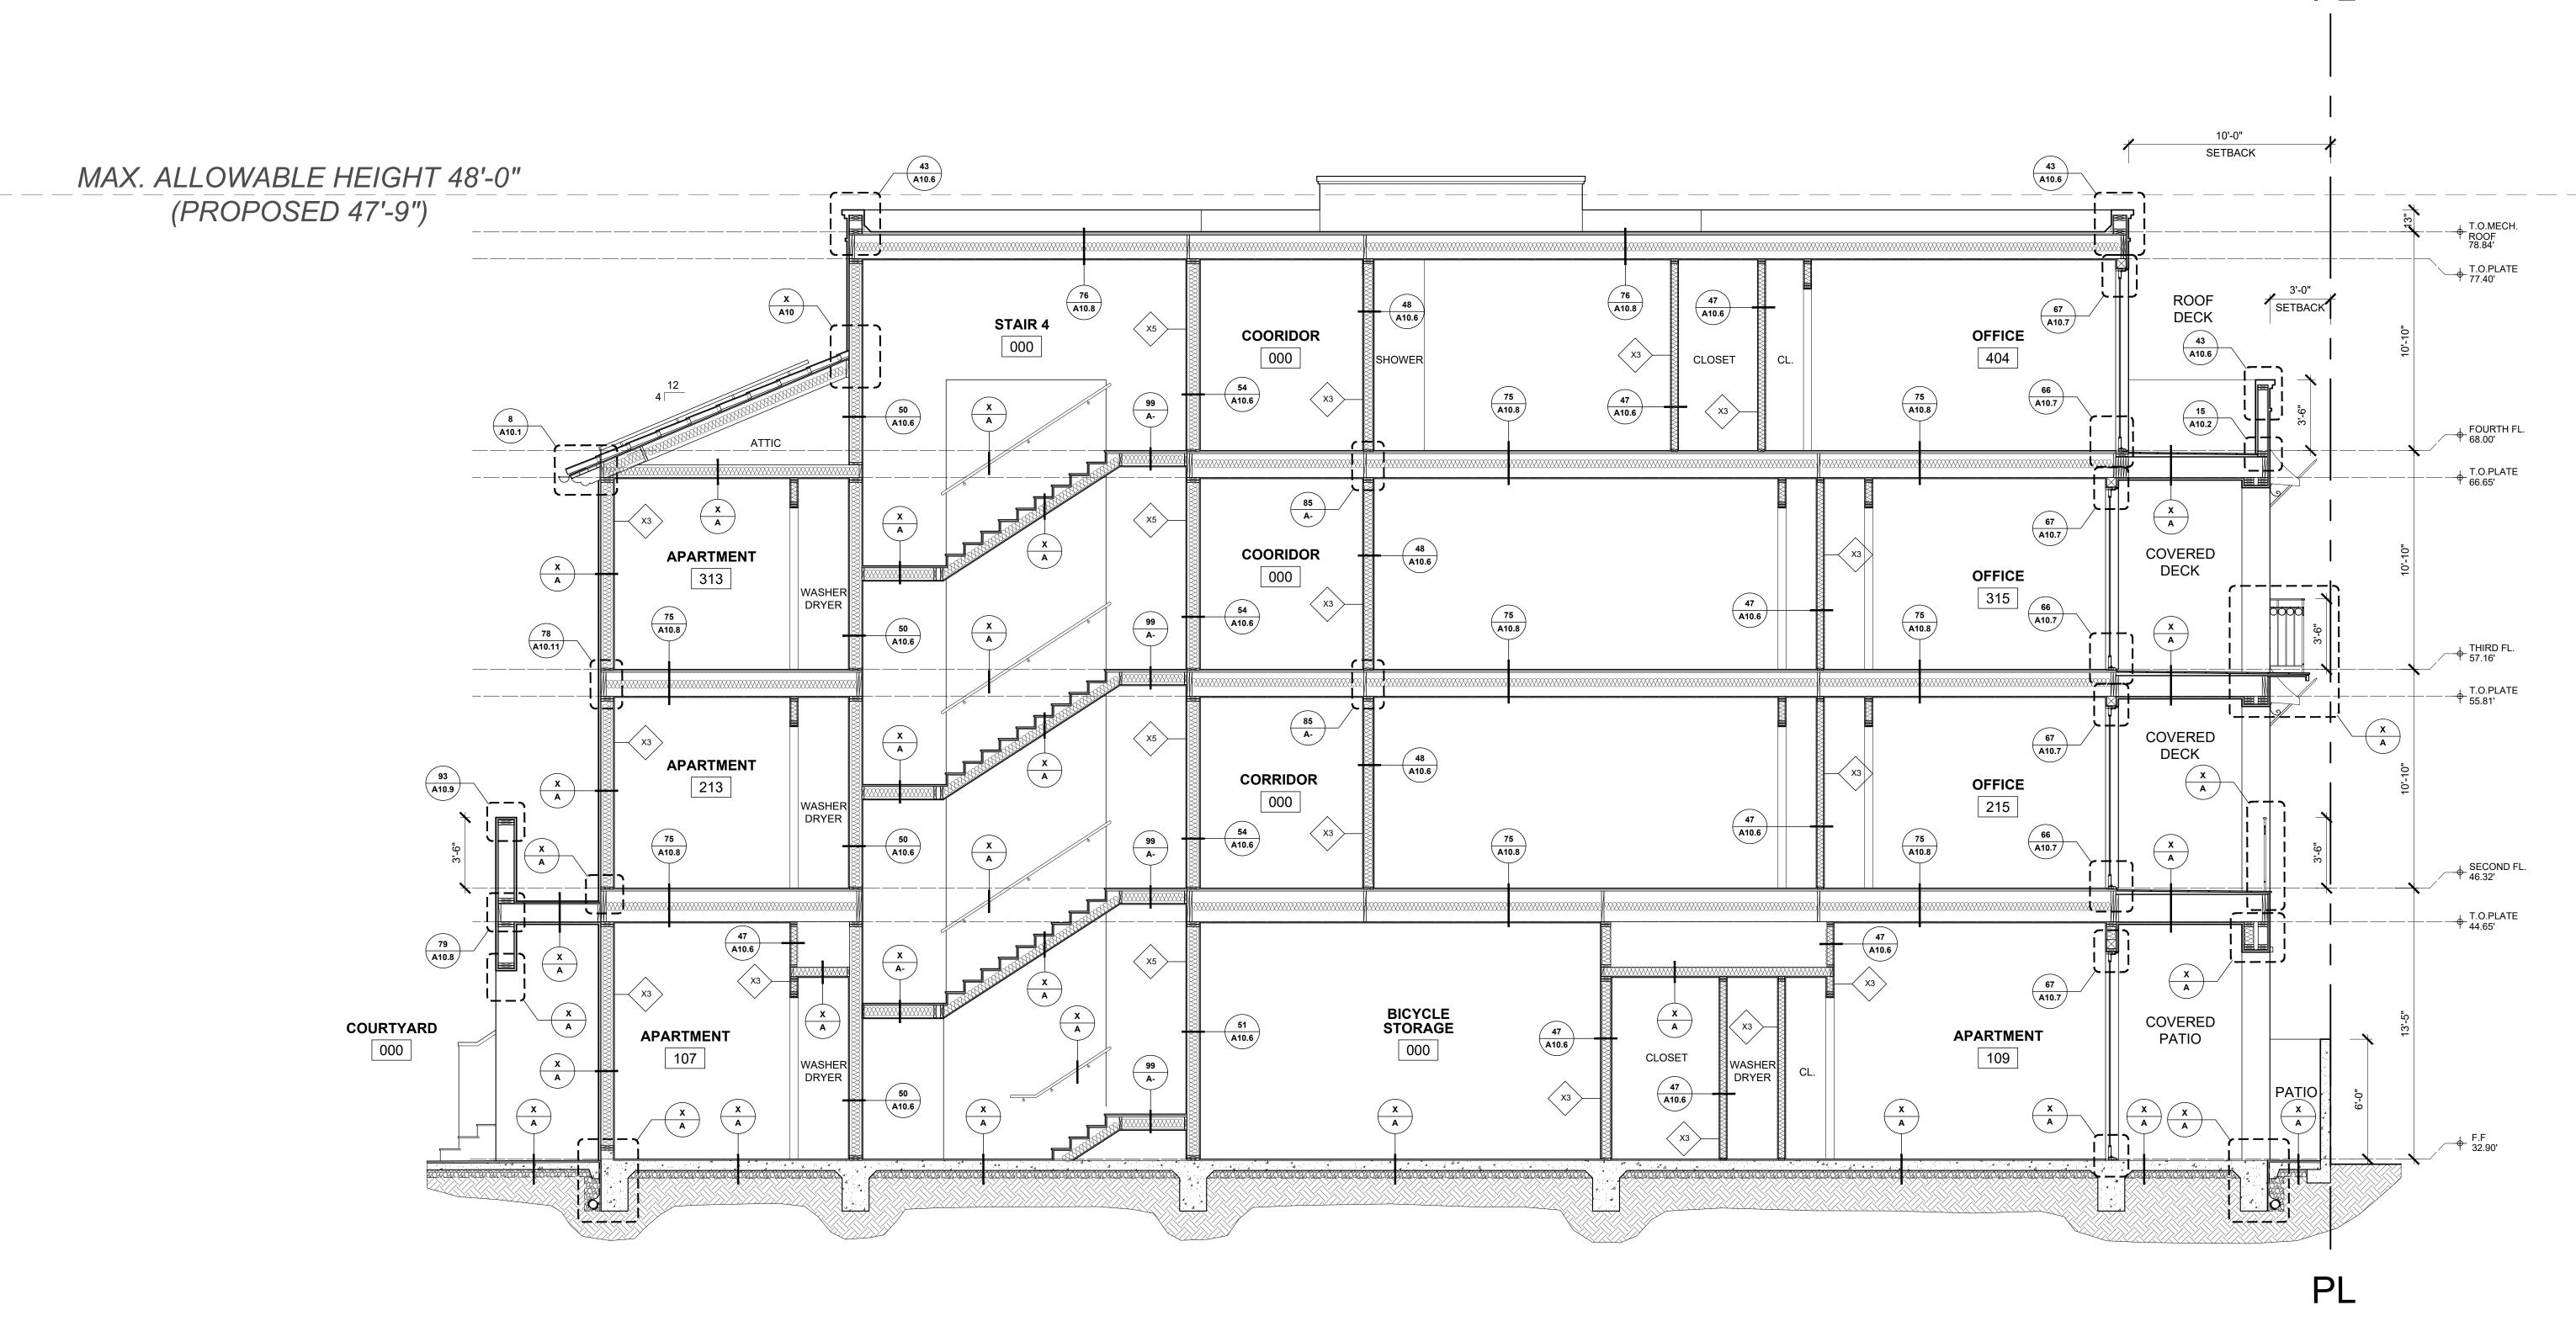

BUILDING C SECTION
SCALE 1/4"=1'-0"

Date Scal

A6.2

BUILDING C SECTION

GLAZING SUBJECT TO HUMAN IMPACT SHALL CONFORM TO CODE AND WITH U.S. CONSUMER PRODUCT SAFETY COMMISSION REQUIREMENTS. GLAZED OPENINGS IN DOORS, FIXED OR OPERABLE PANELS ADJACENT TO A DOOR WHERE THE NEAREST EXPOSED EDGE OF THE GLAZING IS WITHIN A 24" ARC OF EITHER VERTICAL EDGE OF THE DOOR IN A CLOSED POSITION AND WHERE THE BOTTOM EXPOSED EDGE OF THE GLAZING IS LESS THAN 60 INCHES ABOVE THE WALKING SURFACE AND WITHIN 5 FT. OF THE TOP OR BOTTOM OF STAIRS OR LANDINGS SHALL BE TEMPERED GLASS APPROVED FOR IMPACT HAZARD. FIXED PANELS [> 9 SQ FT] WITHIN 18" OF THE ADJACENT FLOOR SHALL BE TEMPERED GLASS APPROVED FOR IMPACT HAZARD.

UNLESS PROTECTED BY A HORIZONTAL PROTECTIVE RAILING AT 34 INCHES TO 38 INCHES ABOVE FINISH FLOOR CAPABLE OF WITHSTANDING A HORIZONTAL LOAD OF 50 POUNDS PER LINEAR FOOT, PROVIDE SAFETY GLAZING AT FIXED OR OPERABLE PANELS EXCEEDING 9 SQUARE FEET WHERE THE LOWER EDGE OF THE GLAZING IS LESS THAN 18 INCHES ABOVE FINISH FLOOR, THE TOP EDGE IS MORE THAN 36 INCHES ABOVE THE FLOOR AND THERE ARE ONE OR MORE WALKING SURFACES WITHIN 36 INCHES OF THE GLAZING. [CRC R308.4],. WHERE THE OPENING OF AN OPERABLE WINDOW IS LOCATED MORE THAN 72 INCHES ABOVE THE FINISHED GRADE OR SURFACE BELOW, THE LOWEST PART OF THE CLEAR OPENING OF THE WINDOW SHALL BE A MINIMUM OF 24 INCHES ABOVE THE FINISHED FLOOR OF THE ROOM IN WHICH THE WINDOW IS LOCATED. OPERABLE SECTIONS OF WINDOWS WITH OPENINGS THAT ARE WITHIN 24" OF THE FINISHED FLOOR SHALL NOT ALLOW PASSAGE OF A 4 INCH DIAMETER SPHERE THROUGH SUCH OPENINGS, SHALL BE PROVIDED WITH APPROVED FALL PREVENTION DEVICES OR SHALL BE PROVIDED WITH A WINDOW OPENING CONTROL DEVICE THAT COMPLIES WITH CRC R312.2.2 OR WINDOW FALL PREVENTION DEVICES THAT COMPLY WITH ASTM F2090. [CRC R312]

- GLAZING IN SHOWER AND TUBS ENCLOSURES SHALL BE TEMPERED, LAMINATED OR APPROVED PLASTIC.
- EGRESS WINDOWS IN SLEEPING ROOMS SHALL CONFORM TO UBC REQUIREMENTS:: MIN 20" WIDE BY 24" HT CLEAR WHEN IN THE OPEN POSITION. MAX HT AT BOTTOM OF OPENING TO BE 44".
- GLAZING IN EXTERIOR DOORS AND WINDOWS SHALL CONFORM TO HIGH FIRE REQUIREMENTS WITH AT LEAST ONE TEMPERED PANE MEETING REQUIREMENTS OF CBC 2406.
- ALL GLAZING TO MEET MIN. REQUIREMENTS*: ALL DOORS AND WINDOWS EXCEPT NOTED ELSEWHERE: .23 SHGC, .30 U-FACTOR STOREFRONT WINDOWS: .30 SHGC, .65 U-FACTOR
- REFER TO TITLE 24 REPORT FOR ADDITIONAL INFORMATION 7. THE NFCR THERMAL PERFORMANCE LABELS SHALL REMAIN ON THE WINDOWS AND DOORS UNTIL FINAL INSPECTION
- GLAZING SHALL BE NFRC RATED
- ALL GLAZING IS DOUBLE PANE UNLESS OTHERWISE NOTED
- 10. SEE FLOOR PLANS AND ELEVATIONS FOR ADDITIONAL ASSEMBLY DETAILS

STOREFRONT NOTES

- ALL ALUMINUM STOREFRONT SECTIONS ARE 2" x 4 1/2" CENTER GLAZED. U.N.O
- SEE ELEVATION COLOR NOTES ON ELEVATION SHEETS FOR STOREFRONT COLOR. REFER TO WINDOW AND DOOR SCHEDULES FOR GLASS TYPES AND HEAD HEIGHTS.
- REFER TO DOOR SCHEDULE FOR ALUMINUM STOREFRONT DOORS
- ALL ALUMINUM SECTIONS SHALL BE ISOLATED ROM STEEL STUDS, FLASHING, ETC TO PREVENT GALVANIC CORROSION

11. GLAZED OPENINGS AT RATED CORRIDORS SHALL BE FIXED GLAZING / METAL FRAME LISTED AND LABELED FOR A FIRE PROTECTION RATING OF AT LEAST 45 MINUTES IN ACCORDANCE WITH UBC SECTION 703.5, THE TOTAL AREA OF ALL GLAZED OPENINGS IN ANY PORTION OF AN EXIT CORRIDOR SHALL NOT EXCEED 25 PERCENT OF THE AREA OF THE CORRIDOR WALL OF THE ROOM WHICH IT IS SEPARATING FROM THE CORRIDOR. INTERIOR FRAMES SCHEDULED AS FIRE RATED SHALL BE HOLLOW METAL

GLAZING TYPES

- G1 1" INSULATED LOW E DUAL GLAZED CLEAR GLASS
- G2 1" INSULATED LOW E DUAL GLAZED CLEAR GLASS, TEMPERED G3 1" INSULATED LOW E DUAL GLAZED OPAQUE GLASS BLACK BACKING

GENERAL DOOR NOTES

- VERIFY ROUGH OPENING SIZE WITH DOOR MANUFACTURER SPECIFICATIONS PRIOR TO CONSTRUCTION
- CONTRACTOR TO VERIFY ACTUAL DOOR SIZE TO FINISH OPENING PRIOR TO FABRICATION OF DOOR AND FINISH OPENING. ALL DOOR HARDWARE TO HAVE LEVER HANDLES AND COMPLY WITH DETAIL
- SEE SPECIFICATIONS FOR SIGN SCHEDULE. REFER TO DETAILS FOR ROOM IDENTIFICATION SYMBOL LOCATIONS ALL THRESHOLDS SHALL COMPLY WITH DETAIL
- EGRESS DOORS SHALL BE READILY OPENABLE FROM THE EGRESS SIDE WITHOUT THE USE OF A KEY OR SPECIAL KNOWLEDGE OR
- DOOR DIMENSIONS ARE SHOWN 'WIDTH X HEIGHT' OF DOOR PANELS OR PAIR OF DOORS FOR DOOR OPERATION AND HAND, REFER TO FLOOR PLANSDOOR NUMBER AND TYPE ARE INDICATED ON FLOOR PLANS AND
- DOOR HARDWARE GROUPS TO BE DEVELOPED BY ARCHITECT OF RECORD
- REFER TO FIRE RATINGS WHERE REQUIRED
- PROVIDE TEMPERED SAFETY GLAZING AT GLAZED DOORS AND THEIR SIDELITES DOOR THRESHOLDS SHALL NOT EXCEED 1/2 INCH IN HEIGHT
- 13. CLOSER OPENING FORCE SHALL NOT EXCEED 5 LBS. AT EXTERIOR DOORS AND 5 LBS. AT INTERIOR DOORS WITHOUT SPECIAL KNOWLEDGE OR EFFORT
- 14. ALL EXIT DOOR HARDWARE SHALL ALLOW DOOR TO BE OPENED FROM INSIDE WITHOUT A KEY OR SPECIAL KNOWLEDGE OR EFFORT MANUALLY OPERATED EDGE OR SURFACE MOUNTED FLUSH BOLTS ARE NOT PERMITTED AT EXIT DOORS
- ALL PASSAGE DOORS WITH LATCHES OR LOCKING MECHANISMS SHALL BE EQUIPPED WITH EQUIPPED WITH SINGLE EFFORT LEVER TYPE HARDWARE, PANIC BARS. OR OTHER HARDWARE TO PROVIDE PASSAGE WITHOUT REQUIRING THE ABILITY TO GRASP
- THE HARDWARE. DOOR HARDWARE TO BE CENTERED BETWEEN 34 AND 44 INCHES ABOVE FINISH FLOOR WHERE DOOR MATERIAL IS NOTED AS WOOD, PROVIDE SOLID CORE DOORS AT UNIT ENTRIES BEDROOMS BATHROOMS,
- RESIDENTIAL LOBBY AND COMMUNITY ROOMS. PROVIDE HOLLOW CORE DOORS AT UNIT CLOSETS 19. PROVIDE EXTERIOR GLAZING MEETING MIN, REQUIREMENTS OF TITLE 24

EGRESS WIDTH NOTES

REFER TO DOOR SCHEDULE FOR DOOR FIRE RATINGS

CBC 1005.3.2 EXCEPTION: 1 EGRESS COMPONENT WIDTH CALCULATE BY MULTIPLYING THE OCCUPANT LOAD BY A MEANS OF EGRESS FACTOR OF 0.15 INCHES PER OCCUPANT (1010.1.1) WITH A MINIMUM CLEAR WIDTH OF 32". DOOR SHALLS SATISFY THE REQUIRED WIDTH, REQUIRED WIDTH DISTRIBUTION OF MINIMUM CLEAR WIDTH, WHICHEVER IS LARGER.

DOOR NO.	NUMBER OF OCCUPANTS	REQUIRED WIDTH (INCHES)	DOOR LOSS	OC. DISTRIBUTION	WIDTH DISTRIBUTION REQ'D (INCHES)	PROVIDED WIDTH (INCHES)

SIGNAGE NOTES

WHERE PERMANENT IDENTIFICATION IS PROVIDED FOR ROOMS AND SPACES RAISED LETTERS SHALL BE PROVIDED AND SHALL BE ACCOMPANIED BY BRAILLE IN CONFORMANCE WITH

SIGNS SHALL BE INSTALLED ON THE WALL ADJACENT TO THE LATCH OUTSIDE THE DOOR WHERE THERE IS NO WALL SPACE ON THE LATCH SIDE. INCLUDING AT DOUBLE LEAF DOORS. SIGNS SHALL BE PLACED ON THE NEAREST ADJACENT WALL PREFERABLY ON THE RIGHT. THE MOUNTING HEIGHT SHALL BE 48 INCHES MINIMUM ABOVE THE FINISH FLOOR MEASURED FROM THE BASELINE OF THE LOWEST BRAILLE ROLL AND 60 INCHES MAXIMUM ABOVE THE FINISH FLOOR MEASURED FROM THE BASELINE OF THE HIGHEST LINE OF RAISED CHARACTERS. MOUNTING LOCATION SHALL BE DETERMINED SO THAT A PERSON MAY APPROACH WITH WITHIN 3 INCHES OF SIGNAGE WITHOUT ENCOUNTERING PROTRUDING OBJECTS OR STANDING WITHIN THE SWING OF A DOOR. NOTE: REFER TO ACCESSIBILITY DETAIL SHEETS FOR ADDITIONAL SIGNAGE REQUIREMENTS APPLICABLE TO SANITARY

BRAILLE SYMBOLS: CONTRACTED GRADE IF BRAILLE. DOTS SHALL BE 1/10 INCH ON CENTER IS IN EACH CELL WITH 2/10-INCH SPACE BETWEEN CELLS. DOTS SHALL BE RAISED A MINIMUM OF 1/40 INCH ABOVE THE BACKGROUND. PROPORTIONS: LETTERS AND NUMBERS ON SIGNS SHALL HAVE A WIDTH TO HEIGHT RATIO OF BETWEEN 3.5 AND 1.1 AND A STROKE WIDTH TO HEIGHT RATIO BETWEEN ONE 1.3 AND CHARACTER HEIGHT: CHARACTERS AND NUMBERS ON SIGNS SHALL BE SIZED ACCORDING TO THE VIEWING DISTANCE FROM WHICH THEY ARE TO BE READ. THE MINIMUM HEIGHT IS

CONTRAST OF SYMBOL: CHARACTERS AND SYMBOLS SHALL CONTRAST WITH THEIR CHARACTERS ON A LIGHT BACKGROUND. RAISED CHARACTERS AND PICTORIAL SYMBOL SIGNS: SYMBOLS ARE USED THEY ARE THEY SHALL CONFORM TO THE FOLLOWING REQUIREMENTS.

MEASURED USING AN X. LOWERCASE CHARACTERS ARE PERMITTED FOR SIGNS SUSPENDED OR PROJECTED ABOVE THE FINISH FLOOR GREATER THAN 80 INCHES. THE MINIMUM

LETTER TYPE: LETTERS AND NUMBERS ON SIGNS SHALL BE RAISED 1/32 INCH MINIMUM AND SHALL BE SANS SERIF UPPERCASE CHARACTERS ACCOMPANIED BY GRADE IF BRAILLE.SYMBOL SIZE: RAISED CHARACTERS OR SYMBOL SHALL BE A MINIMUM OF 5/8 INCH HIGH.

PICTORIAL SYMBOL SIGNS: PICTORIAL SYMBOLS SIGNS SHALL BE ACCOMPANIED BY THE EQUIVALENT VERBAL DESCRIPTION PLACED DIRECTLY BELOW THE PICTOGRAM. THE BORDER DIMENSION OF THE PICTOGRAM SHALL BE MINIMUM OF 4 INCHES.


DOOR/WINDOW GLAZING NOTES

1. ALL GLAZING TO BE DUAL LOW E. 2. ALL GLAZING REQUIRED TO BE INSULATING GLASS UNITS WITH A MINIMUM OF ONE TEMPERED PANE PER WINDOW. REQUIRED TO BE 3/16" TEMPERED GLASS, DUAL OR MULTILAYERED GLAZED PANELS, 1/4" LAMINATED GLASS, GLASS BLOCK, OR HAVE A FIRE PROTECTION RATING OF NOT LESS THAN 20 MINUTES PER 2007 CBC CHAPTER 7A & SBCO HIGH FIRE HAZARD AREA STANDARDS.

3. ALL OPERABLE WINDOWS TO BE SCREENED. 4. ALL CASEMENT WINDOWS, U.N.O. PER WINDOW SCHEDULE 5. ALL WINDOWS TO BE INTERIOR PAINTED, U.N.O. PER PLAN.

AT FRAME.

CHARACTER HEIGHT SHALL BE 3 INCHES.

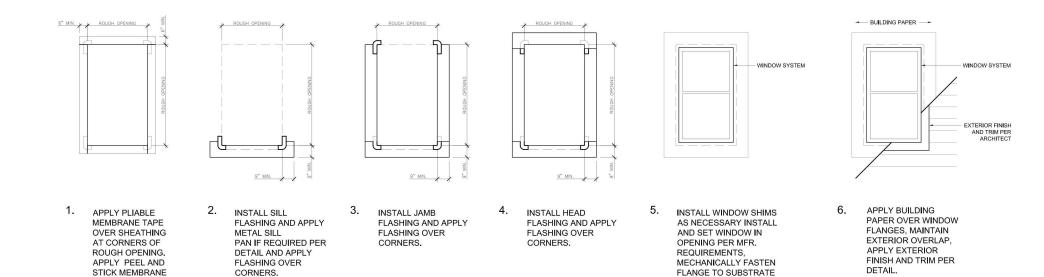

REMAINING SIDES OF

NOTES 1. SURFACES SHALL BE CLEAN AND DRY AND PRIMED WITH CONTACT ADHESIVE. FLASHING SHALL BE A MINIMUM OF 9" WIDE, FLASHING SHALL WRAP INTO WINDOW OPENING GREATER

THAN THE DEPTH OF THE WINDOW AND OUT ONTO THE WALL 3" MIN. SILL PAN TO BE COPPER U.N.O., CONTRACTOR TO SUBMIT SAMPLE FOR REVIEW BY ARCHITECT PRIOR TO

REVISION SCHEDULE

O. DESCRIPTION DATE

2024-03-21

OLIVE

SILL EXTENSION

SLIDER

SINGLE POCKET

DOUBLE SLIDER

SILL EXTENSION

SILL EXTENSION

SINGLE POCKET

SLIDER

ANDERSON WINDOWS AND DOORS, SERIES E, DUAL CLAD, U.N.O.

SEE ADDITIONAL DOOR AND WINDOW REQUIREMENTS, A8.1

SLIDER

SLIDER

SLIDER

ANDERSON

ROGUE VALLEY OLIVE

ROGUE VALLEY PT 1

ROGUE VALLEY OLIVE

ROGUE VALLEY PT 1

ROGUE VALLEY PT 1

ROGUE VALLEY OLIVE

ROGUE VALLEY PT 1

COLOR: 'OLIVE'

OLIVE

OLIVE

OLIVE

OLIVE

OLIVE

ANDERSON

ANDERSON

ANDERSON

ANDERSON

ANDERSON

ROGUE VALLEY OLIVE

SITE AND SPECIALTY DOORS **ENTRY AND EXIT DOORS** 1/4" = 1'-0" 1/4" = 1'-0"

APT ENTRY

UNIT ENTRY U.N.O.

DUAL CLAD OLIVE

D3

UNIT EXT. BALCONY

1 HR.

ANDERSON

ANDERSON

ANDERSON

ANDERSON

ANDERSON

ANDERSON

ELEVATORS

2 HR.

COMMON INT. DOORS 1/4" = 1'-0"

LOUVERED W/ SCREEN

UNIT EXT. BALCONY

1 HR.

SINGLE CASEMENT 1

SINGLE CASEMENT 2

W2

SINGLE CASEMENT 2 1' - 9" 2' - 3" 8' - 0"

APT. 402

BUILDING A LEVEL 4 APT. 401

BUILDING A LEVEL 4 APT. 401

STOREFRONT DOORS 1/4" = 1'-0"

LOBBY ENTRY


1 HR.

STAIRS, EXITS

1-1/2 HR. U.N.O.

NOTES

DI3 DI2 **UNIT PANEL** INT JANITOR, MECH ROOM ENTRY UNIT SINGLE POCKET UNIT DOUBLE SLIDER UNIT DOUBLE PANEL

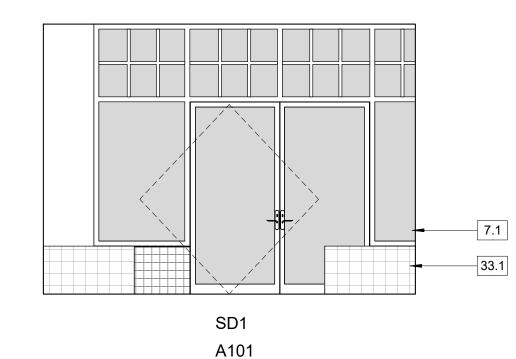

RETAIL ENTRY

1 HR.

WINDOW TYPES

1/4" = 1'-0"

STOREFRONT WINDOWS

1/4" = 1'-0"

SF2

68/A10.7 67/A10.7 1 HR

66/A10.7 68/A10.7 67/A10.7

66/A10.7 | 68/A10.7 | 67/A10.7 | 1

66/A10.7 | 68/A10.7 | 67/A10.7 | 1

66/A10.7 68/A10.7 67/A10.7 1 HR

66/A10.7 68/A10.7 67/A10.7 1 HR

66/A10.7 68/A10.7 67/A10.7 1 HR

66/A10.7 68/A10.7 67/A10.7 1

66/A10.7 | 68/A10.7 | 67/A10.7 | 1

66/A10.7 68/A10.7 67/A10.7 1

68/A10.7 67/A10.7 1 HR

1 HR

1 HR

66/A10.7 68/A10.7 67/A10.7

6' - 0" 8' - 0" 1 3/4"

3' - 0" 7' - 0" 1 3/4"

3' - 0" 8' - 0" 1 3/4"

3' - 0" 7' - 0" 1 3/4"

3' - 0" 8' - 0" 1 3/4"

3' - 0" | 8' - 0" | 1 3/4"

3' - 0" 7' - 0" 1 3/4"

3' - 0" 8' - 0" 1 3/4"

5' - 0" 7' - 0" 1 3/8"

2' - 6" 7' - 0" 1 3/8"

3' - 0" 7' - 0" 1 3/4"

2' - 0" 7' - 0" 1 3/8"

2' - 0" 7' - 0" 1 3/8"

2' - 8" 7' - 0" 1 3/8"

2' - 0" 7' - 0" 1 3/8"

3' - 0" 7' - 0" 1 3/4"

5' - 0" 7' - 0" 1 3/8"

5' - 0" 7' - 0" 1 3/8"

2' - 8" | 7' - 0" | 1 3/8"

5' - 0" 7' - 0" 1 3/8"

5' - 0" 7' - 0" 1 3/8"

5' - 0" 7' - 0" 1 3/8"

2' - 8" 7' - 0" 1 3/8"

3' - 0" 7' - 0" 1 3/8"

2' - 8" 7' - 0" 1 3/8"

4' - 6" 7' - 0" 1 3/8"

4' - 6" 7' - 0" 1 3/8"

2' - 4" 7' - 0" 1 3/8"

6' - 0" | 8' - 0" | 1 3/4"

2' - 6" | 8' - 0" | 1 3/4"

2' - 6" | 8' - 0" | 1 3/4"

6' - 0" 8' - 0" 1 3/4"

6' - 0" 8' - 0" 1 3/4"

6' - 0" | 8' - 0" | 1 3/4"

3' - 0" 7' - 0" 1 3/4"

3' - 0" 8' - 0" 1 3/4"

3' - 0" 7' - 0" 1 3/4"

3' - 0" 8' - 0" 1 3/4"

3' - 0" 7' - 0" 1 3/4"

3' - 0" 8' - 0" 1 3/4"

4' - 0" 7' - 0" 1 3/8"

3' - 0" 7' - 0" 1 3/4"

2' - 6" 7' - 0" 1 3/8"

5' - 0" 7' - 0" 1 3/8"

2' - 6" 7' - 0" 1 3/8"

3' - 0" 7' - 0" 1 3/4"

2' - 0" 7' - 0" 1 1/2"

3' - 0" 7' - 0" 1 3/4"

5' - 0" 7' - 0" 1 3/8"

2' - 8" 7' - 0" 1 3/8"

5' - 0" | 7' - 0" | 1 3/8"

2' - 4" 7' - 0" 1 3/8"

3' - 0" 7' - 0" 1 3/8"

2' - 8" | 7' - 0" | 1 3/8"

4' - 6" 7' - 0" 1 3/8"

4' - 6" 7' - 0" 1 3/8"

TEMPERED

TEMPERED TEMPERED

TEMPERED

TEMPERED

TEMPERED

TEMPERED

LEVEL 3

LEVEL 4

A308 LEVEL 3

A310 LEVEL 3

A313 LEVEL 3

A314 LEVEL 3

A315 LEVEL 3

A316 LEVEL 3

A318 LEVEL 3

A319 LEVEL 3

A320 LEVEL 3

A320 LEVEL 3

A321 LEVEL 3

A322 LEVEL 3

A323 LEVEL 3

A324 LEVEL 3

A325 LEVEL 3

A326 LEVEL 3

A329 LEVEL 3

A330 LEVEL 3

A331 LEVEL 3

A333 LEVEL 3

A406 LEVEL 4

A410 LEVEL 4

A412 LEVEL 4

A414 LEVEL 4

A418 LEVEL 4

A419 LEVEL 4

A420 LEVEL 4

A422 LEVEL 4

A426 LEVEL 4

A428 LEVEL 4

A424

APT. 307

STAIR 2

ELEV. 1

APT. 306

STAIR 1

APT. 308

APT. 306

APT. 305

APT. 305

APT. 305

APT. 308

APT. 307

APT. 307

APT. 307

APT. 307

APT. 307

APT. 401

APT. 403

APT. 403

APT. 402

APT. 402

STAIR 2

APT. 401

ELEV. 1

STAIR 1

APT. 403

APT. 401

APT. 403

APT. 402

APT. 402

APT. 402

APT. 402

LOUVERED WHERE OCCURS

DOOR WINDOW

SCHEDULE BLDG A

REVISION SCHEDULE

O. DESCRIPTION DATE

S

 \forall

SD1 B101

SFW2

SP3

WINDOW TYPES

1/4" = 1'-0"


SP4

SP2

DOOR WINDOW SCHEDULE BLDG B

REVISION SCHEDULE

O. DESCRIPTION DATE

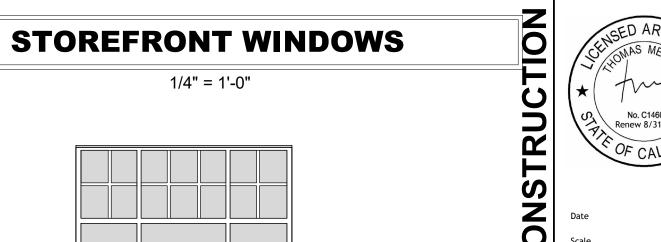

Date 2024-03-21
Scale 1/4" = 1'-0"
Drawn AW

SHEET NO.


ARCADIA


MID. BLACK


ARCADIA STEEL LOOK ALUMINUM WINDOWS AND DOORS, U.N.O. COLOR: 'MIDNIGHT BLACK'

SEE ADDITIONAL DOOR AND WINDOW REQUIREMENTS, A8.1

SITE AND SPECIALTY DOORS

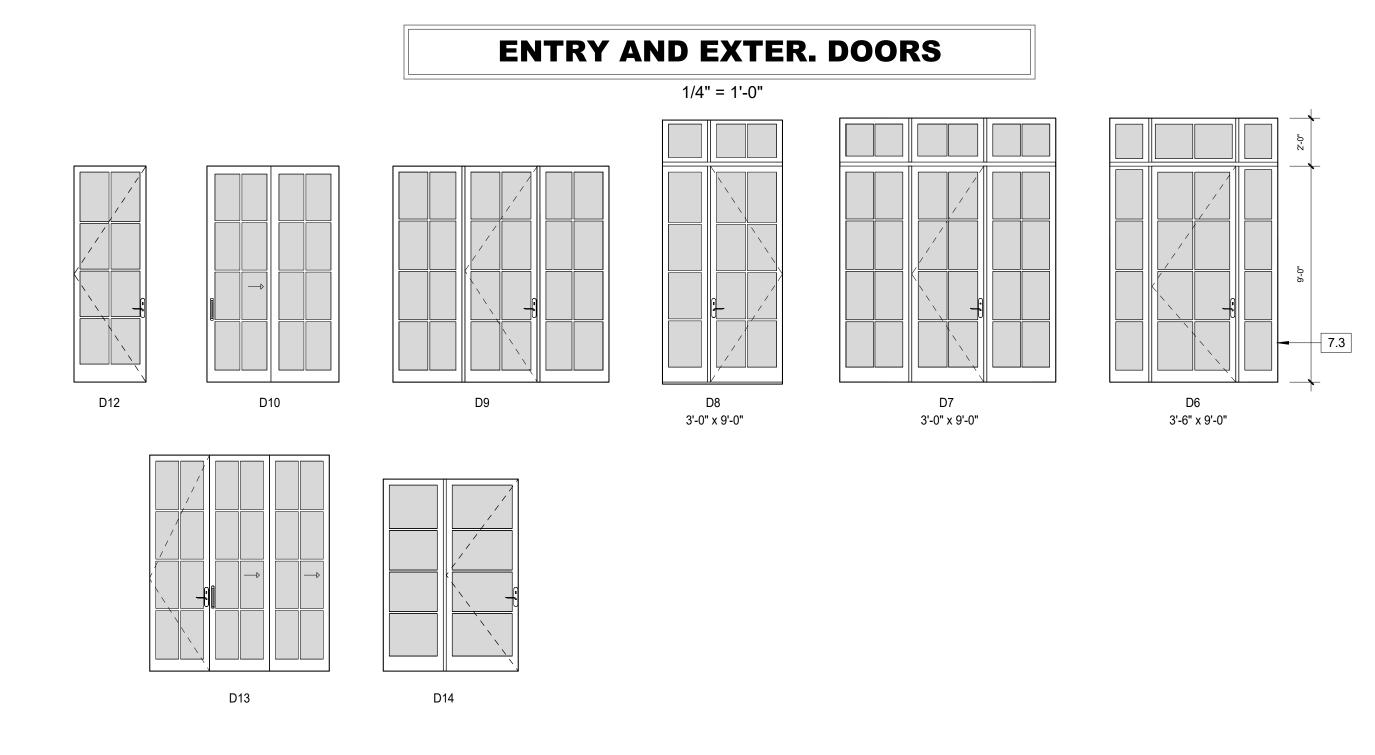

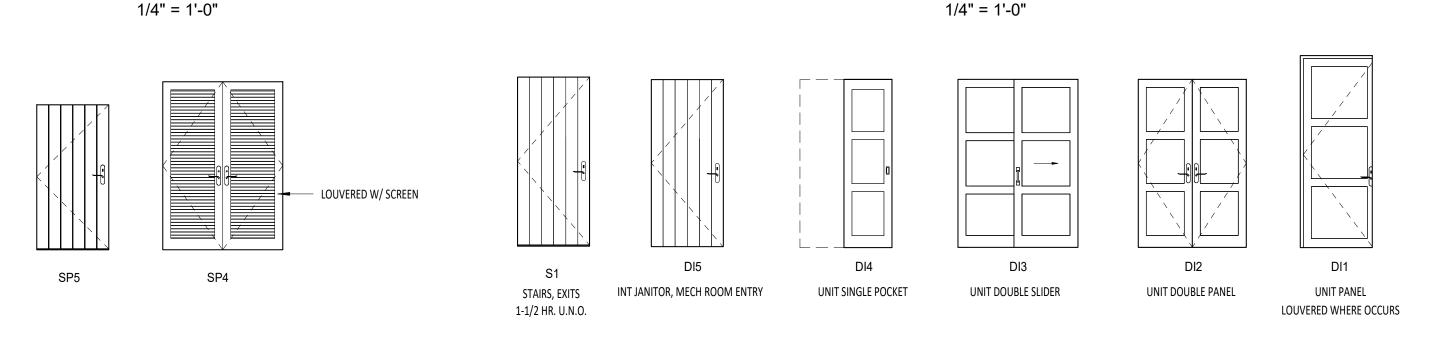

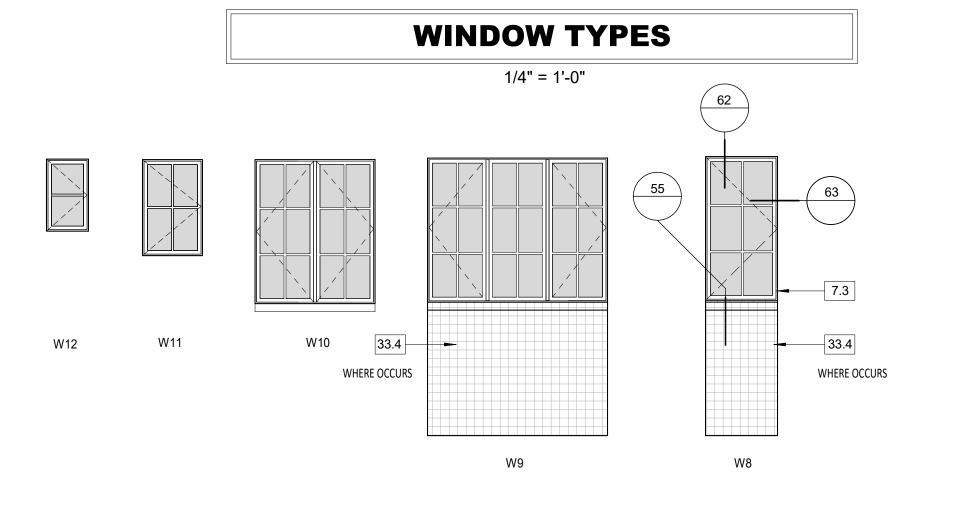

COMMON UNIT DOORS

630 CHAPALA STREET

REVISION SCHEDULE

O. DESCRIPTION DATE

 \circ

 \forall

DOOR WINDOW SCHEDULE BLDG C

No. C14606
Renew 8/31/25

Date 2024-03-21
Scale 1/4" = 1'-0"

SHEET NO.

AR 10

UTILITY ACCESS 3' - 0" 6' - 0" 2"

DECK

DECK

DECK

AR502 ROOF

AR503 ROOF

TOTAL: 454

3' - 0" 7' - 0" 1 3/4"

3' - 0" 7' - 0" 1 3/4"

ROOF DECK

WINDOW SCHEDULE WIDTH | HEIGHT | COLOR DUAL CLAD SAGE BUILDING D LEVEL SINGLE CASEMENT DUAL CLAD SAGE BUILDING D LEVEL 1 BUS. CENTER W1 LEVEL 1 UNISEX BATH 4 W2 SINGLE CASEMENT 2 1' - 9" 3' - 0" 8' - 0" DUAL CLAD SAGE STOREFRONT DUAL CLAD SAGE **BUILDING D** LEVEL 1 BUILDING D LEVEL 1 BUS. CENTER STOREFRONT DUAL CLAD SAGE LEVEL 1 APT. 104 SINGLE CASEMENT 1 DUAL CLAD SAGE RUII DING D APT.105 DUAL CLAD SAGE LEVEL 1 SINGLE CASEMENT 1 1' - 9" 3' - 6" 8' - 0' SINGLE CASEMENT 1 1' - 9" 3' - 6" 8' - 0" BUILDING D LEVEL 1 APT. 106 DUAL CLAD SAGE APT. 107 BUILDING D LEVEL 1 DOUBLE CASEMENT W/ 5' - 0" 5' - 4" 8' - 0" DUAL CLAD SAGE BUILDING D LEVEL 1 | DOUBLE CASEMENT W/ | 5' - 0" | 5' - 4" | 8' - 0' DUAL CLAD SAGE | DOUBLE CASEMENT W/ | 5' - 0" | 5' - 4" | 8' - 0' DUAL CLAD SAGE BUILDING D LEVEL 1 DOUBLE CASEMENT DUAL CLAD SAGE DUAL CLAD SAGE LEVEL 1 DUAL CLAD SAGE TRIPLE CASEMENT 2 DUAL CLAD SAGE LEVEL 1 LEVEL 1 SINGLE CASEMENT 1 DUAL CLAD SAGE BUILDING D DUAL CLAD SAGE DUAL CLAD DUAL CLAD SAGE DUAL CLAD SAGE APT. 209 SINGLE CASEMENT 2 DUAL CLAD SAGE APT. 209 SINGLE CASEMENT 2 DUAL CLAD SAGE DUAL CLAD SAGE APT. 209 SINGLE CASEMENT 2 LEVEL 2 DUAL CLAD APT. 211 LEVEL 2 SINGLE CASEMENT 2 DUAL CLAD SAGE LEVEL 2 APT. 211 DUAL CLAD SAGE DUAL CLAD SAGE LEVEL 2 LEVEL 2 APT. 212 SINGLE CASEMENT 2 DUAL CLAD SAGE DUAL CLAD SAGE APT. 213 DUAL CLAD DOUBLE CASEMENT APT. 213 DUAL CLAD SAGE LEVEL 2 SINGLE CASEMENT 2 APT. 213 DOUBLE CASEMENT DUAL CLAD SAGE DOUBLE CASEMENT DUAL CLAD SAGE APT. 212 DUAL CLAD LEVEL 2 LEVEL 2 APT. 211 SINGLE CASEMENT 1 DUAL CLAD SAGE DUAL CLAD SAGE APT. 211 DOUBLE CASEMENT LEVEL 2 LEVEL 2 DUAL CLAD SAGE DUAL CLAD SAGE LEVEL 2 APT. 210 SINGLE CASEMENT 1 DUAL CLAD SAGE APT. 210 SINGLE CASEMENT 1 LEVEL 2 DUAL CLAD DUAL CLAD SAGE LEVEL 2 APT. 209 DOUBLE CASEMENT DUAL CLAD SAGE LEVEL 3 SINGLE CASEMENT 2 DUAL CLAD SAGE SINGLE CASEMENT 2 LEVEL 3 APT. 309 SINGLE CASEMENT 2 DUAL CLAD SAGE LEVEL 3 LEVEL 3 APT. 309 SINGLE CASEMENT 2 DUAL CLAD SAGE DUAL CLAD APT. 311 DUAL CLAD SAGE LEVEL 3 LEVEL 3 APT. 311 SINGLE CASEMENT 2 DUAL CLAD SAGE APT. 312 DUAL CLAD SAGE LEVEL 3 | SINGLE CASEMENT 2 | 1' - 9" | 2' - 3" | 8' - 0' LEVEL 3 APT. 312 DUAL CLAD SAGE LEVEL 3 APT. 313 SINGLE CASEMENT 1 2' - 0" 4' - 0" 8' - 0' DUAL CLAD SAGE SINGLE CASEMENT 1 2' - 6" 5' - 6" 8' - 0' DUAL CLAD SAGE BUILDING D LEVEL 3 APT. 313 SINGLE CASEMENT 1 | 2' - 6" | 5' - 6" | 8' - 0' BUILDING D LEVEL 3 APT. 313 SINGLE CASEMENT 2 1' - 9" 2' - 8" 8' - 0" W2 DUAL CLAD BUILDING D LEVEL 3 DUAL CLAD SAGE DUAL CLAD SAGE LEVEL 3 APT. 312 DOUBLE CASEMENT APT. 312 DUAL CLAD SAGE DUAL CLAD SAGE DOUBLE CASEMENT LEVEL 3 DUAL CLAD SAGE DUAL CLAD SAGE LEVEL 3 APT. 310 SINGLE CASEMENT 2 APT. 310 SINGLE CASEMENT 2 2' - 8" | 8' - 0' DUAL CLAD SAGE APT. 310 SINGLE CASEMENT 2 1' - 6" 2' - 8" 8' - 0" BUILDING D LEVEL 3 DUAL CLAD SAGE BUILDING D LEVEL 3 APT. 309 QUAD CASEMENT 10' - 0" 5' - 4" 7' - 10" DUAL CLAD SAGE **COMMON INT. DOORS** 1/4" = 1'-0"

WINDOWS: D1Q, D1P

ANDERSON **STOREFRONT DOORS** 1/4" = 1'-0" 44 7.4 7.4 DI3 UNIT PANEL INT JANITOR, MECH ROOM ENTRY UNIT SINGLE POCKET UNIT DOUBLE SLIDER UNIT DOUBLE PANEL LOUVERED WHERE OCCURS **ENTRY AND EXTER. DOORS** 1/4" = 1'-0" 7.4

MFR

ANDERSON

OBSCURE

OBSCURE

OBSCURE

OBSCURE

OBSCURE

OBSCURE

OBSCURE

ANDERSON

TYPE

NOTES

S1 D17 D15 D16 D14 APT ENTRY STAIRS, EXITS 1-1/2 HR. U.N.O. **WINDOW TYPES STOREFRONT WINDOWS** 1/4" = 1'-0" 1/4" = 1'-0" W5 33.3

REVISION SCHEDULE

O. DESCRIPTION DATE

DOOR WINDOW SCHEDULE BLDG D

TRUC 2024-03-21

SFW2

SHEET NO.

BLDG D: ANDERSON WINDOWS AND DOORS, SERIES E, DUAL CLAD, U.N.O. COLOR: 'SAGE' CHAPALA, ORTEGA BRIDGES: ANDERSON WINDOWS AND DOORS, SERIES E DUAL CLAD, U.N.O. **COLOR: MOODY BLUE** SEE ADDITIONAL DOOR AND WINDOW REQUIREMENTS, A8.1

ROGUE VALLEY OLIVE

ANDERSON

A85273A. TALAVERA RISER 4.2" SQ. COTTON SANTA BARBARA.

ELKAY ECTRAUD241755 UNDERMOUNT. ADA. STAINLESS. STUDIO-

PRO-FLO ELONGATED. ADA. WHITE PFCT101HEWH. 1.28 GAL/FLUSH.

MEMIS WOOD SEAT W/METAL HINGES CLOSED FMT. WHITE.

MOEN CIA CHROME 7622. 1.5 GAL/MIN. SINGLE HANDLE.

KOHLER CAXTON. UNDERMOUNT WHITE K20000.0.

MOEN CIA. VT3363EP. 1.75 GAL/MIN CHROME.

DURAVIT 700355 & 700356 60" ACRYLIC. WHITE.

BENJAMIN MOORE OC-117 SIMPLY WHITE EGGSHELL

BENJAMIN MOORE OC-117 SIMPLY WHITE FLAT.

BENJAMIN MOORE OC-117 SATIN SCUFF-X.

MOEN CIA. CHROME 6221 1.2 GAL/MIN.

BADGER 5. ½ HP.

BENJAMIN MOORE 0C-117 SATIN.

ECTRAUD21175

ISE

163 MISC FLOORING BRUSHED CONCRETE, SEAL

148 | BIKE RACK

149 | BATH PAINT

PAINT

154 | KITCHEN SINK

156 BATH SINK

159 | TOILET

161 | TUB

157 BATH FAUET

160 | TOILET SEAT

162 GARBAGE DISP.

158 | TUB/SHOWER

155 KITCHEN FAUCET

UNIT PAINT

UNIT DOORS &

BASEBOARD

153 | INTERIOR STAIRS

CLASS A ROOF, TILE CAPS AND STARTER PAN, REMAINING PANS NEW TO MATCH SUPPLIED. REDLANDS – VERIFY W/ARCHITECT. STAGGER TILE FIELD, WIRED INSTALLATION, STACK EAVE TILES TWO HIGH WITH STAGGERED OVERHANG TOP TILE OF 1"-3" MORTAR BIRDS MOUTH OPEING TO PREVENT THE INSTRUSION OF POTENTIAL FLAMES AND EMBERS, OVER EXTERIOR PLY AND 2 LAYERS CLASS A WATERPROOF BITUMINOUS UNDERLAYMENT (1 LAYER BASE SHEET NAILED AND 1 LAYER GRANULATED TOP SHEET TORCH DOWN), VALLEY FLASHING 26 GAUGE MIN. CORROSION RESISTANT SHEET METAL OVER 36" MIN. WIDE UNDERLAYMENT OF 72# MINERAL-SURFACED NON-PERFORMANCE CAP SHEET (ASTM D3909) RUN FULL LENGTH OF 5" HALF ROUND COPPER GUTTER W/4" DIA. COPPER DOWNSPOUT, LOCK ON STYLE, COMPATIBLE W/5" GUTTERS TO PREVENT THE ACCUMULATION OF LEAVES AND DEBRIS CONNECT DRAINAGE TO STORM DRAIN SYSTEM. COPPER COLLECTOR BOX PER DETAIL 97. 7/8" EXTERIOR PLASTER, PAINTED COLOR: WARM WHITE - VERIFY TEXURE WITH ARCHITECT. PROVIDE SAMPLES IN FIELD. TIGHT HAND FORMED CORNERS AND SMOOTH STEEL TROWEL FINISH, INTEGRATE FIBERGLASS MESH INTO WET BASE BROWN COAT (OMEGA PRODUCTS INTERNATIONAL CRACK ISOLATION SYSTEM OR EQUIVALENT) OVER METAL LATHE, TYVEK (TWO LAYERS AT SHEAR WALLS) AND EXTERIOR PLY. EXTERIOR WALL FINISH TO EXTEND FROM TOP OF FOUNDATION TO ROOF TERMINATING AT 2" NOMINAL SOLID WOOD BLOCKING BETWEEN 2X6 T&G KILN DRIED DOUGLAS FIR EAVES PER DETAIL 8, SMOOTH TEXTURE, SOLID BODY, STAIN 4X8 DOUGLAS FIR ROOF RAFTERS PER STRUCTUREL ENGINEER OR RAFTERS TAILS @ 24" O.C. MAX, U.N.O. SOLID BODY STAIN TO MATCH EAVES. METAL CLAD DOORS AND WINDOWS AT BLDG. A. ANDERSEN E SERIES DUAL LOW E. COLOR: OLIVE. BLACK HARDWARE. FACTORY INTERIOR PAINT WHITE METAL CLAD DOORS AND WINDOWS AT BLDG. B. ANDERSEN E SERIES DUAL LOW E. COLOR: SLATE. BLACK HARDWARE. FACTORY INTERIOR PAINT WHITE METAL CLAD DOORS AND WINDOWS AT BLDG. C. ARCADIA STEEL LOOK ALUMINUM DUAL METAL CLAD DOORS AND WINDOWS AT BLDG. D. ANDERSEN E SERIES DUAL LOW E. COLOR: SAGE. BLACK HARDWARE. FACTORY INTERIOR PAINT WHITE METAL CLAD FOORS AND WINDOWS AT BRIDGES. ANDERSEN E SERIES DUAL LOW E. COLOR: MOODY BLUE. BLACK HARDWARE. FACTORY INTERIOR PAINT MOODY BLUE DYNAMIC 'ARTE ALUMINUM' OR ARCADIA STOREFRONT DOOR OR WINDOW PER DETAIL. 2" GFRC DECORATIVE PLASTER GRILLE PER DETAILS. SUPPLY: PACIFIC REGISTER COMPANY. PLANK DOOR. REFER TO DOOR SCHEDULE. PAINT TO MATCH BLDG WINDOW COLOR DOUGLAS FIR CORBEL PER DETAIL 12. SOLID BODY STAIN COLOR DOUGLAS FIR POST 8X8 PER DETAIL 20, SOLID BODY STAIN COLOR 8X8 DOUGLAS FIR BEAM AT DECK PER DETAIL 40, 12, 5, SM,OOTH TEXTURE. SOLID BODY EXT. WALL MOUNTED INDIRECT LIGHT FIXTURE, HIGH EFFICIENCY LED LAMP W/SHIELDED GLASS, 25 WATT OR EQUIVALENT MAX, BY HANDLEMAN STUDIOS 'ANACAPA-MEDIUM' COLOR: BLACK RUST, 10"X28". OBSCURE GLASS 16B ARCADE LIGHTING. GLASS STAR LIGHT PENDANT. 18 POINT, 15" BY HOMETOWN EVOLUTION. 16C | EXT. WALL MOUNTED INDIRECT CORNER LIGHT FIXTURE, HIGH EFFICIENCY LED LAMP W/ OBSCURE GLASS, 25 WATT OR EQUIVALENT MAX. BY HANDLEMAN STUDIOS 'ARLINGTON' 16D | EXT. LIGHT FIXTURE, HIGH EFFICIENCY LED LAMP 25 WATT OR EQUIVALENT MAX, BY BARN LIGHT ELECT. 'ORIGINAL VENTED GOOSENECK LIGHT, COLOR: BLACK RUST, 12" W/16" 16E | EXT. WALL SCONCE LIGHT FIXTURE, HIGH EFFICIENCY LED LAMP W/ OBSCURE GLASS, 25 WATT OR EQUIVALENT MAX. BY HANDLEMAN STUDIOS 'BOZEMAN – SMALL' COLOR: BLACK 16F | EXT WALL SCONCE.LED. HANDELMAN. CUMBERLAND SMALL. OBSCURE GLASS.PER PLAN 16G | EXT LIGHT FIXTURE. LED. HANDELMAN. BACARRA LARGE BLACK. OBSCURE GLASS IRON RAILING, 42"H PER DETAILS AND STRUCTURAL CONNECTION. PROVIDE SHOP DRAWINGS AND SAMPLE TO ARCHITECT, TYPICAL FOR ALL IRONWORK. GALVANIZED. BLACK 18.1 | IRON RAILING @ BLDG. A, PER DETAIL 34. PROVIDE SHOP DRAWINGS. GALVANIZED SEMI 18.2 | IRON RAILING @ BLDG. B, PER DETAIL 35. PROVIDE SHOP DRAWINGS. GALVANIZED 18.3 | IRON RAILING @ BLDG. C, PER DETAIL 36. PROVIDE SHOP DRAWINGS. GALVANIZED SEMIGLOSS BLACK. 18.4 | IRON RAILING @ BLDG. D, PER DETAIL 37. PROVIDE SHOP DRAWINGS. GALVANIZED SEMIGLOSS BLACK. 18.5 | IRON RAILING @ BRIDGES, PER DETAIL 38. PROVIDE SHOP DRAWINGS. GALVANIZED SEMIGLOSS BLACK. RE-USE EXISTING SANDSTONE. 12" VENEER WITH FULL CUT CORNERS PER DETAIL. EXTEND VENEER 6" BELOW GRADE. WEEP SCREED AS REQUIRED OVER FRAMING. WEEP SCREED, PROFILE TO ALLOW PLASTER BELOW SCREED PER DETAIL. PROVIDE 26 GAUGE MIN. GALVANIZED WEEP SCREED AT FOUNDATION, 4" MIN. ABOVE GRADE OR 2" MIN. ABOVE CONCRETE/PAVING WHERE OCCURS PER DET 21 21.1 IRON BALCONY 1 W/FULL HEIGHT WALL SUPPORT PER DETAIL 11. PROVIDE SHOP DRAWINGS. GALVANIZED. BLACK SEMIGLOSS. BLDG D 21.2 | IRON BALCONY 2 W/FULL HEIGHT WALL SUPPORT PER DETAIL 32. PROVIDE SHOP DRAWINGS. GALVANIZED, BLACK SEMIGLOSS BLDG A 21.3 | IRON BALCONY 3 PER DETAIL 23. PROVIDE SHOP DRAWINGS. GALVANIZED. BLACK SEMI 21.4 | IRON BALCONY 4 PER DETAIL 39. PROVIDE SHOP DRAWINGS. GALVANIZED. BLACK SEMI

HAMMERED STONE VENEER SURROUND PER DETAIL, OVER SCRATCH COAT, FULL CORNERS.

C.M.U. EXT. BLOCK WALL PER DETAIL WITH SANDSTONE VENEER. REUSE EXISTING STONE

29.1 CANVAS CURTAIN, STEEL ROD BLACK SEMIGLOSS. BLDG. A COLOR: SUNBRELLA 'DUBONNET

29.2 CANVAS CURTAIN, STEEL ROD BLACK SEMIGLOSS. BLDG. C COLOR: SUNBRELLA 'BEAUFORT

REUSE EXISTING STONE IF POSSIBLE

SAGEBRUSH'.

| PLASTER BUTTRESS PER DETAIL 20.98.99

12X12 CAST STOME PLAQUE BY ARCHITECT


HAND FORGED IRON CHIMNEY CAP PER DETAIL 96.

REVISION SCHEDULE DESCRIPTION DATE

S

FINISHES / MATERIALS



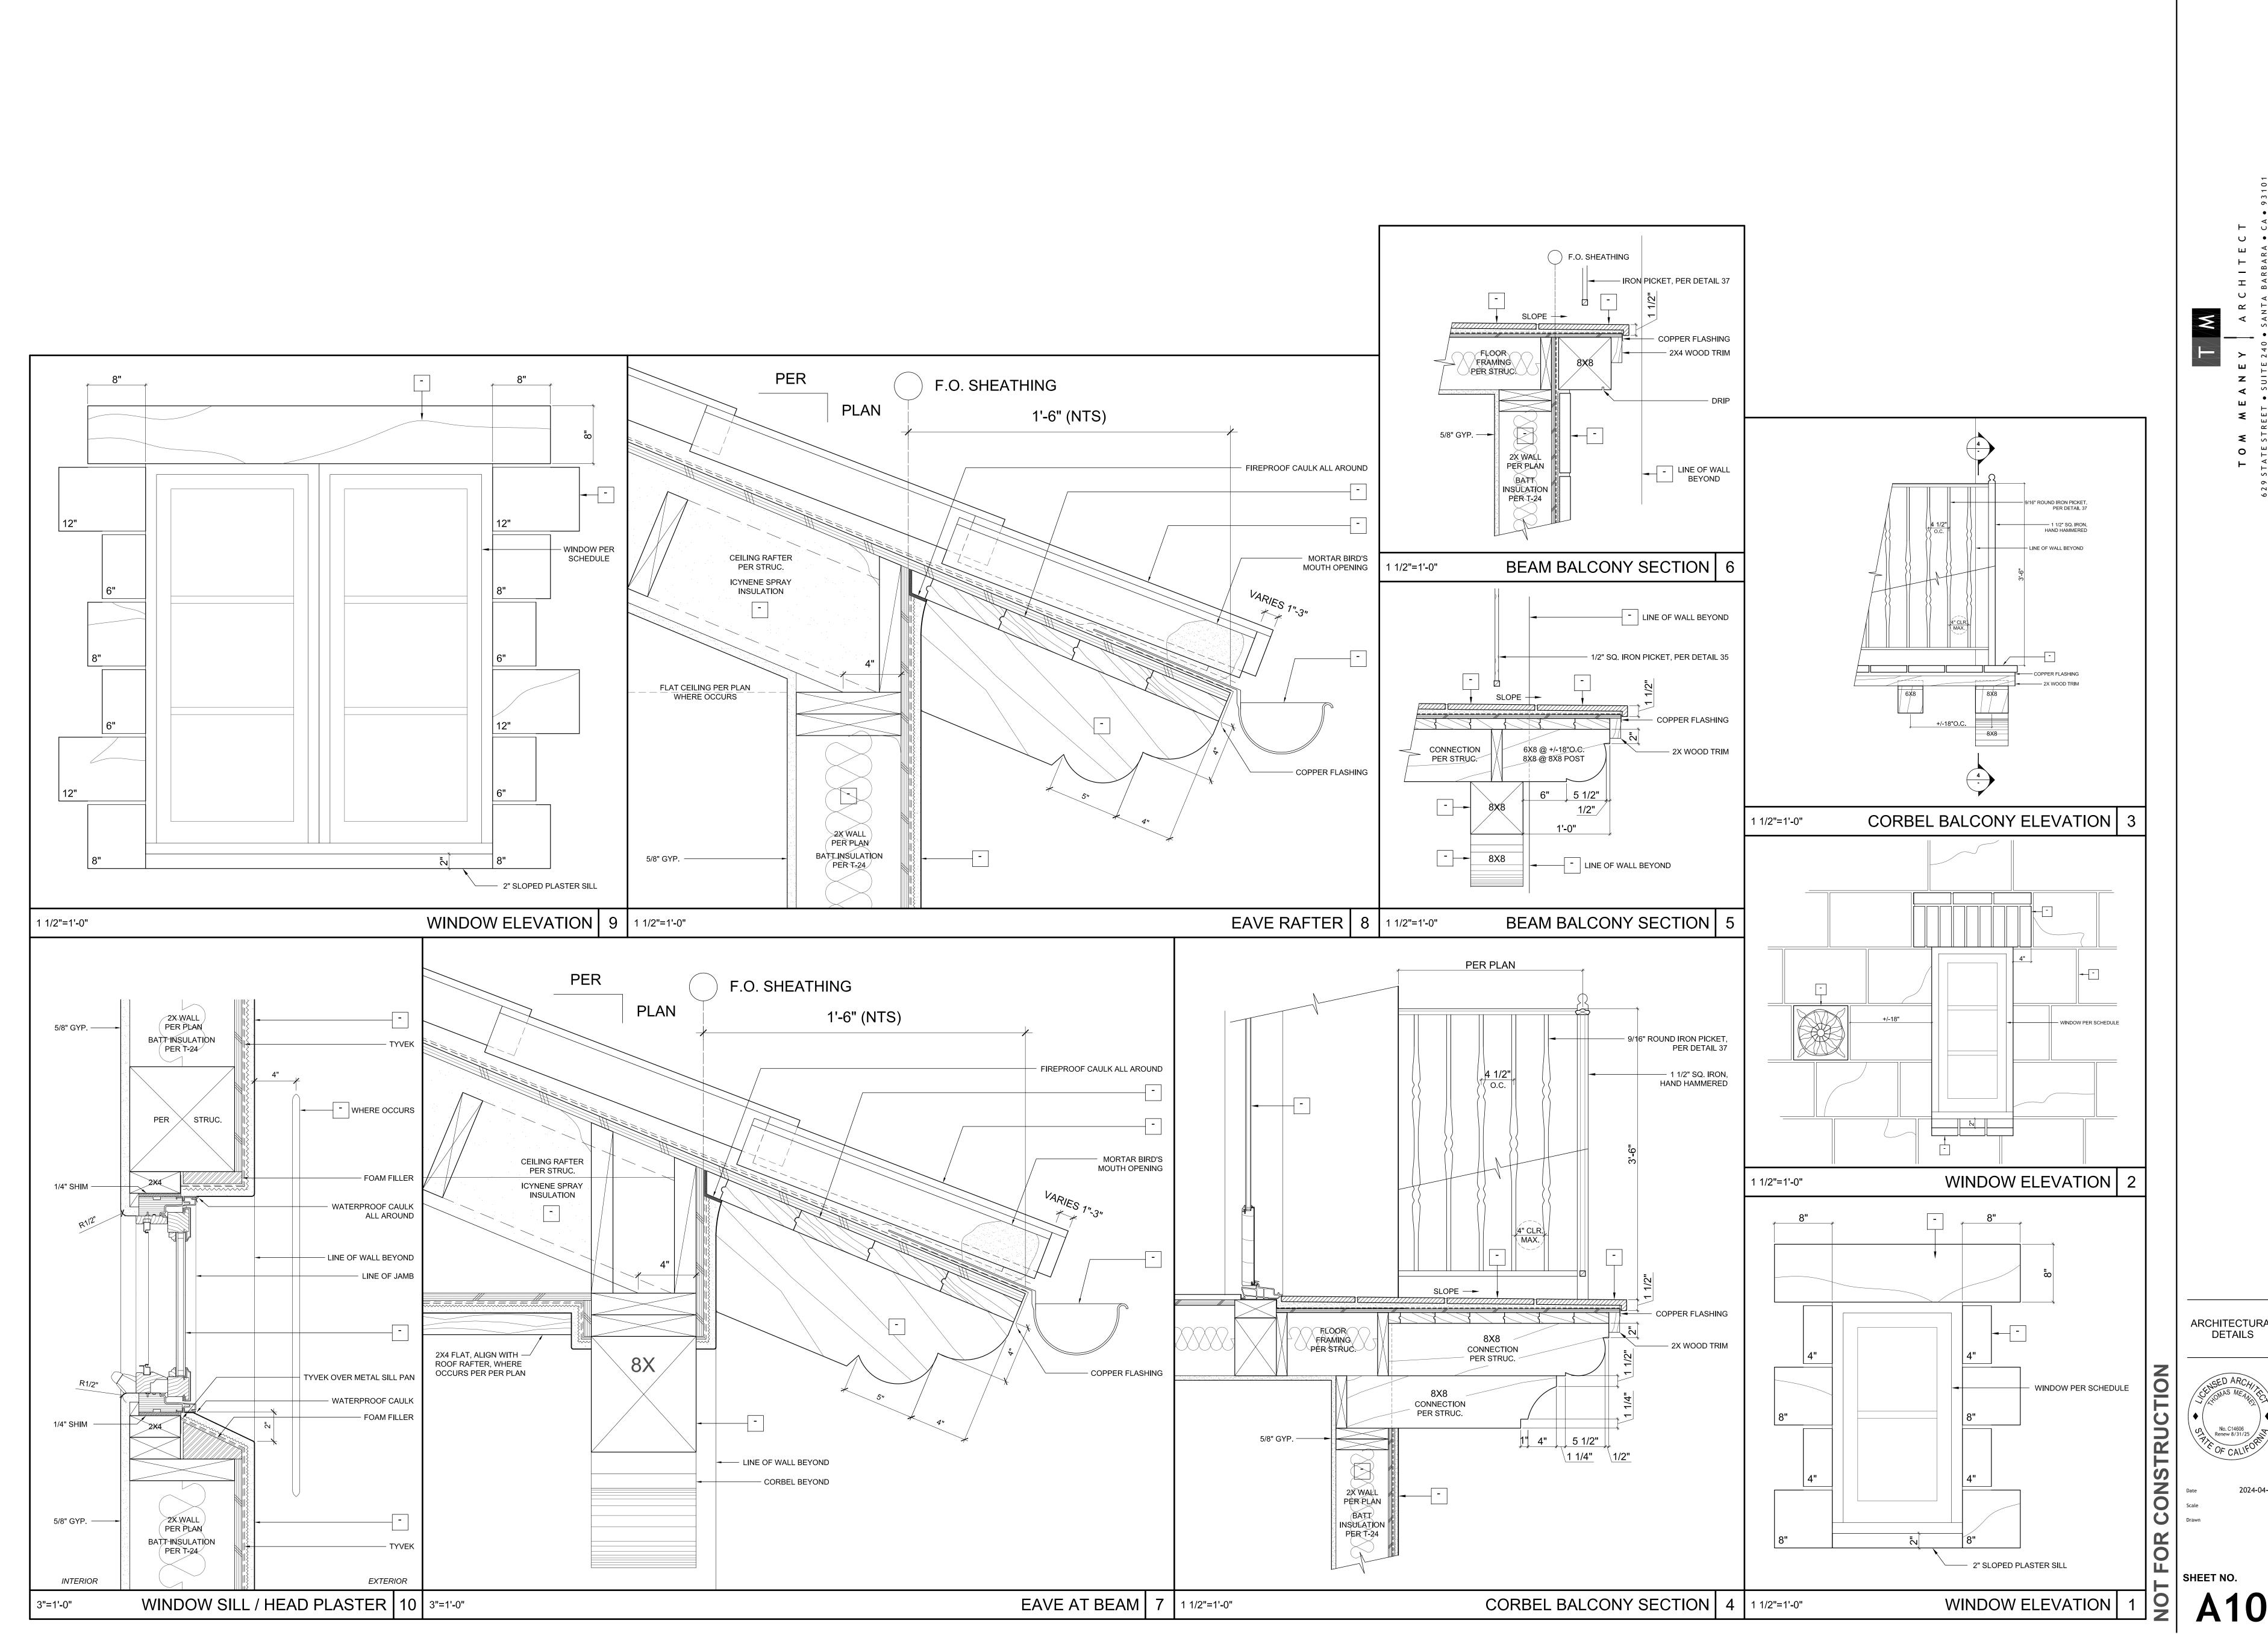


REVISION SCHEDULE O. DESCRIPTION DATE


NOTES


ALL DIMENSIONS TO FACE OF FRAMING OR PLY PER PLAN, NOTIFY ARCHITECT PER ANY PLAN DISCREPANCIES.

2. ALL KEYNOTES PER FINISH SCHEDULES

ARCHITECTURAL

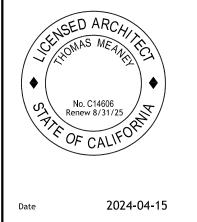


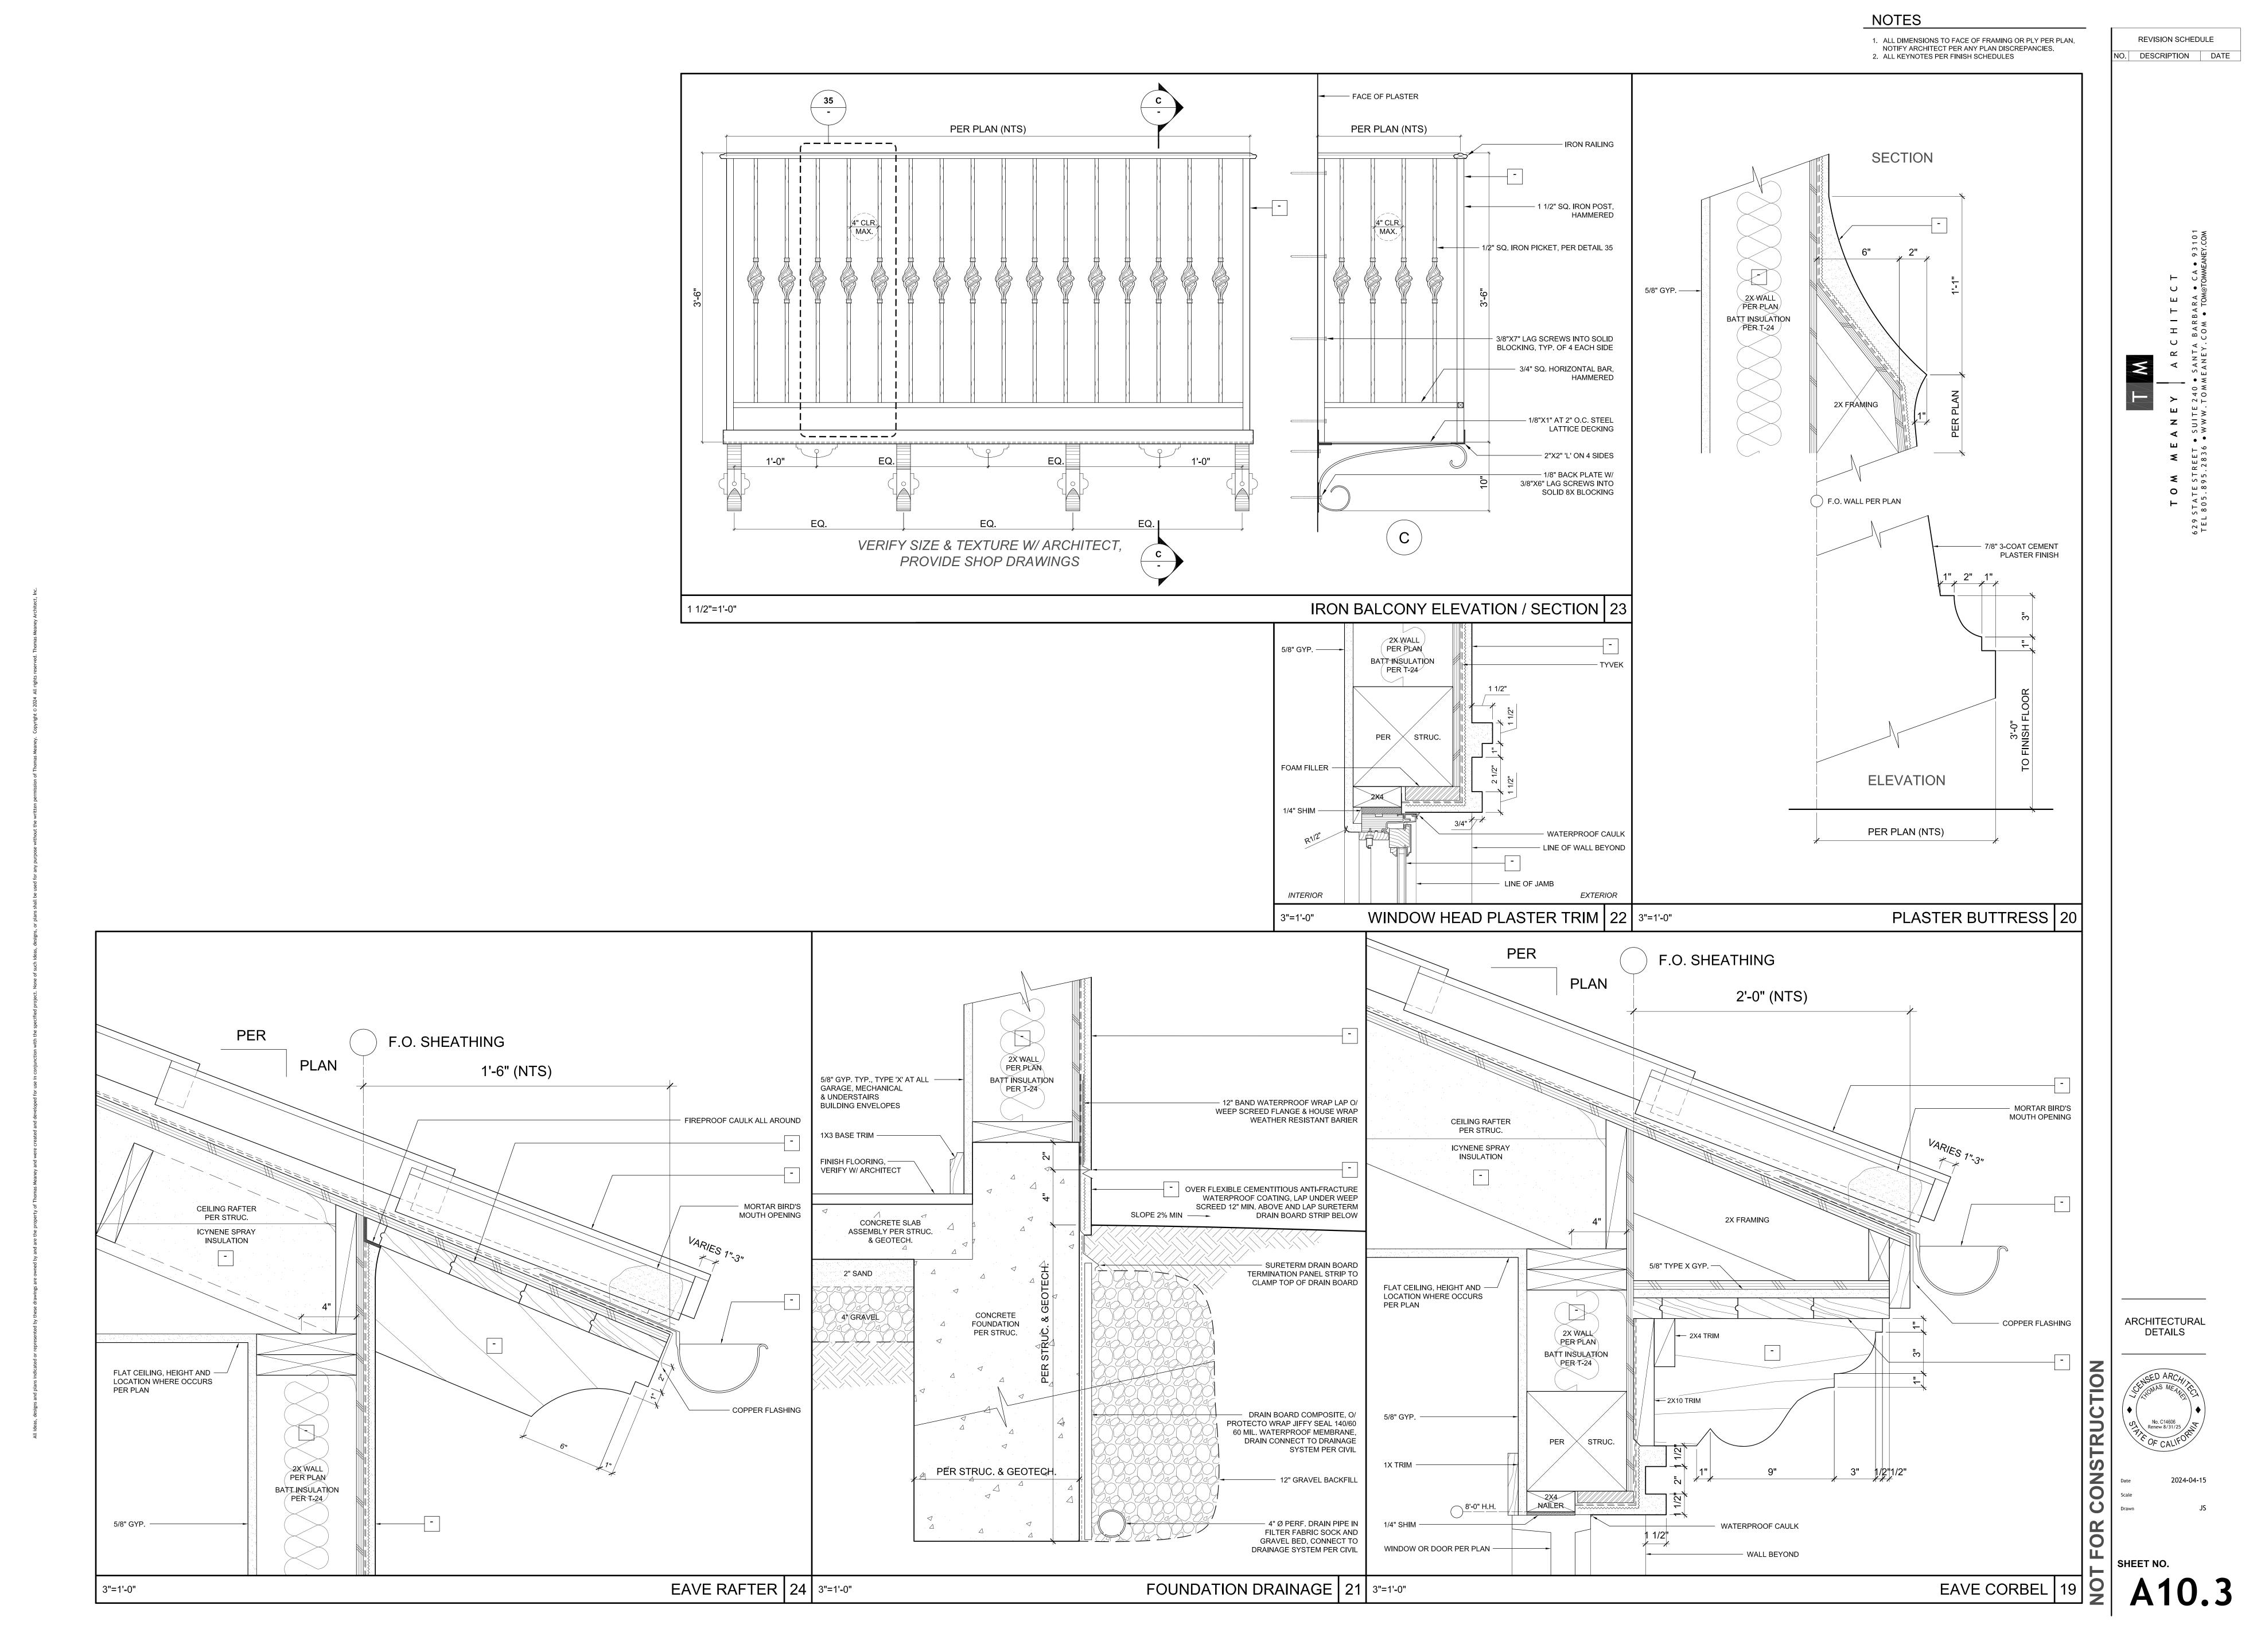

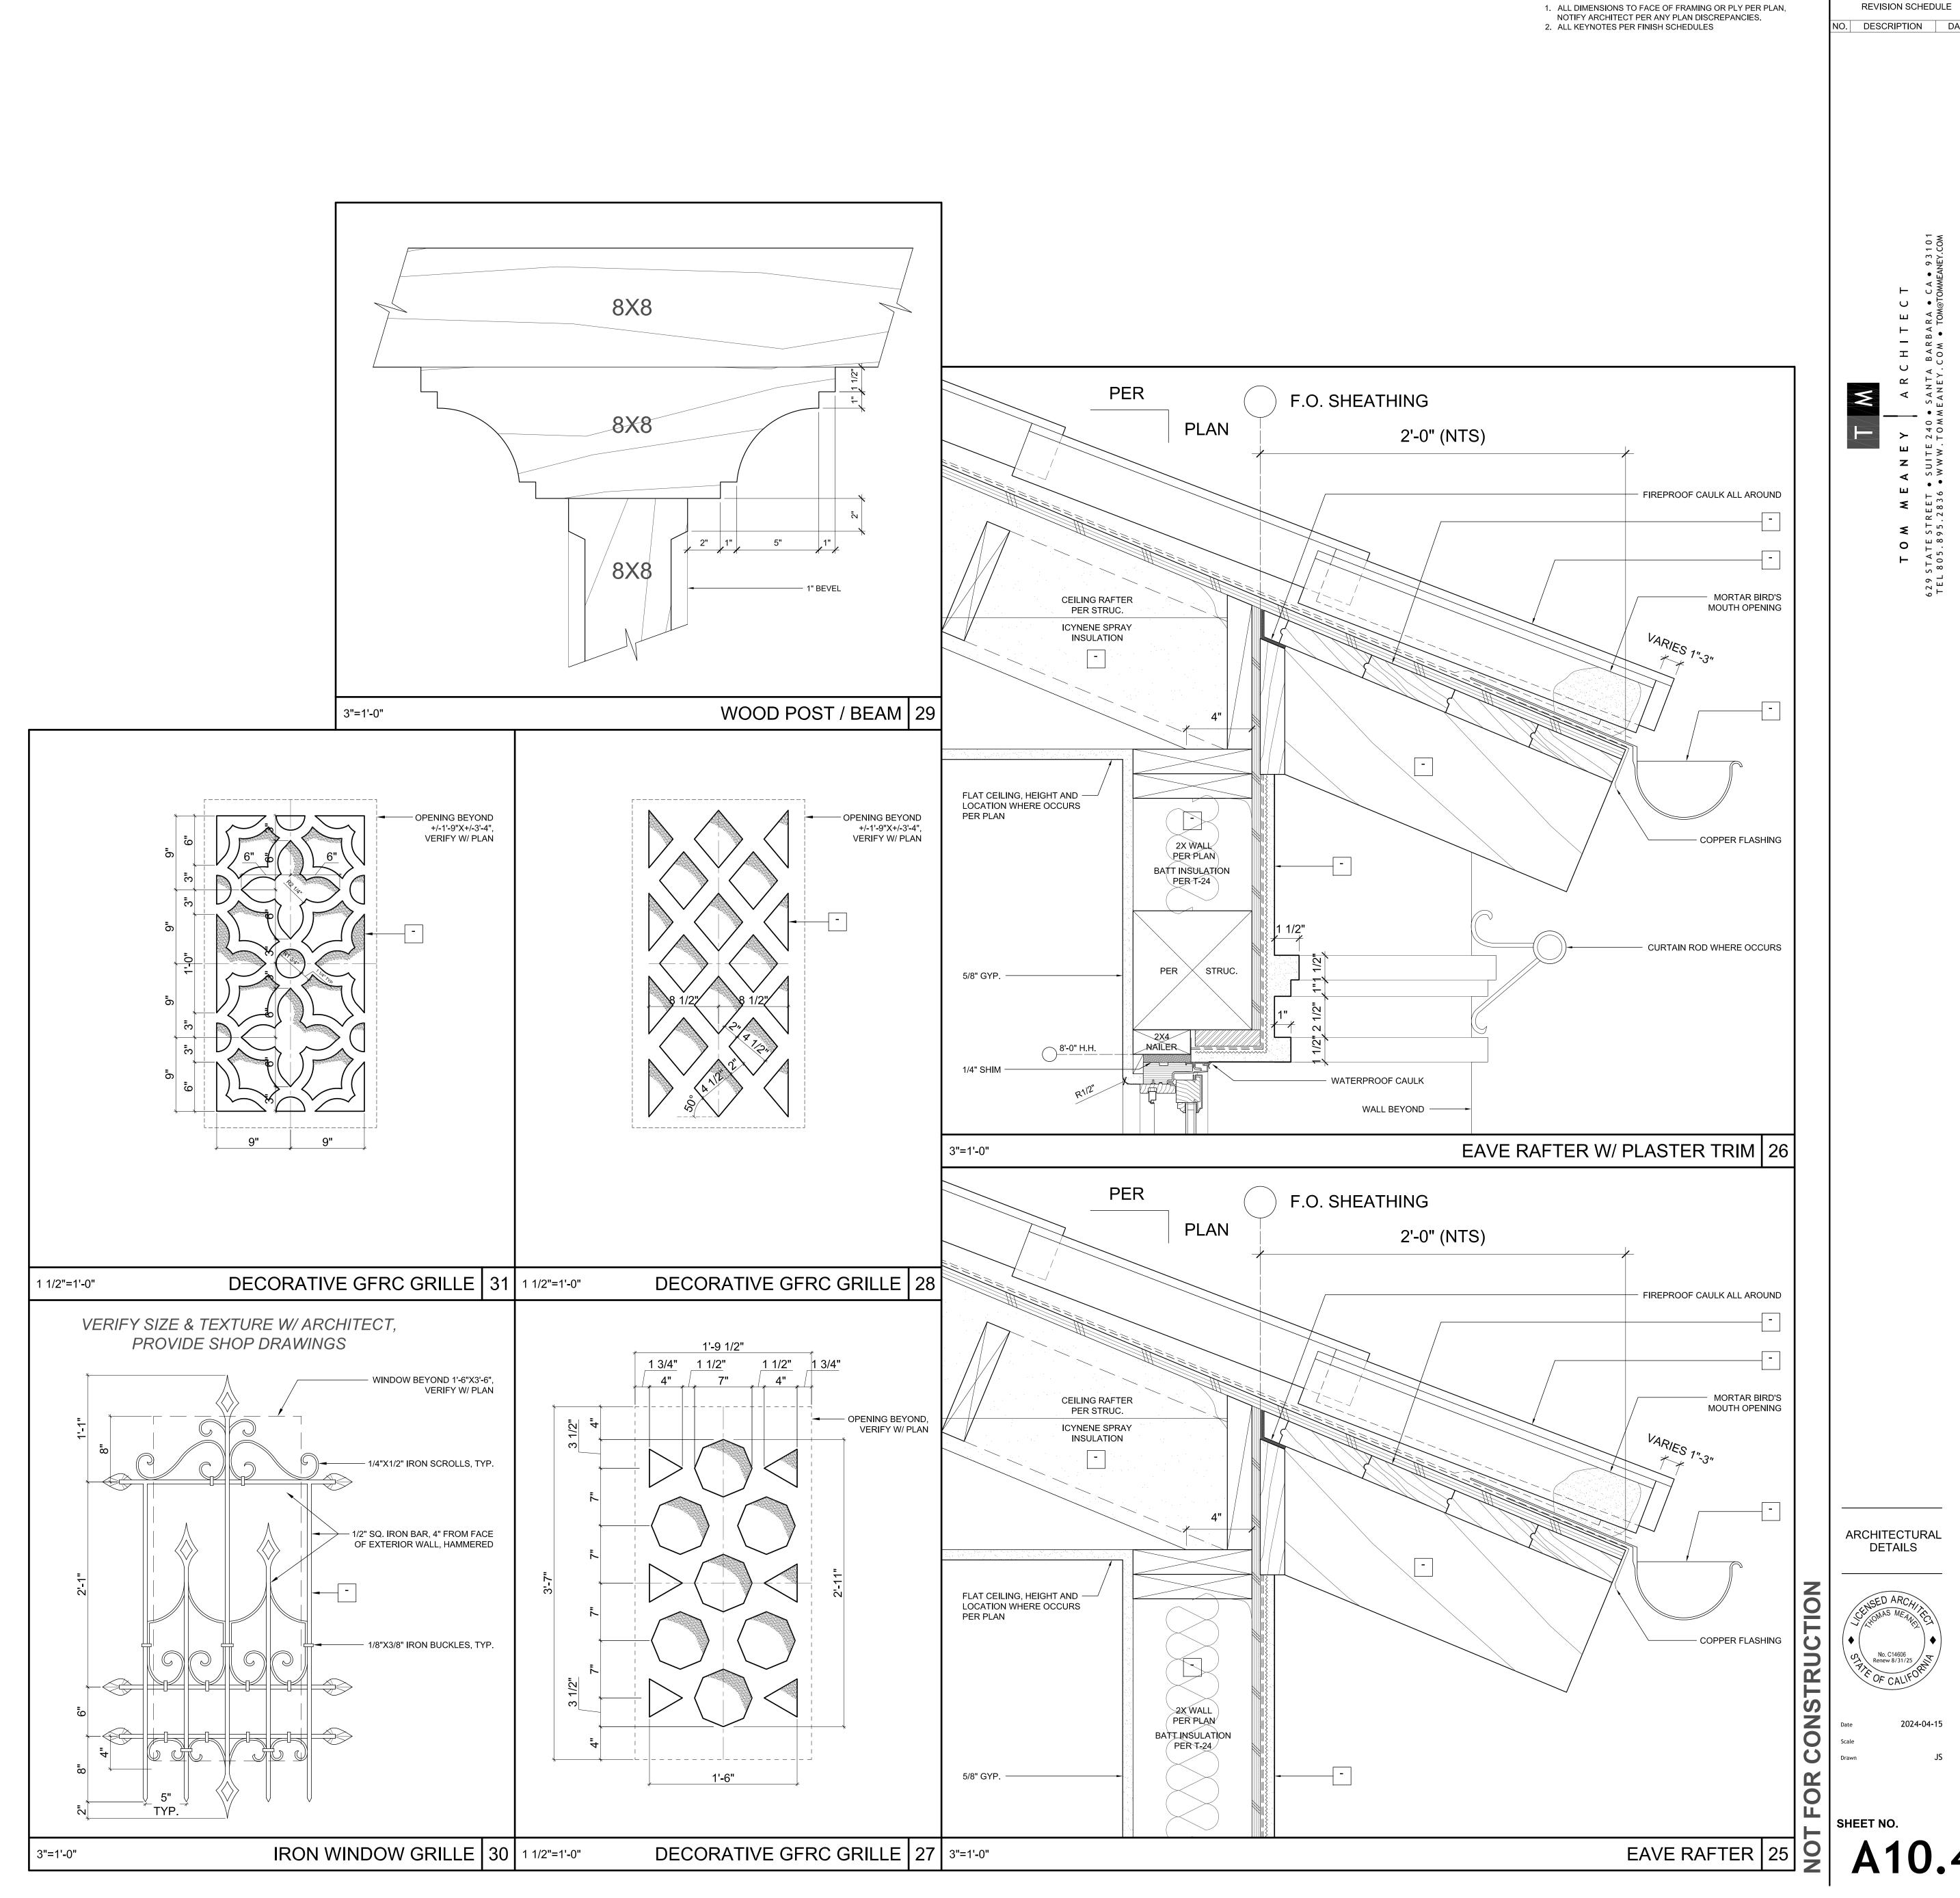



REVISION SCHEDULE NO. DESCRIPTION DATE

NOTES

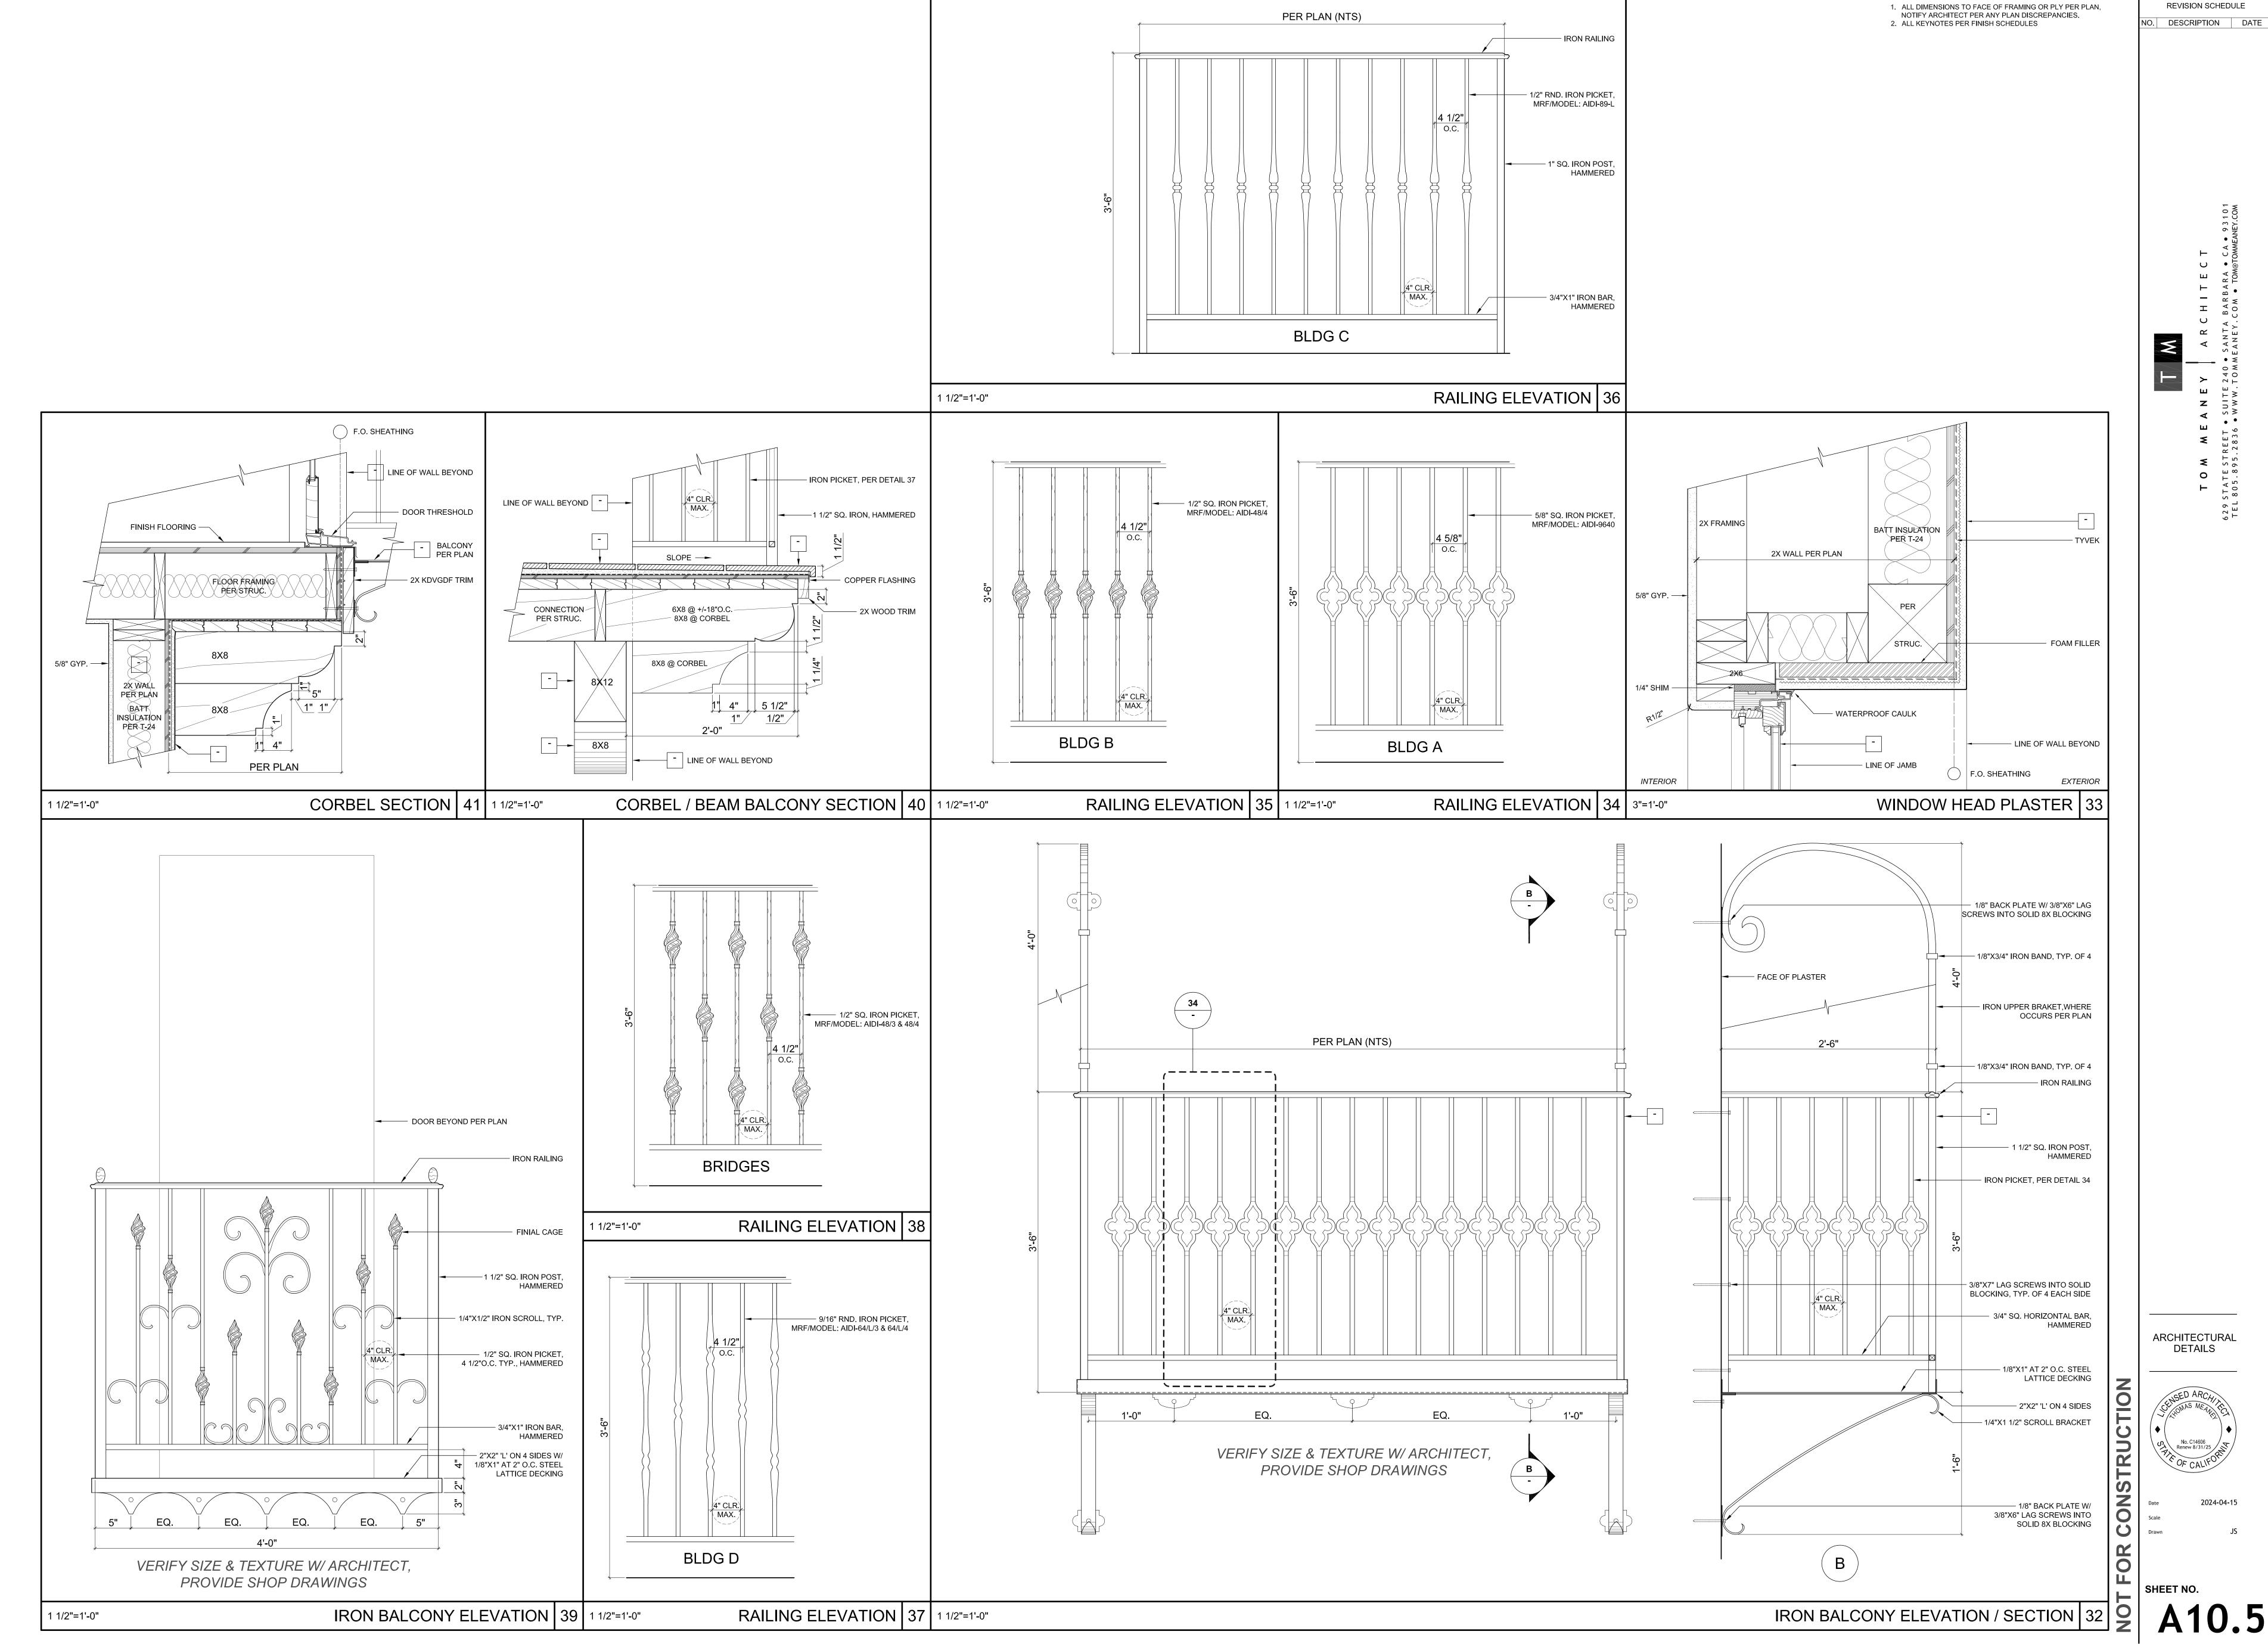



NOTES

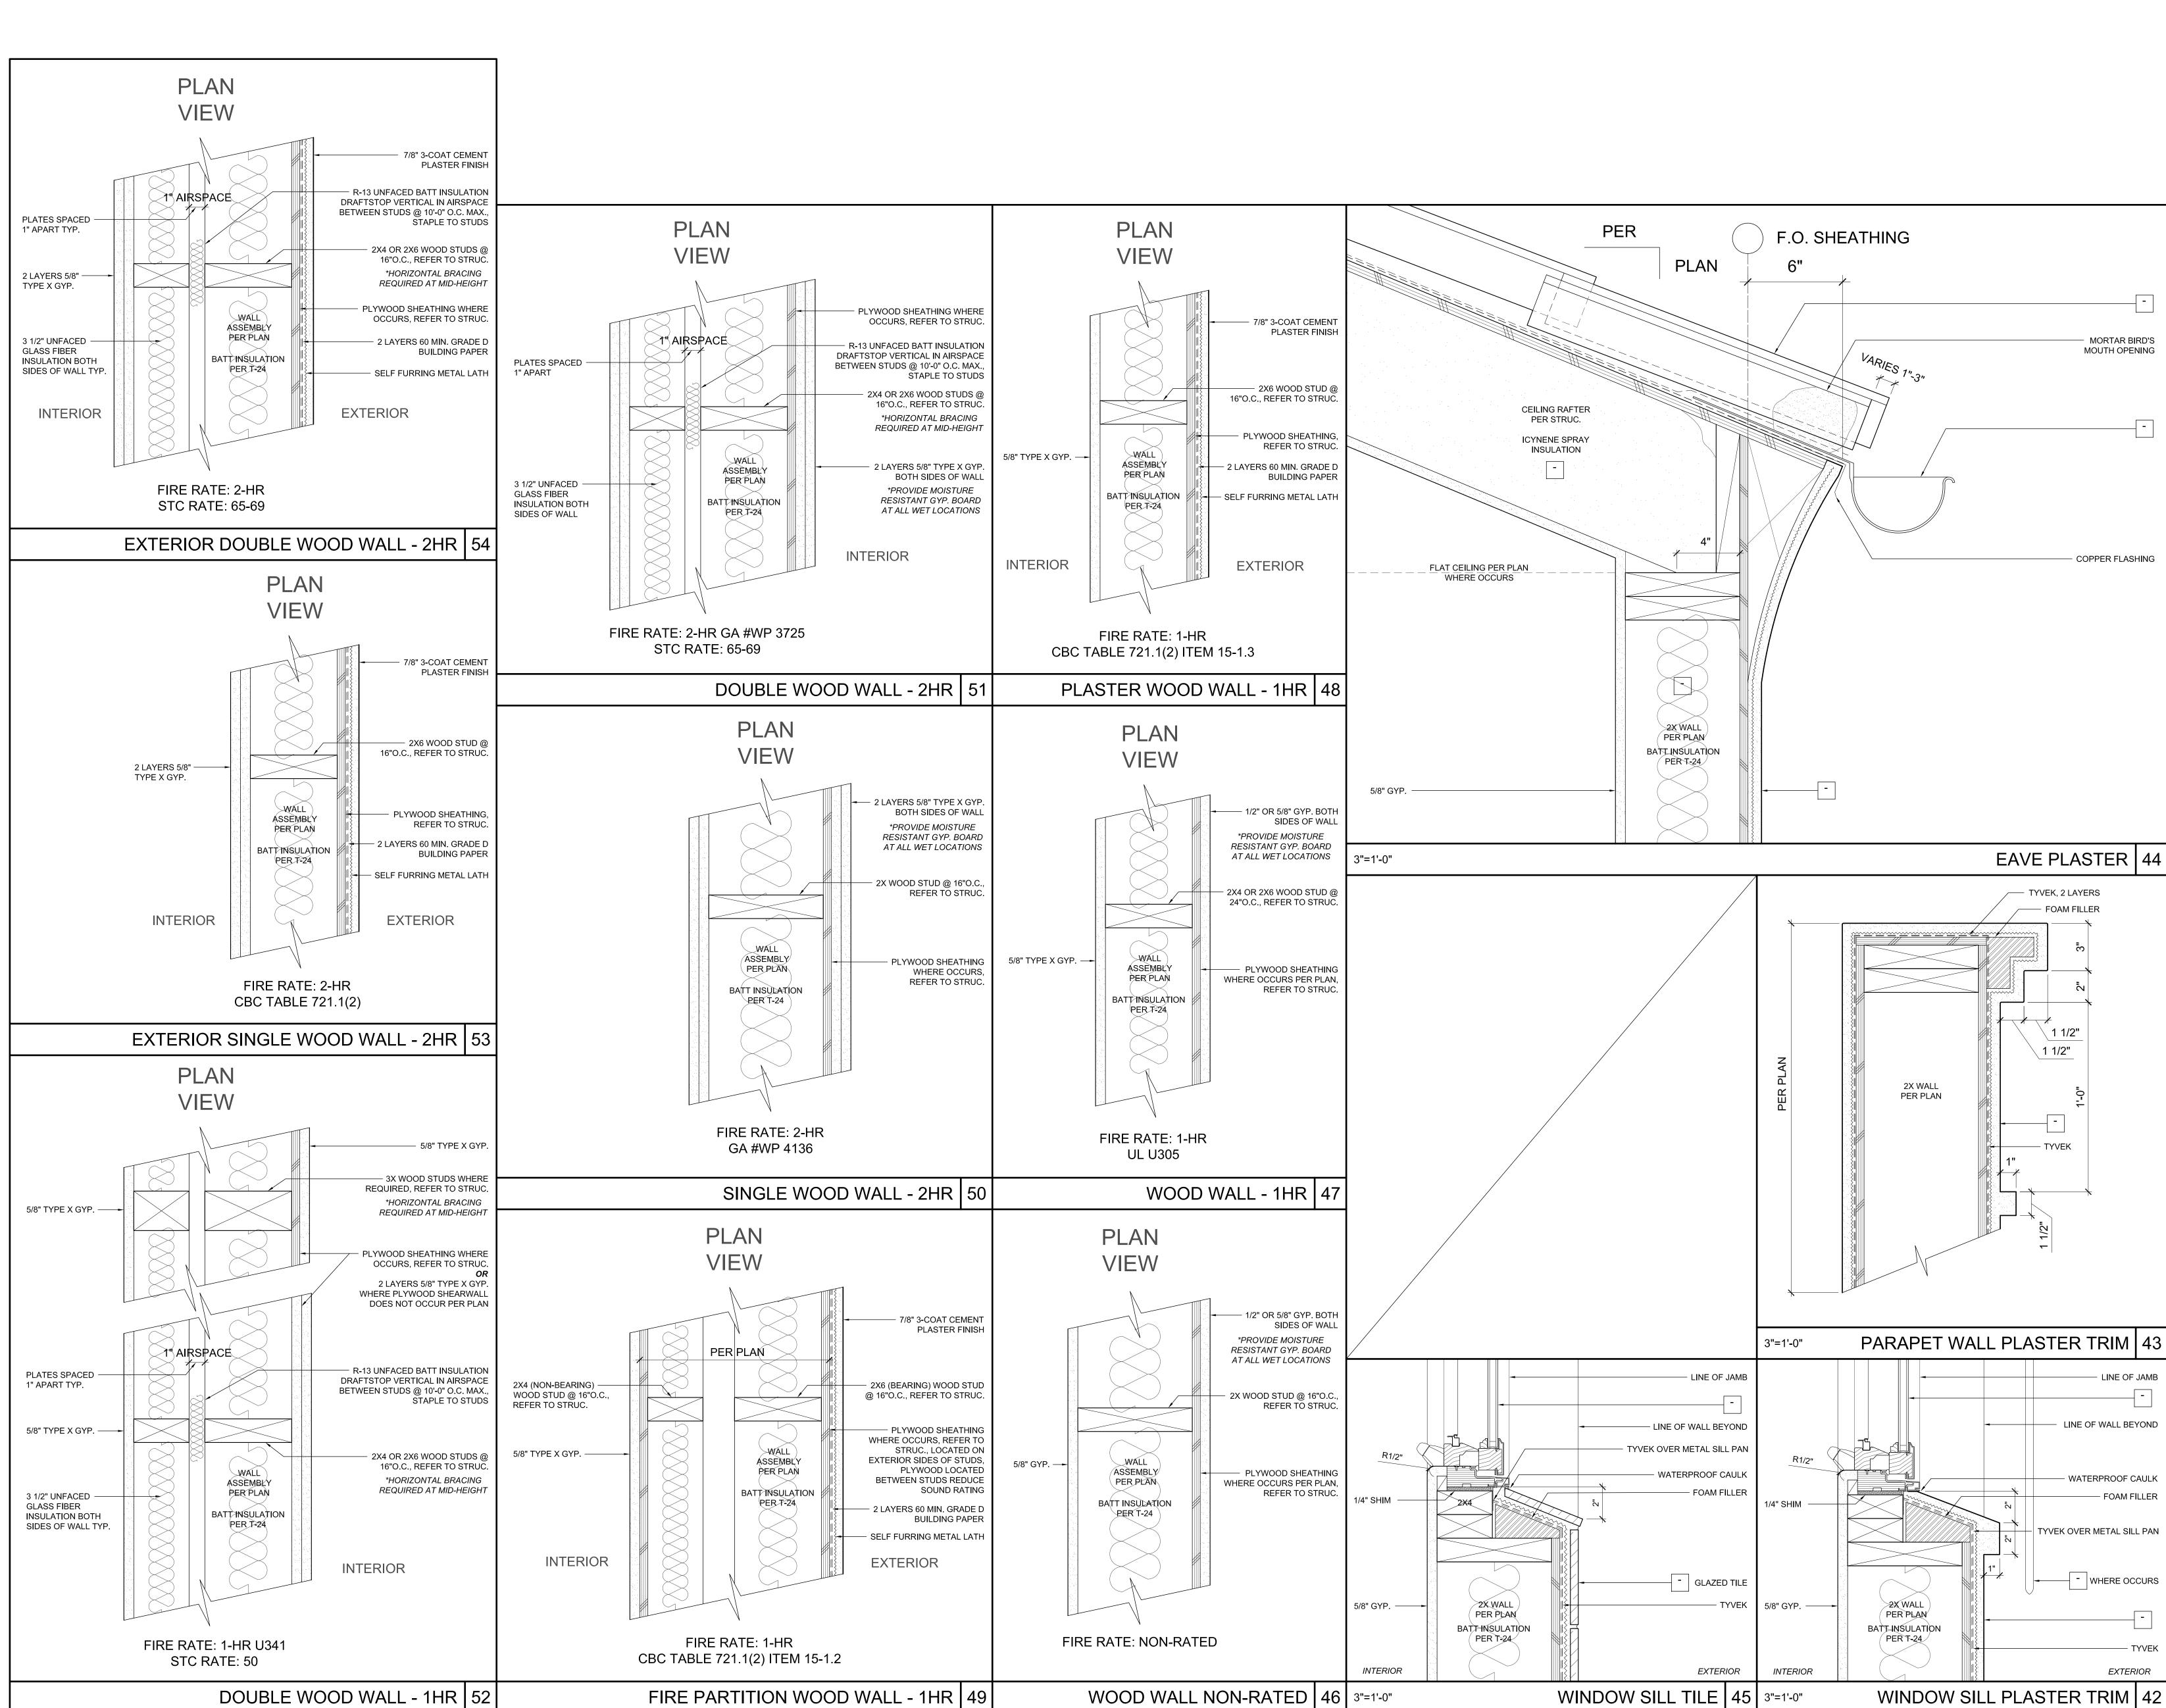

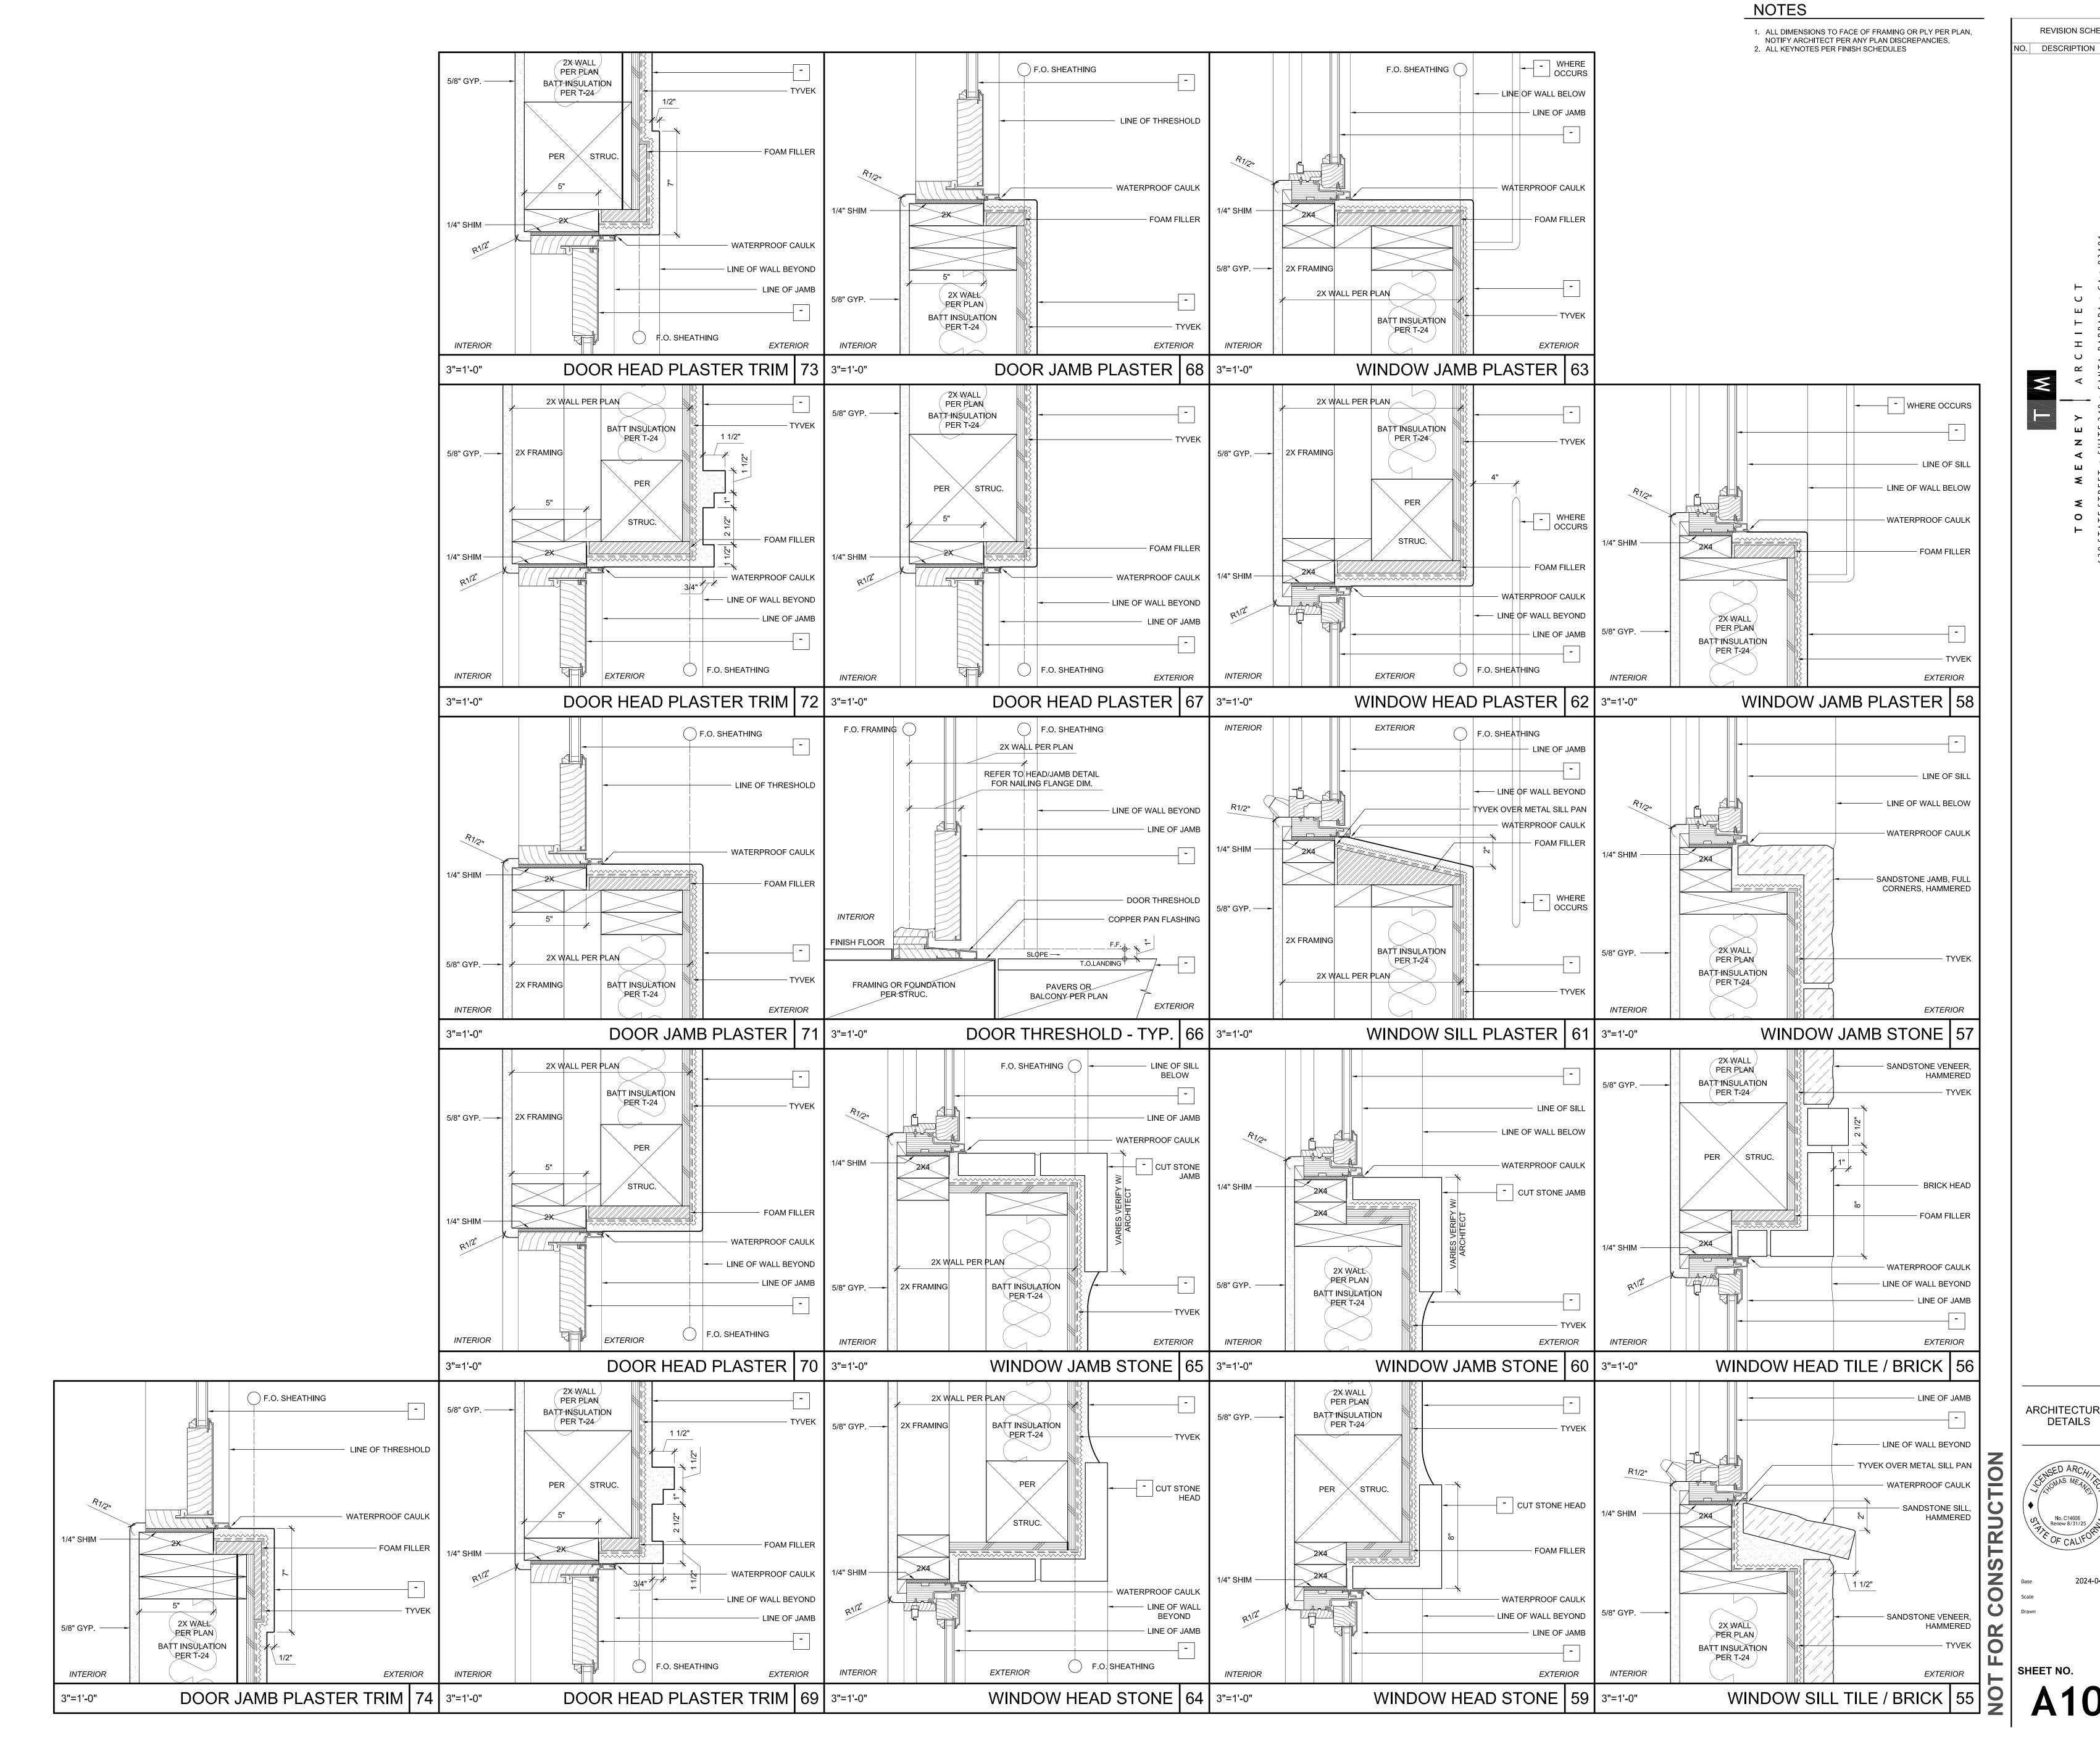

REVISION SCHEDULE O. DESCRIPTION DATE **ARCHITECTURAL**

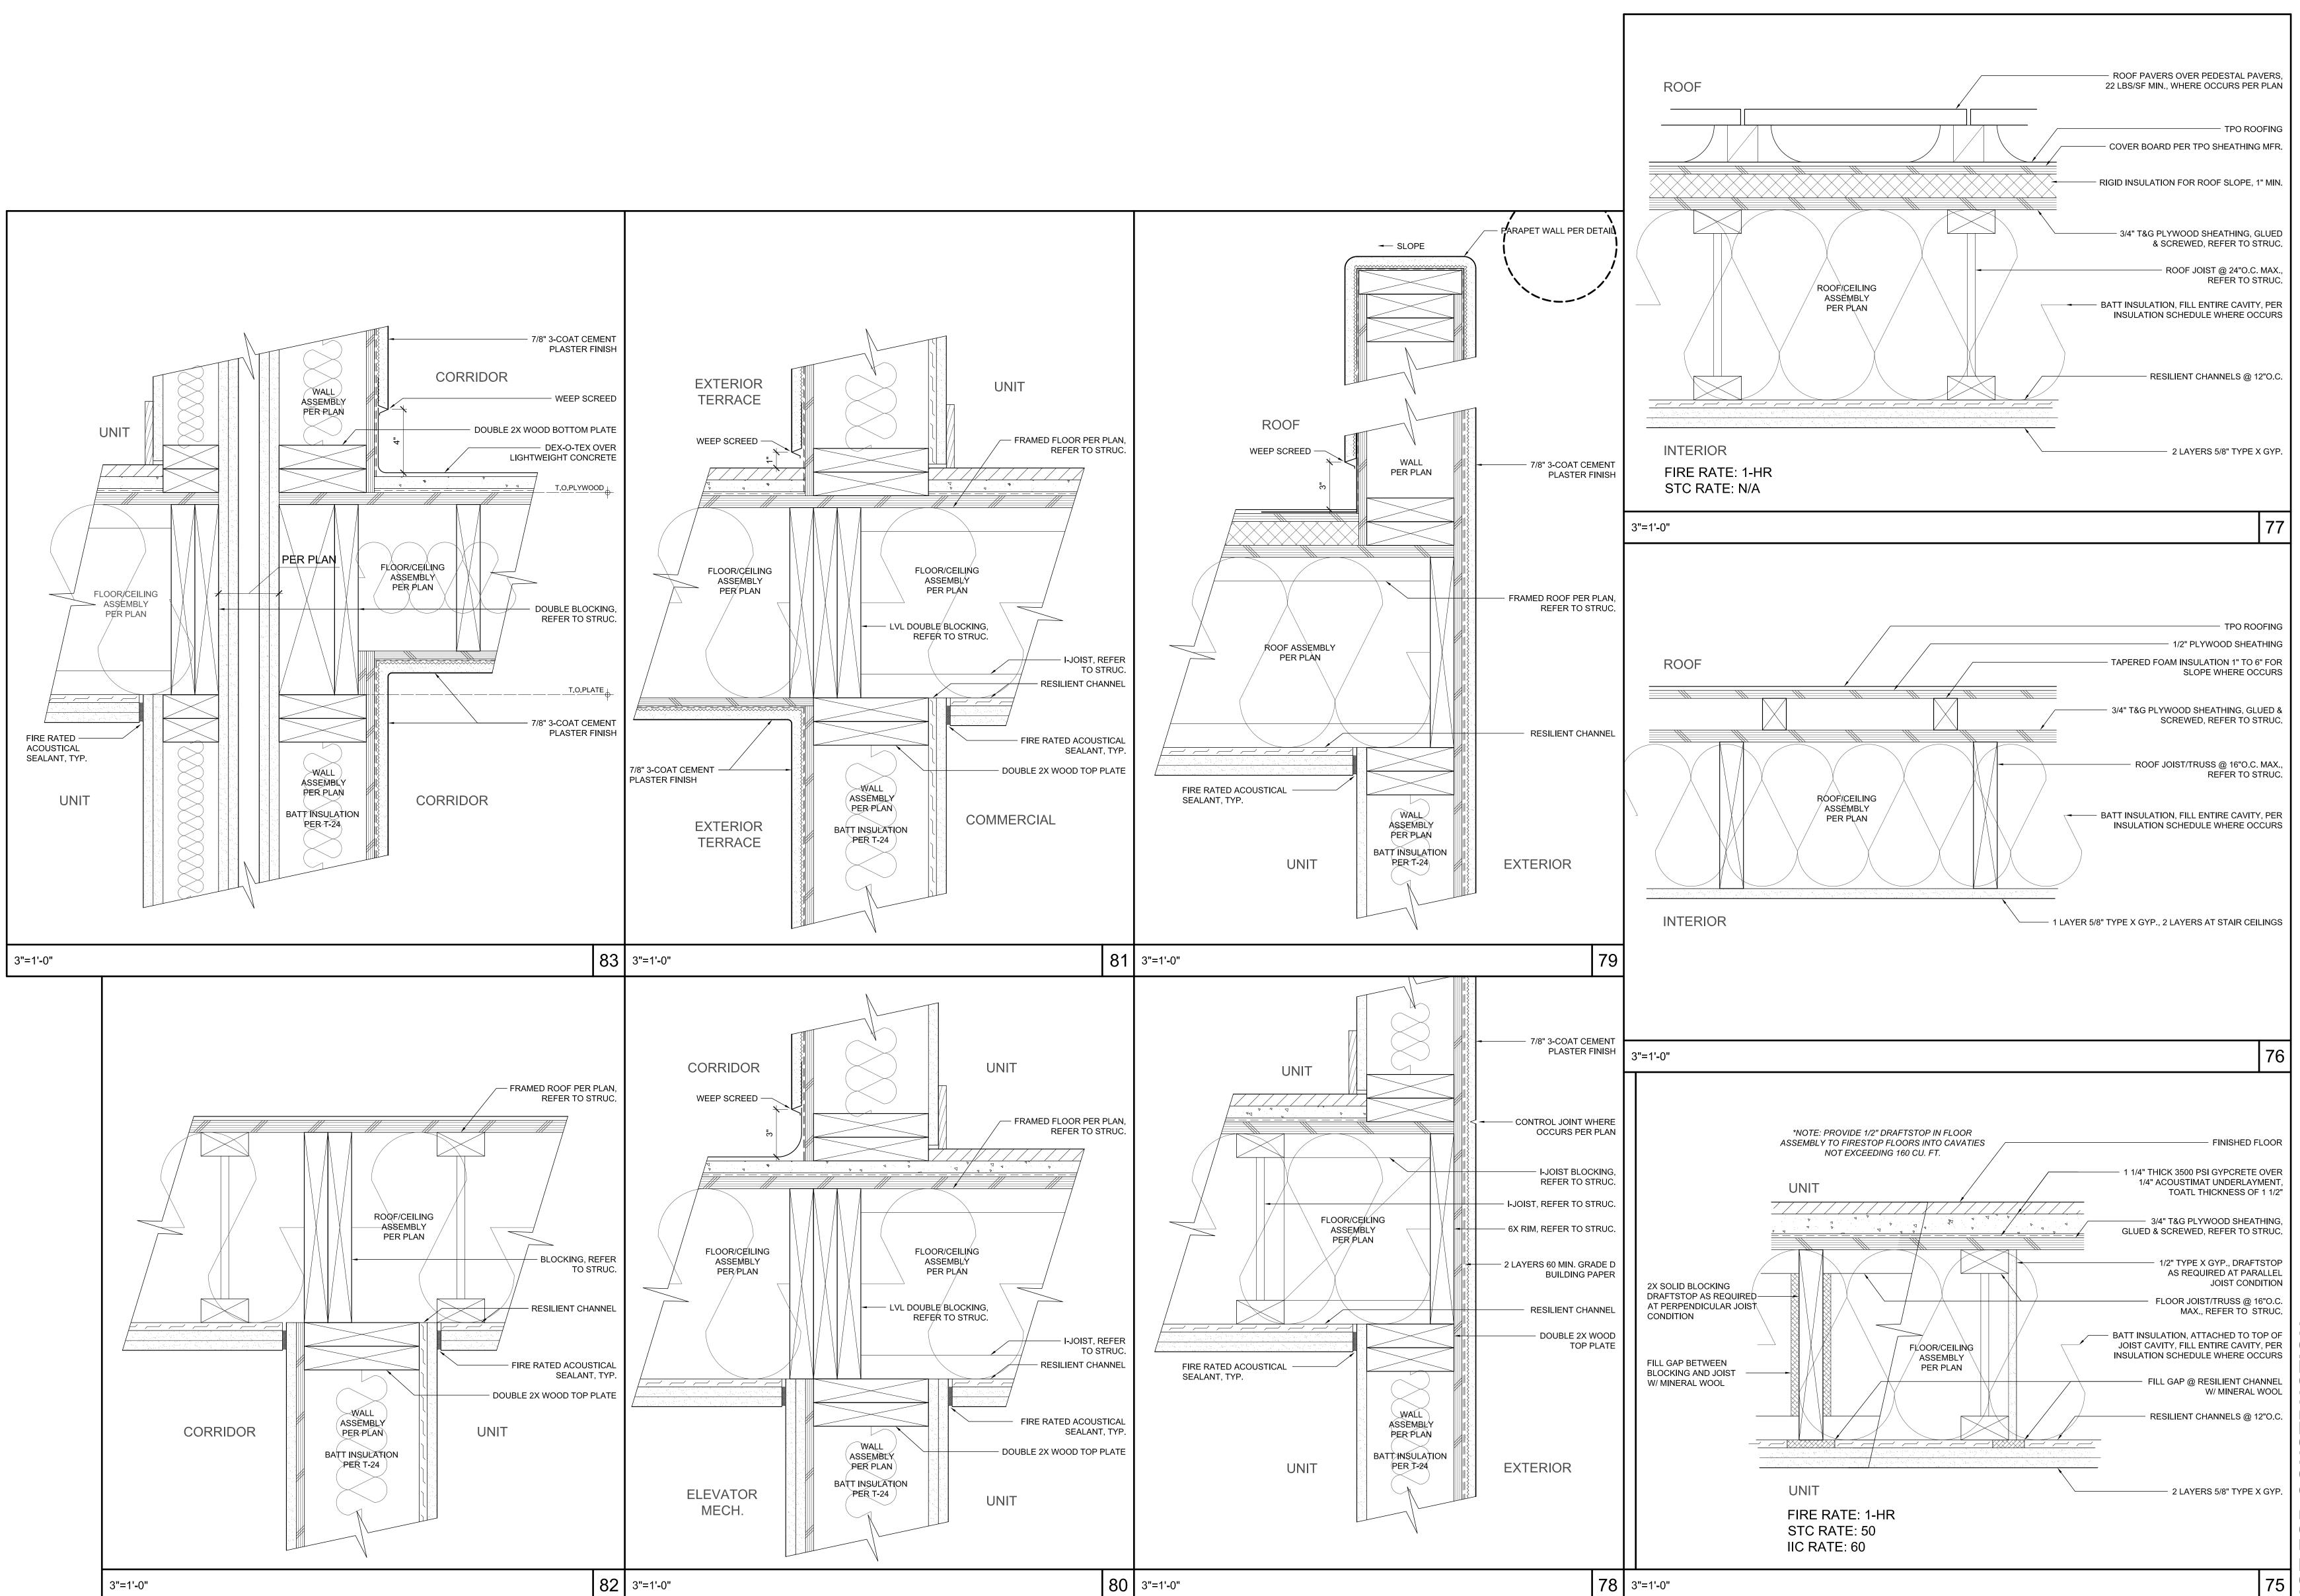

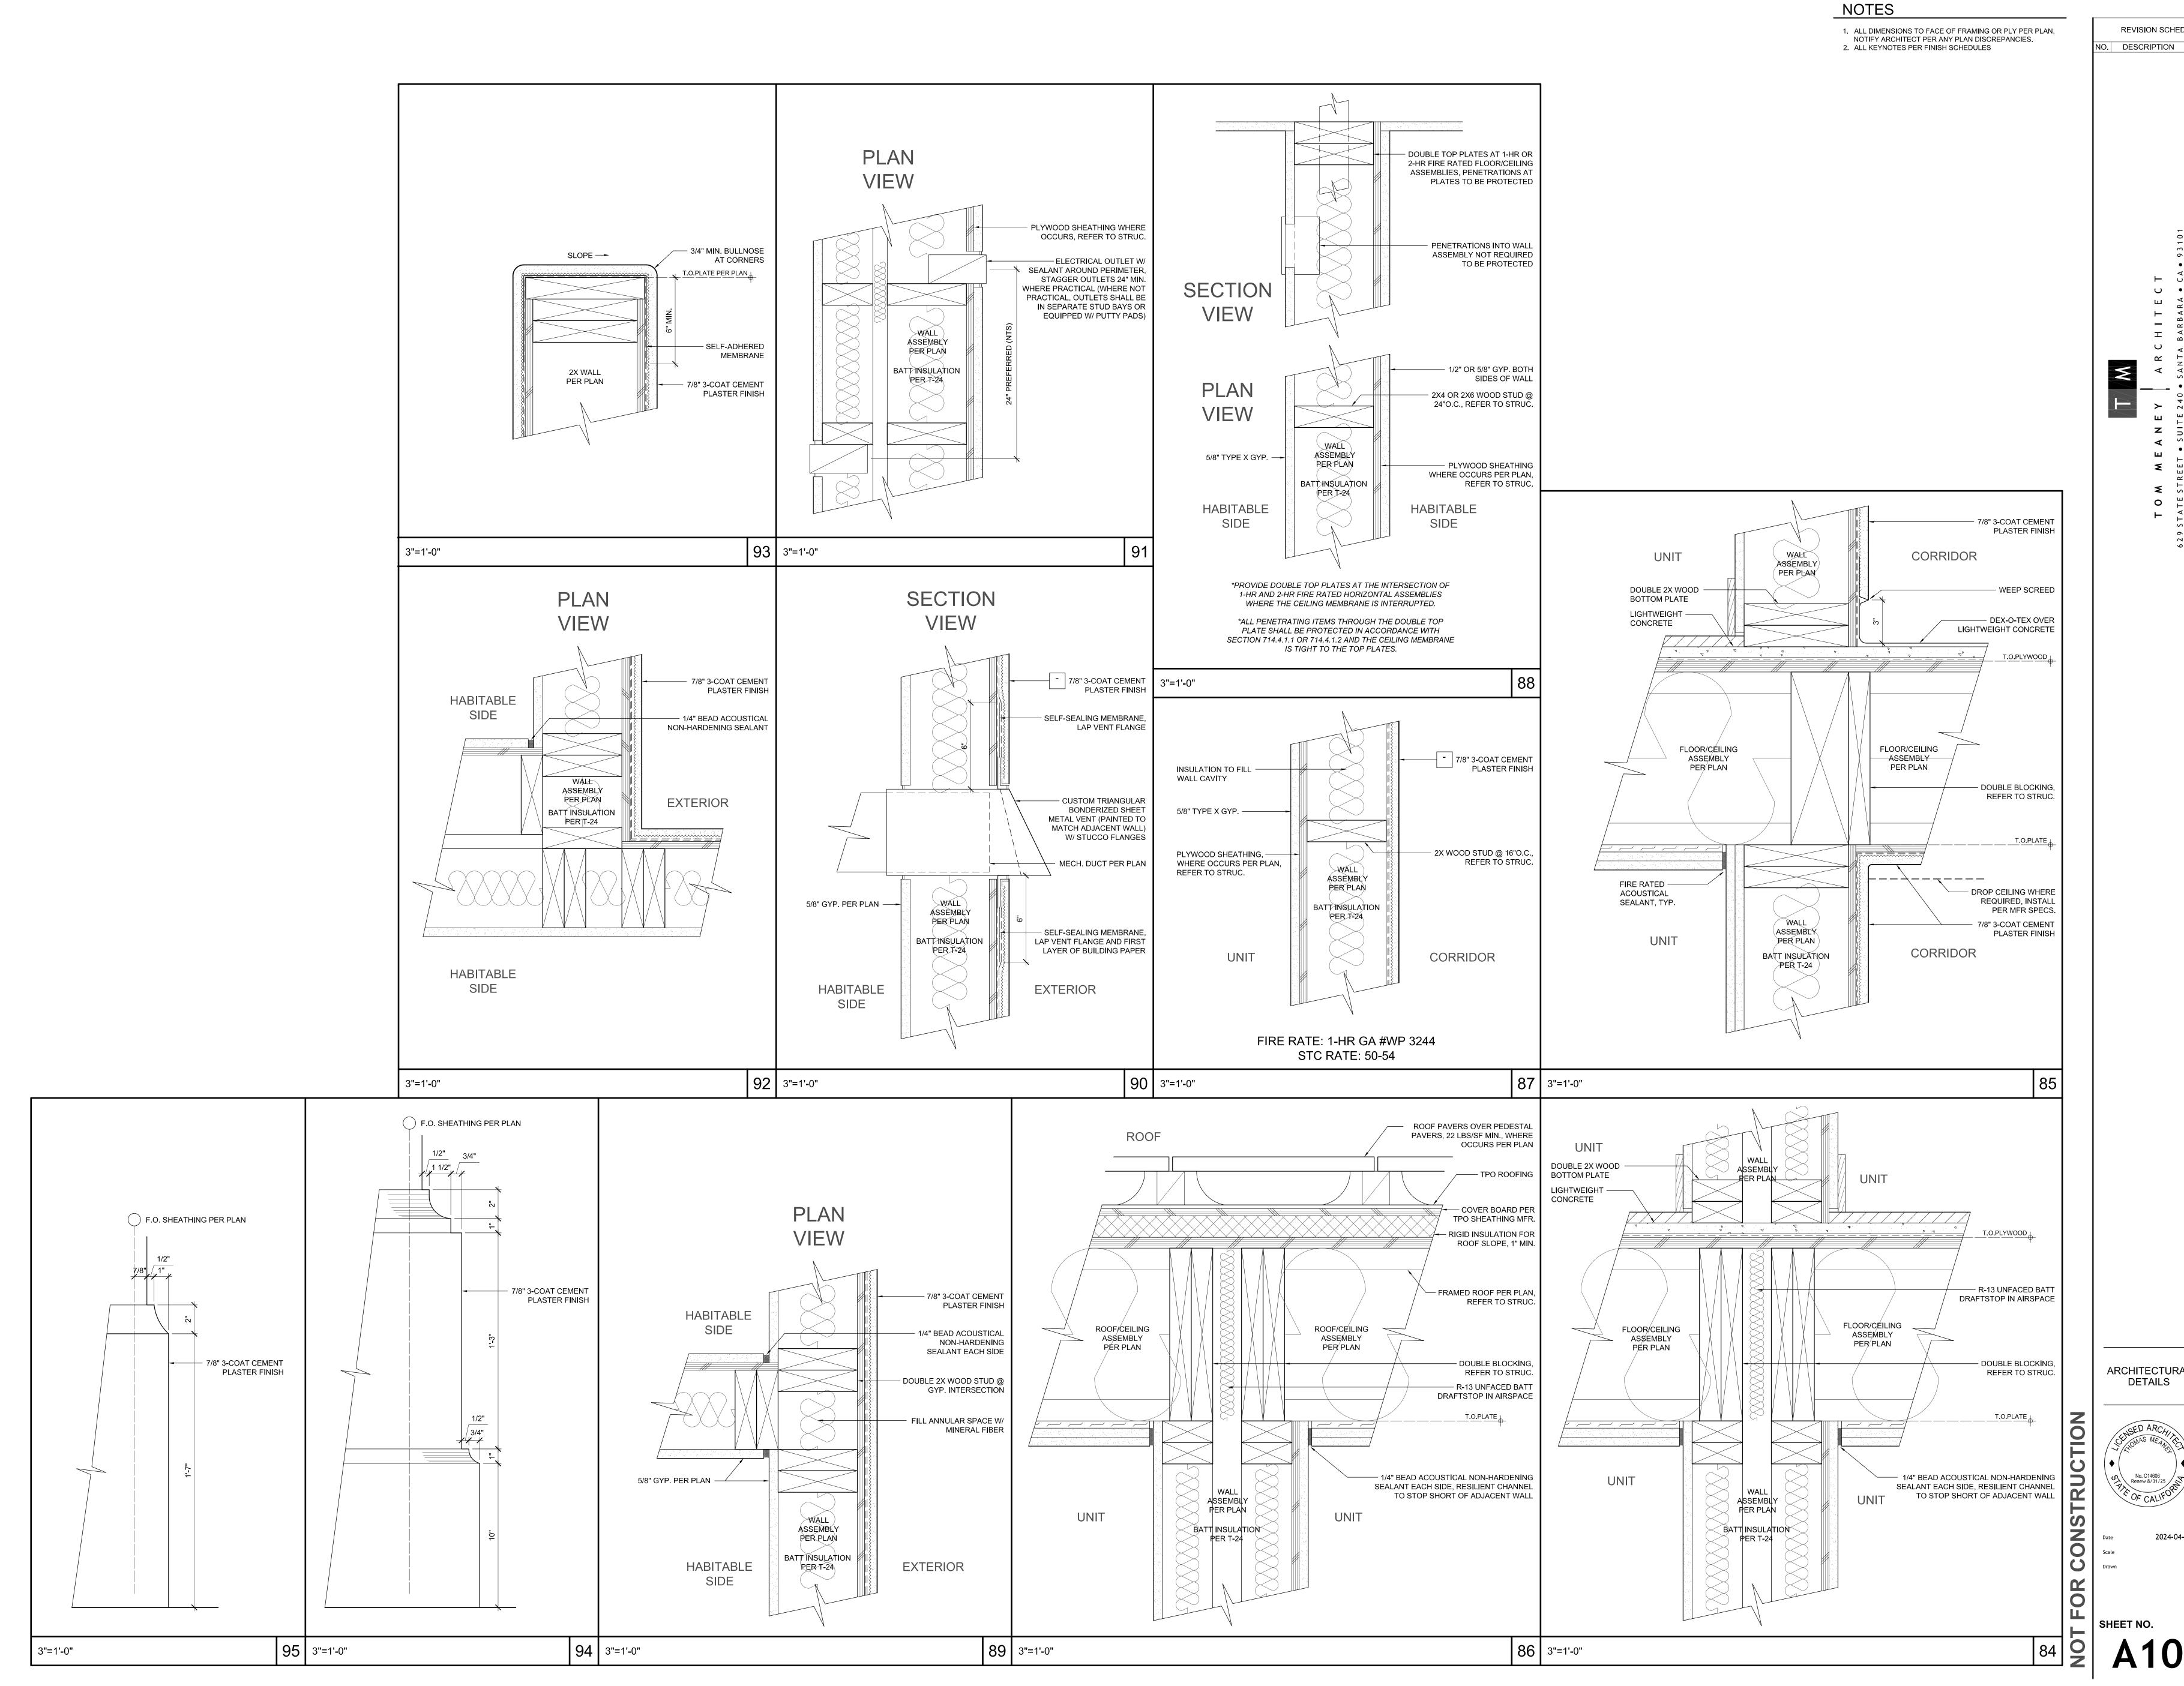

REVISION SCHEDULE O. DESCRIPTION DATE


ARCHITECTURAL



O. DESCRIPTION DATE


ALL DIMENSIONS TO FACE OF FRAMING OR PLY PER PLAN, NOTIFY ARCHITECT PER ANY PLAN DISCREPANCIES.
 ALL KEYNOTES PER FINISH SCHEDULES

REVISION SCHEDULE NO. DESCRIPTION DATE

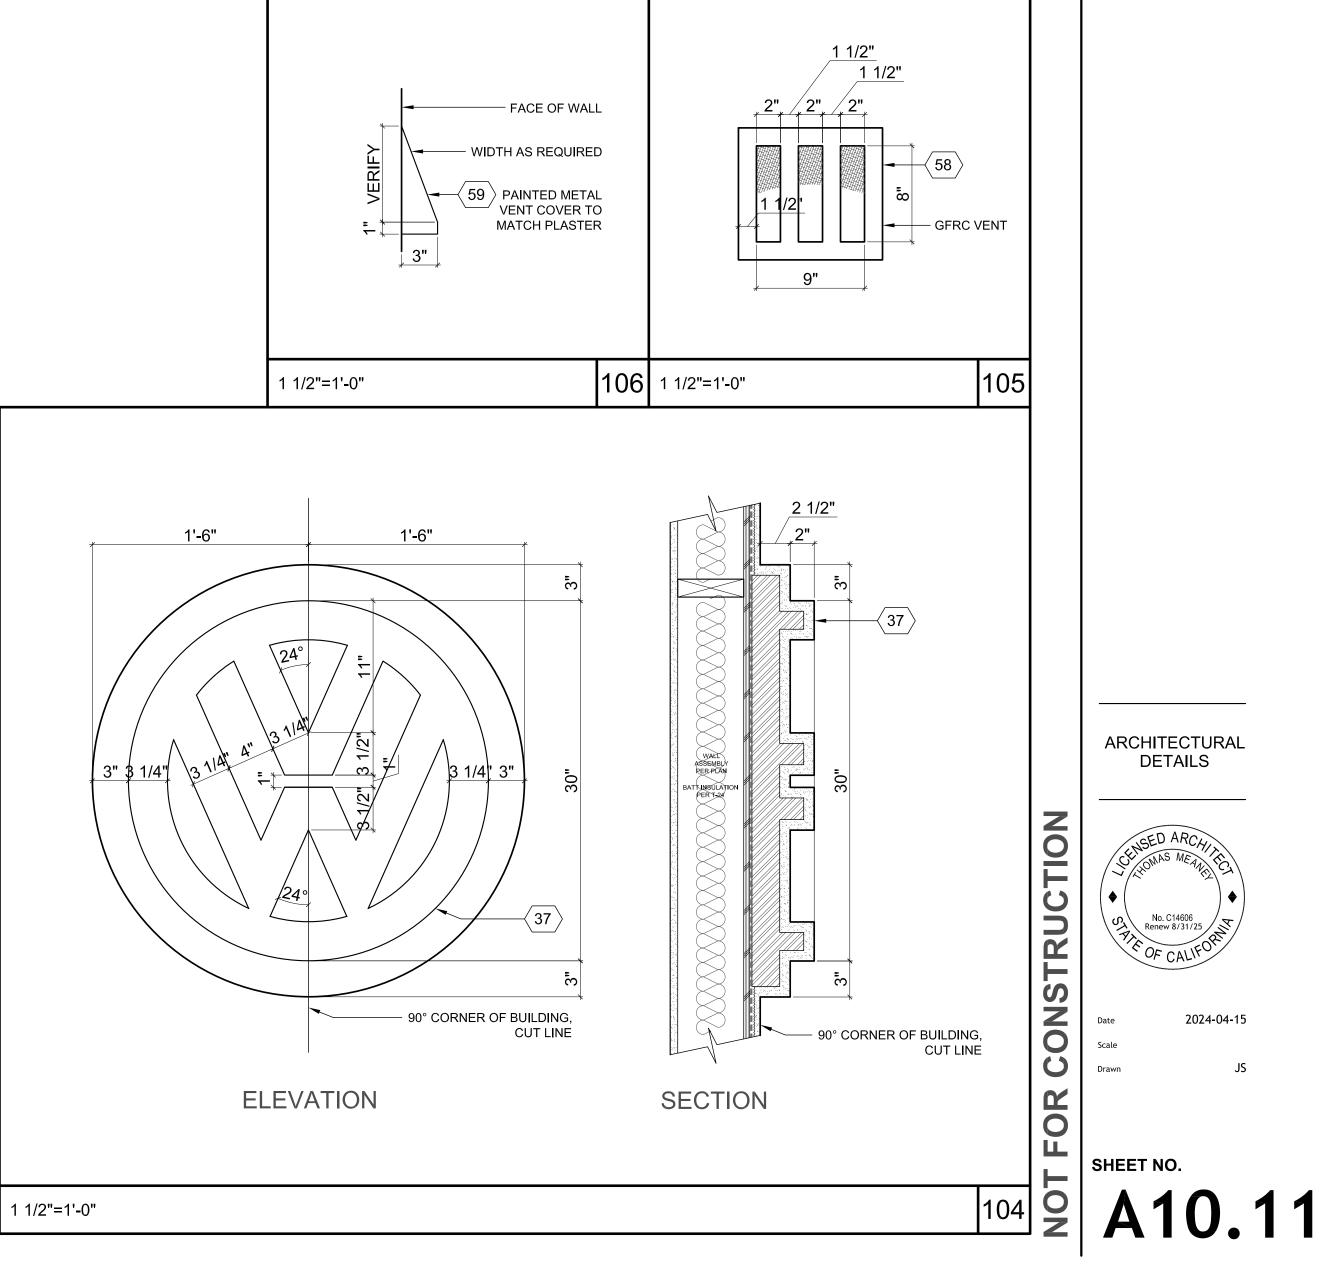


1 1/2"=1'-0"

ARCHITECTURAL DETAILS

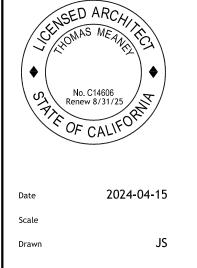

4/15/24 ale |"=|0'-0"

Drawn N.O.T. CHAPALA

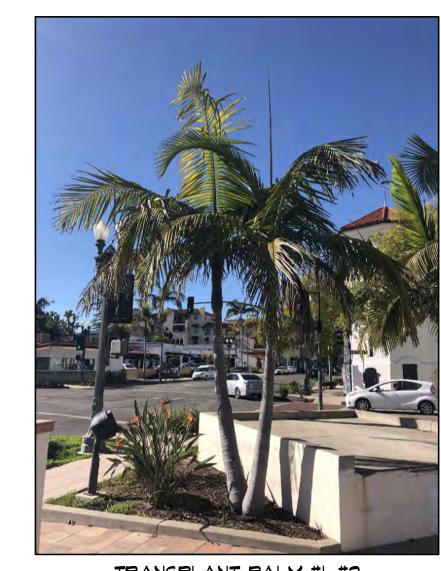

TRANSPLANT PALM #1, #2




TRANSPLANT PALM #3, #4




TRANSPLANT PALM #5

NOTE

PALMS TO BE TRANSPLANTED AT L.A.'S DISCRETION.

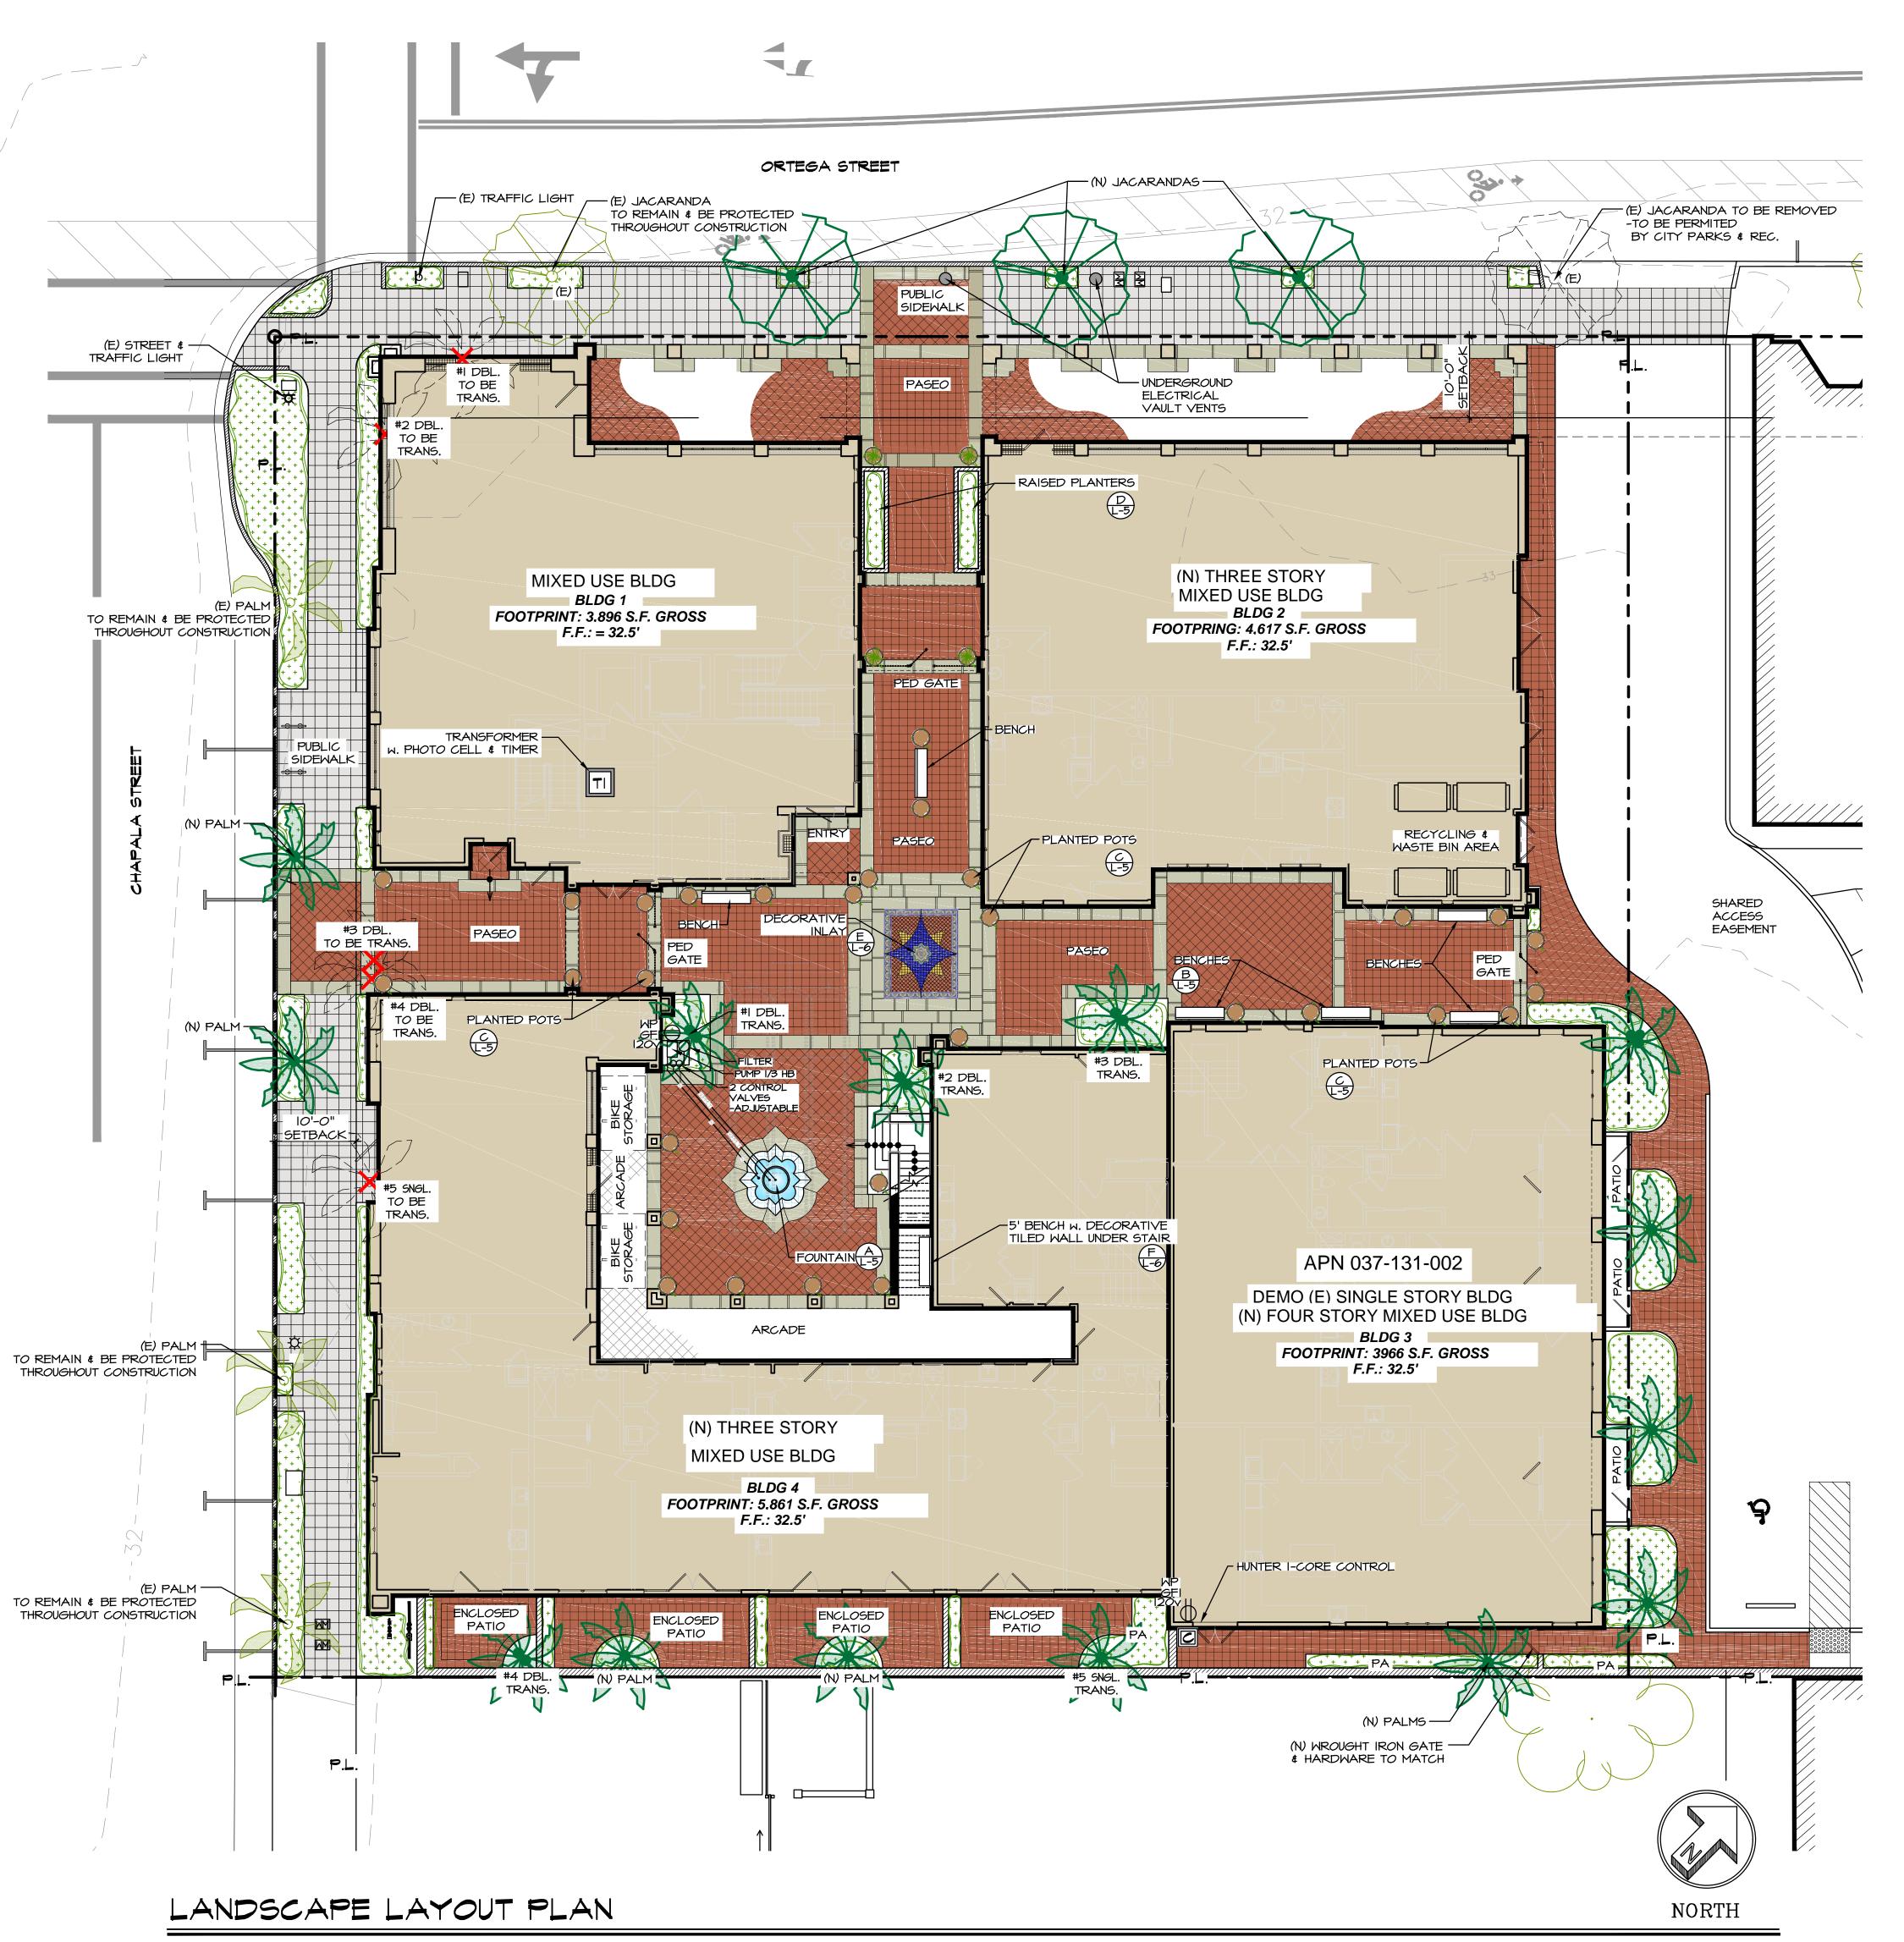

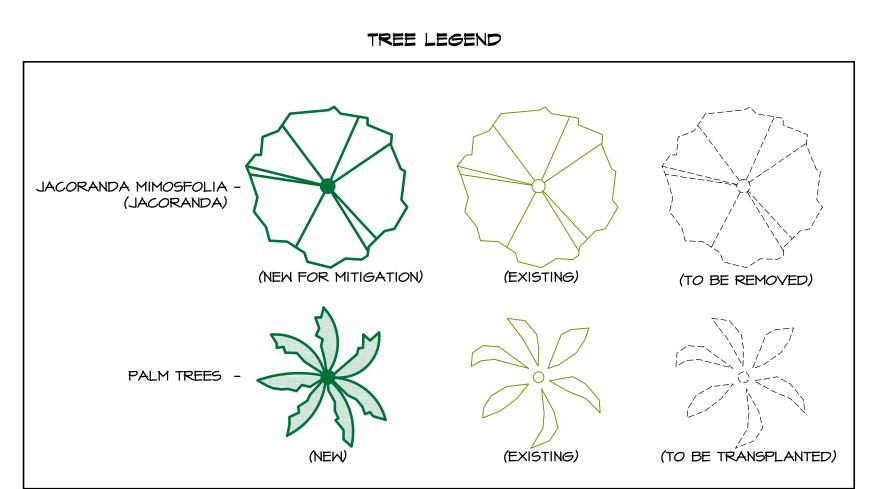



<u>BENCHES</u>




	SHEET INDEX
<u>L</u> -I	Site /Layout Plan
L-2	Irrigation Plan
L-2.I	Hydro-zone Plan
L-3	Planting Plan
L-4	Lighting Plan
L-5	Site Details
L-6	Site Details

SCALE: |" = 10'-0"



4/15/24 |"=|0'-0" N.O.T.

CHAPALA

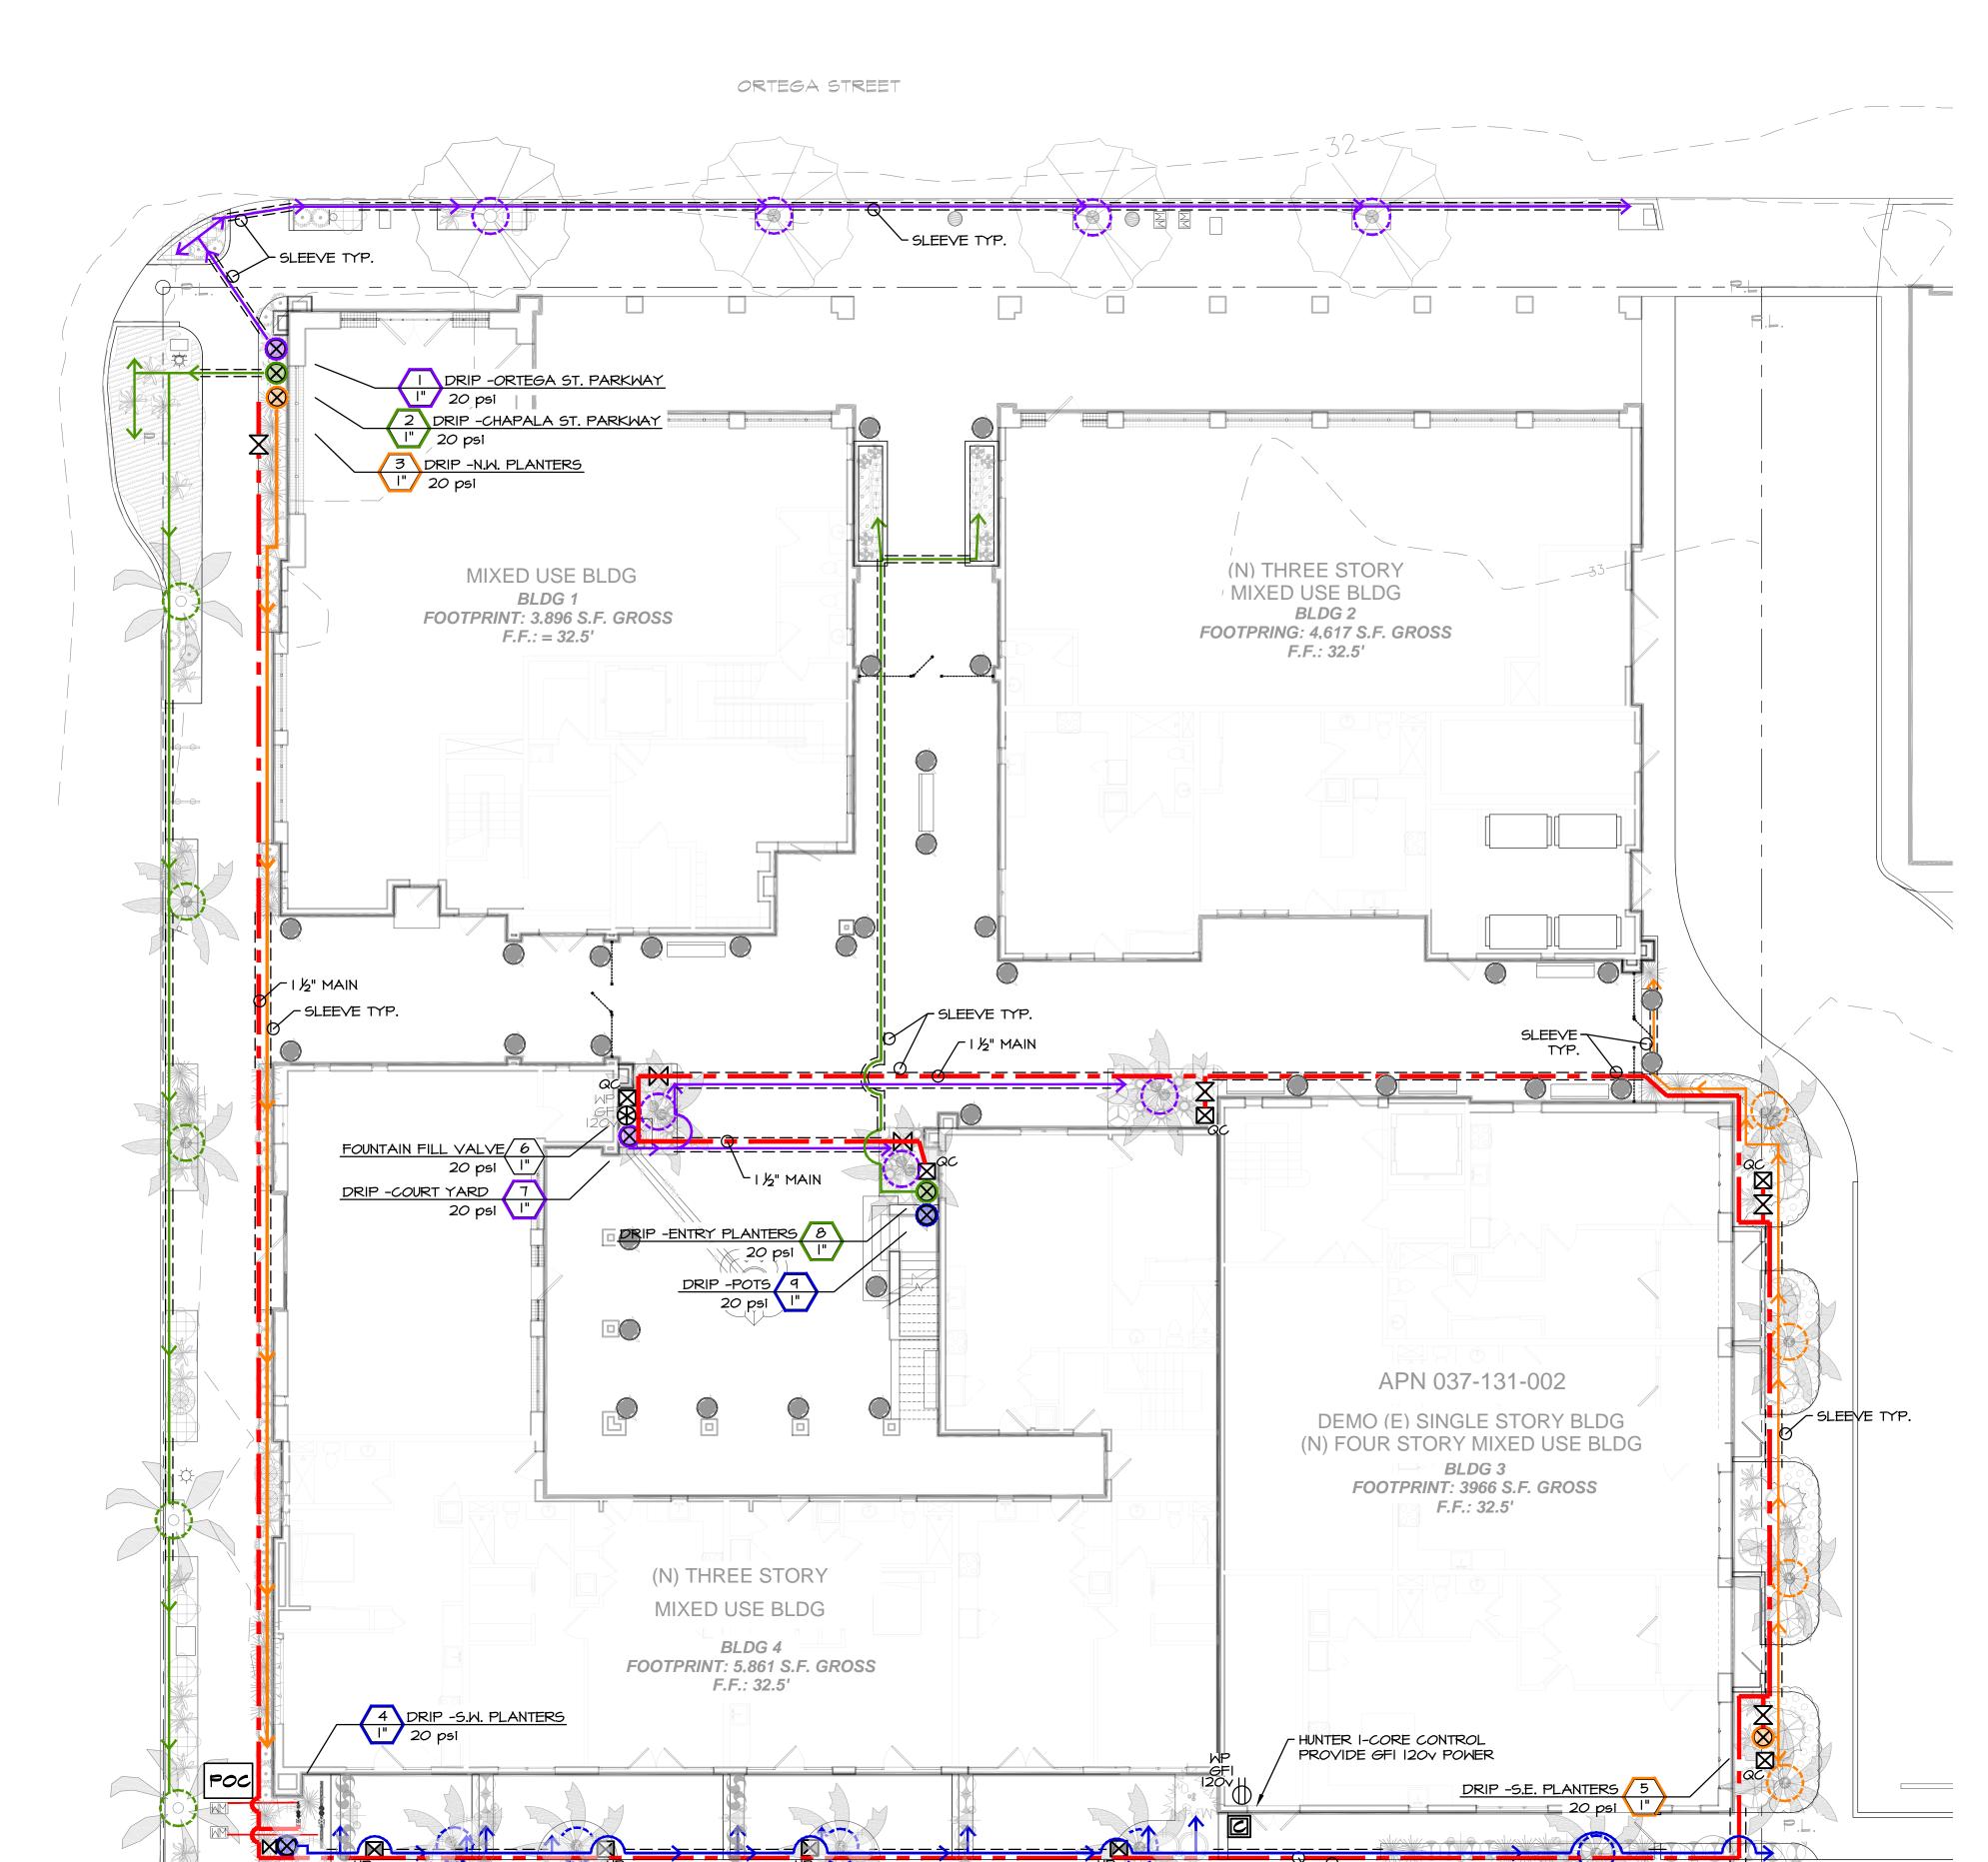

(I) FINISH GRADE/TOP OF MULCH 2) QUICK-COUPLING VALVE: HUNTER QUICK COUPLER -HQ44-LRC HOSE VALVE W LOCKING RUBBER COVER (3) VALVE BOX WITH COVER: 6-INCH SIZE (4) PVC SCH 80 NIPPLE (LENGTH AS REQUIRED) 5) 3-INCH MINIMUM DEPTH OF 3/4-INCH WASHED GRAVEL (6) BRICK (1 OF 2) 7)PVC SCH 40 STREET ELL 8) PVC SCH 40 TEE OR ELL 1) PVC MAINLINE PIPE PVC SCH 40 ELL II) 2" \times 2" REDWOOD STAKE W STAINLESS STEEL GEAR CLAMPS OR EQUIVALENT I. FURNISH FITTINGS AND PIPING NOMINALLY SIZED IDENTICAL TO NOMINAL QUICK COUPLING VALVE INLET SIZE.

- (6) 2 GPH EMITTERS FOR EACH 24" BOX (4) 2 GPH EMITTERS FOR EACH 15q. PLANT 1/2"- 5/8" DRIP POLY TUBING RUN ON GROUND -(2) 2 GPH EMITTERS FOR EACH 5q. PLANT TO ALL GROUND COVER & PLANTS. STAPLE (1) 2 GPH EMITTER FOR EACH IQ. PLANT ANCHOR TO GROUND AS NECESSARY - 3/4' SCH 40 PVC PIPE PVC "T" WITH DRIP--FLEX RISER OR SWING ARM ASSEMBLY. COMPRESSION FITTINGS LOCATE AS INDICATED ON PLANS. UNDISTURBED COMPACTED SOIL-IN TRENCH MAX 30' RISER SPACING

(2) 3/4" HOSE BIB (5) CONC. 6" MIN.

QUICK-COUPLING VALVE

SCALE: I" = 10'-0"

INTERIOR OR _ EXTERIOR WALL MINIMUM CLEARANCE FOR DOOR OPENING MINIMUM VERTICAL (2) CLEARANCE NEEDED FOR HINGE PIN REMOVAL (3) MODEL IC-XX00-PL CONTROL WIRE IN ELECTRICAL (4) CONDUIT. SIZE AND TYPE PER LOCAL CODE 1/2" POWER SUPPLY CONDUIT (5) J-BOX INSIDE CONTROLLER CONNECT PER LOCAL CODE SPECIFY 6, 12, 18, 24, 30, STATION MODEL CONTROLLER. MOUNT CONTROLLER WITH LCD SCREEN AT EYE LEVEL. CONTROLLER SHALL BE HARD-WIRED TO GROUNDED 110 or 220 VAC SOURCE.

D | HUNTER I-CORE 12 STATION CONTROLLER

IRRIGATION PLAN

POINT OF CONNECTION BLOW-UP DETAIL PRESSURE REGULATOR -(WILKINS 600) REDUCE PRESSURE BACKFLOW-PREVENTER (FEBCO 825Y) TIE INTO EXISTING MAIN W/-LINE SIZE GATE VALVE FLOW SENSOR ----MASTER GATE VALVE _____ & FLOW METER (NIBCO-T-113) FLOW METER- (HUNTER HC FLOW METER) INSTALLED PER MANUFACTURE'S INSTRUCTIONS.

SLEEVE TYP.

DRIP RISER DETAIL

() FINISH GRADE (8) LATERAL PIPE 2 STANDARD VALVE BOX WITH COVER: (9) PVC SCH 40 FEMALE ADAPTOR OR RAIN BIRD VB-STD REDUCER 3 WATERPROOF CONNECTION: (10) REMOTE CONTROL VALVE: RAIN BIRD DB SERIES RAIN BIRD LFY-100 (INCLUDED IN (4) VALVE ID TAG XCZ-LF-100-PRF KIT) 5 30-INCH LINEAR LENGTH OF WIRE, COILED (||) PVC SCH 40 TEE OR ELL TO MANIFOLD (12) 3-INCH MINIMUM DEPTH OF 3/4-INCH (6) I" \times $\frac{3}{4}$ " REDUCING COUPLING WASHED GRAVEL (INCLUDED IN XCZ-LF-IOO-PRF KIT) (13) MANIFOLD PIPE AND FITTINGS 7) PRESSURE REGULATING FILTER: RAIN BIRD PRF-100-RBY (INCLUDED IN XCZ-LF-100-PRF KIT) A DRIP CONTROL ZONE KIT

(I) FINISH GRADE/TOP OF MULCH (3) PRESSURE TREAETED 4X4 POST (4) 3/4" BRASS NIPPLE (LENGTH AS REQUIRED) (6) 3/4" HOSE CLAMP (7) PVC SCH 40 STREET ELL (8) PVC SCH 40 TEE OR ELL (9) PVC MAINLINE PIPE (10) PVC SCH 40 ELL HOSE BIB

E LANDSCAPE COMPLIANCE CHECKLIST

<u>IRRIGATION LEGEND</u>

POINT OF CONNECTION

SCHED. 40 PVC LATERAL

TREE DRIP RING

AND ADJUSTMENTS MADE IN THE FIELD

BEFORE PROCEEDING WITH WORK.

SYSTEM PERFORMANCE.

ONE VALVE PER BOX.

PERFORMANCE.

IN LINE CHECK VALVE

IRRIGATION NOTES:

CLASS 200 PVC SLEEVING

MASTER GATE VALVE (NIBCO 7-113)

PRESSURE REGULATOR (WILKINS 600)

SOLAR SYNC AND PLASTIC OUTDOOR COVER.

IRRIGATION MAIN (SCHEDULE 40 PVC PRESSURE LINE)

CONTRACTOR TO BE RESPONSIBLE FOR COORDINATION WITH OWNER ON

CONTRACTOR TO BE RESPONSIBLE FOR FULL IRRIGATION COVERAGE OF ALL PLANTED AREAS. (LAWN, TREES, SHRUBS, AND GROUND COVER.)

IRRIGATION PLAN TO BE COORDINATED WITH PLANTING PLAN.

LOCATION OF EXISTING UNDERGROUND UTILITY AND IRRIGATION LOCATIONS.

IN CASE OF DISCREPANCY, CONTACT LANDSCAPE ARCHITECT IMMEDIATELY,

PRESSURE AT MAIN WATER SUPPLY TO BE VERIFIED BEFORE PROCEEDING. PRESSURE TEST NEW IRRIGATION MAIN FOR 24 HOURS BEFORE BACK FILL COVERING. A PRESSURE REGULATOR MAY BE NECESSARY FOR OPTIMUM

ALL IRRIGATION LINES ARE DRAWN DIAGRAMMATICALLY AND SHOULD BE LOCATED IN COMMON TRENCHES AND PLANTING AREAS WHERE POSSIBLE.

USE GREEN OR BLACK PLASTIC (AMTEK, CARSON OR EQUAL) VALUE BOXES.

PRESSURE REGULATING DEVICES SHALL BE INSTALLED WHERE NECESSARY

TO ENSURE THAT THE DYNAMIC PRESSURE AT EACH EMISSION DEVICE IS

WITHIN MANUFACTURER'S RECOMMENDED PRESSURE RANGE FOR OPTIMAL

ALL IRRIGATION EMISSION DEVICES WILL MEET THE CRITERIA AS SET

12. ALL IRRIGATION UNDER SLAB / WALK WAYS TO BE WELDED PLASTIC

OPERATED ACCORDING TO MANUFACTURER'S

INSTRUCTIONS/RECOMMENDATIONS.

GPM

12-22

22-30

*30-4*5

45 \$ UP

FORTH IN -MWELO SECTION 492.7(a)(I)(M) AND SHALL BE INSTALLED AND

LATERAL SCHEDULE (SIZE CHART)

PVC CLASS 40 PIPE SIZE

3/4"

I-I/2" 2"

2-1/2"

SLEEVE UNDER PAVING (CLASS 200 PVC MIN.)- 24" UNDER PAVING

8. INSTALL ALL IRRIGATION EQUIP AS PER MANUFACTURER'S INSTRUCTIONS.

HUNTER FLOW-SYNC -FLOW SENSOR

W/ CONTROL ZONE KIT XCZ-100 FOUNTAIN AND SPA FILL VALVE

REDUCE PRESSURE BACKFLOW PREVENTER (FEBCO 825Y)

DRIP ASSEMBLY (RAINBIRD 75 DIX ELECTRIC REMOTE CONTROL VALVE

HUNTER QUICK COUPLER -HQ44-LRC HOSE VALVE W/ LOCKING RUBBER COVER

HUNTER I-CORE 6-42 STATION MODULAR SMART MODULAR CONTROL W.

HOSE BIB (CHAMPION B401- 3/4"x3/4" WHEEL HANDLE HOSE BIB)

The person who prepared the landscape plan must sign this checklist and include it on the landscape plans. Check each box to verify compliance and add sheet references or indicate N/A if "not applicable". 1) Limit Your Lawn ☐ Commercial projects have no lawn or turf grass areas No turf grass is in parkways, medians, or other areas with any dimension of less than 8 feet ☐ No turf grass is located on slopes of 20% or greater <u> N/A</u> 2) Plant Water-Wise Sheet # ☐ Commercial projects are designed with 100% water-wise plants <u>L-3</u> L-3 Residential, mixed-use, and institutional are designed with minimum 80% water-wise plants Plant list includes botanical name, common name, and WUCOLS designation <u>L-3</u>

☑ Plans show total square feet and percent of water-wise, medium, high-water-using landscaping
☐-2.1 3) Mulch, Mulch, Mulch Sheet # L-3 All appropriate landscaped areas will be covered with at least 3 inches of mulch 4) Irrigate Efficiently Sheet #

A weather-based irrigation controller with a rain shutoff sensor is provided <u>L-2</u> Areas less than 8 feet are irrigated with bubblers, pop-up rotating nozzle, sub-surface, or drip <u>L-2</u> ☐ Sprinklers have matched precipitation rates within each valve and circuit. N/A

☐ Sprinklers have uniform distribution, head-to-head spacing, and setbacks from paved areas. Check valves are provided at the low end of irrigation lines to prevent unwanted draining. Pressure regulators are provided for mainline, if necessary; inline regulators at each valve. 5) Minimize Steep Slopes

Slope allows for water retention, creates swales, mimics natural flow, and maintains flow width. I certify that the foregoing is true and correct and that verification will be necessary upon final inspection.

Sheet #

License # and Exp. Date

The landscape architect and his consultants do not warrant or guarantee the accuracy and completeness of the work product herein beyond a reasonable diligence. If any mistakes, omissions, or discrepancies are found to exist within the work product, the landscape architect shall be promptly notified so that he may have the opportunity to take whatever steps necessary to resolve them. Failure to promptly notify the landscape architect or in contradiction to the landscape architects work product or recommendations shall become the responsibility not of the landscape architects written consent.

4/15/24 N.O.T.

CHAPALA



DRIP ZONE 3 POTS 84 sq.ft. WATER EFFICIENT LANDSCAPE WORKSHEET CHAPALA MIXED USE 630 CHAPALA ST. SANTA BARBARA, CA Prepared according to the California Code of Regulations, Chapter 2.7. Model Water Efficient Landscape Ordinance (rev. 12/1/15) 40.6 Reference evapotranspiration (Eto) for Santa Barbara SECTION A. HYDROZONE INFORMATION TABLE ----MEDIUM USE PLANTING WATER FEATURES TOTALS 13,574 Special Landscape areas (SLA) 0 (C) 0 (D) TOTAL LANDSCAPE AREA TOTAL ETAF 13,574 ETWU TOTAL MAWA TOTAL 26,845 ETWU COMPLIES WITH MAWA MAXIMUM APPLIED WATER ALLOWANCE (MAWA) CALCULATIONS **MAWA** = (Eto) (0.62) [($0.55 \times LA$) + ((1-ETAF) × SLA)] Annual Eto for Santa Barbara is 40.6 Maximum Applied Water Allowance (gallons per year) Reference Evapotranspiration from Appendix A (inches per year) ET Adjustment Factor (ETAF) *revised effective June 1, 2015* FOR RESIDENTIAL AREAS Landscaped Area includes Special Landscape Area (square feet) Conversion factor (to gallons per square foot) Portion of the landscape area identified as Special Landscape Area (square feet) the additional ET Adjustment Factor for Special Landscape Area * revised effective June 1, 2015* AND FOR NON RESIDENTIAL AREAS conv. Factor ETAF 1,939 + 1066 + ETWU = (Eto)(0.62) (ETAF) (AREA)Annual Eto for Santa Barbara is 40.6 Estimated total water use per year (gallons per year) Reference Evapotranspiration (inches per year) Plant Factor from WUCOLS Hydrozone Area [high, medium, and low water use areas] (square feet) Conversion Factor Irrigation Efficiency (minimum 0.71) Special Landscape Area (square feet) **ETAF CALCULATIONS:** Regular Landscape Areas TOTAL ETAF X Area AVERAGE ETAF FOR REGULAR LANDSCAPE AREAS TOTAL Area MUST BE 0.55 OR BELOW FOR RESIDENTIAL AREAS, AND Average ETAF B/A 0.45 OR BELOW FOR NON-RESIDENTIAL AREAS

All Landscape Areas

TOTAL ETAF X Area

TOTAL Area

Sitewide ETAF

(B + D)

(A + C)

(B+D) / (A + C)

SCALE: I" = 10'-0"

HYDRO ZONE LEGEND


DRIP ZONE | LOW USE PLANTING | 1,672 sq.ft.

DRIP ZONE 2 MED USE PLANTING
159 sq.ft.

4/15/24

| "=|0'-0"

N.O.T.

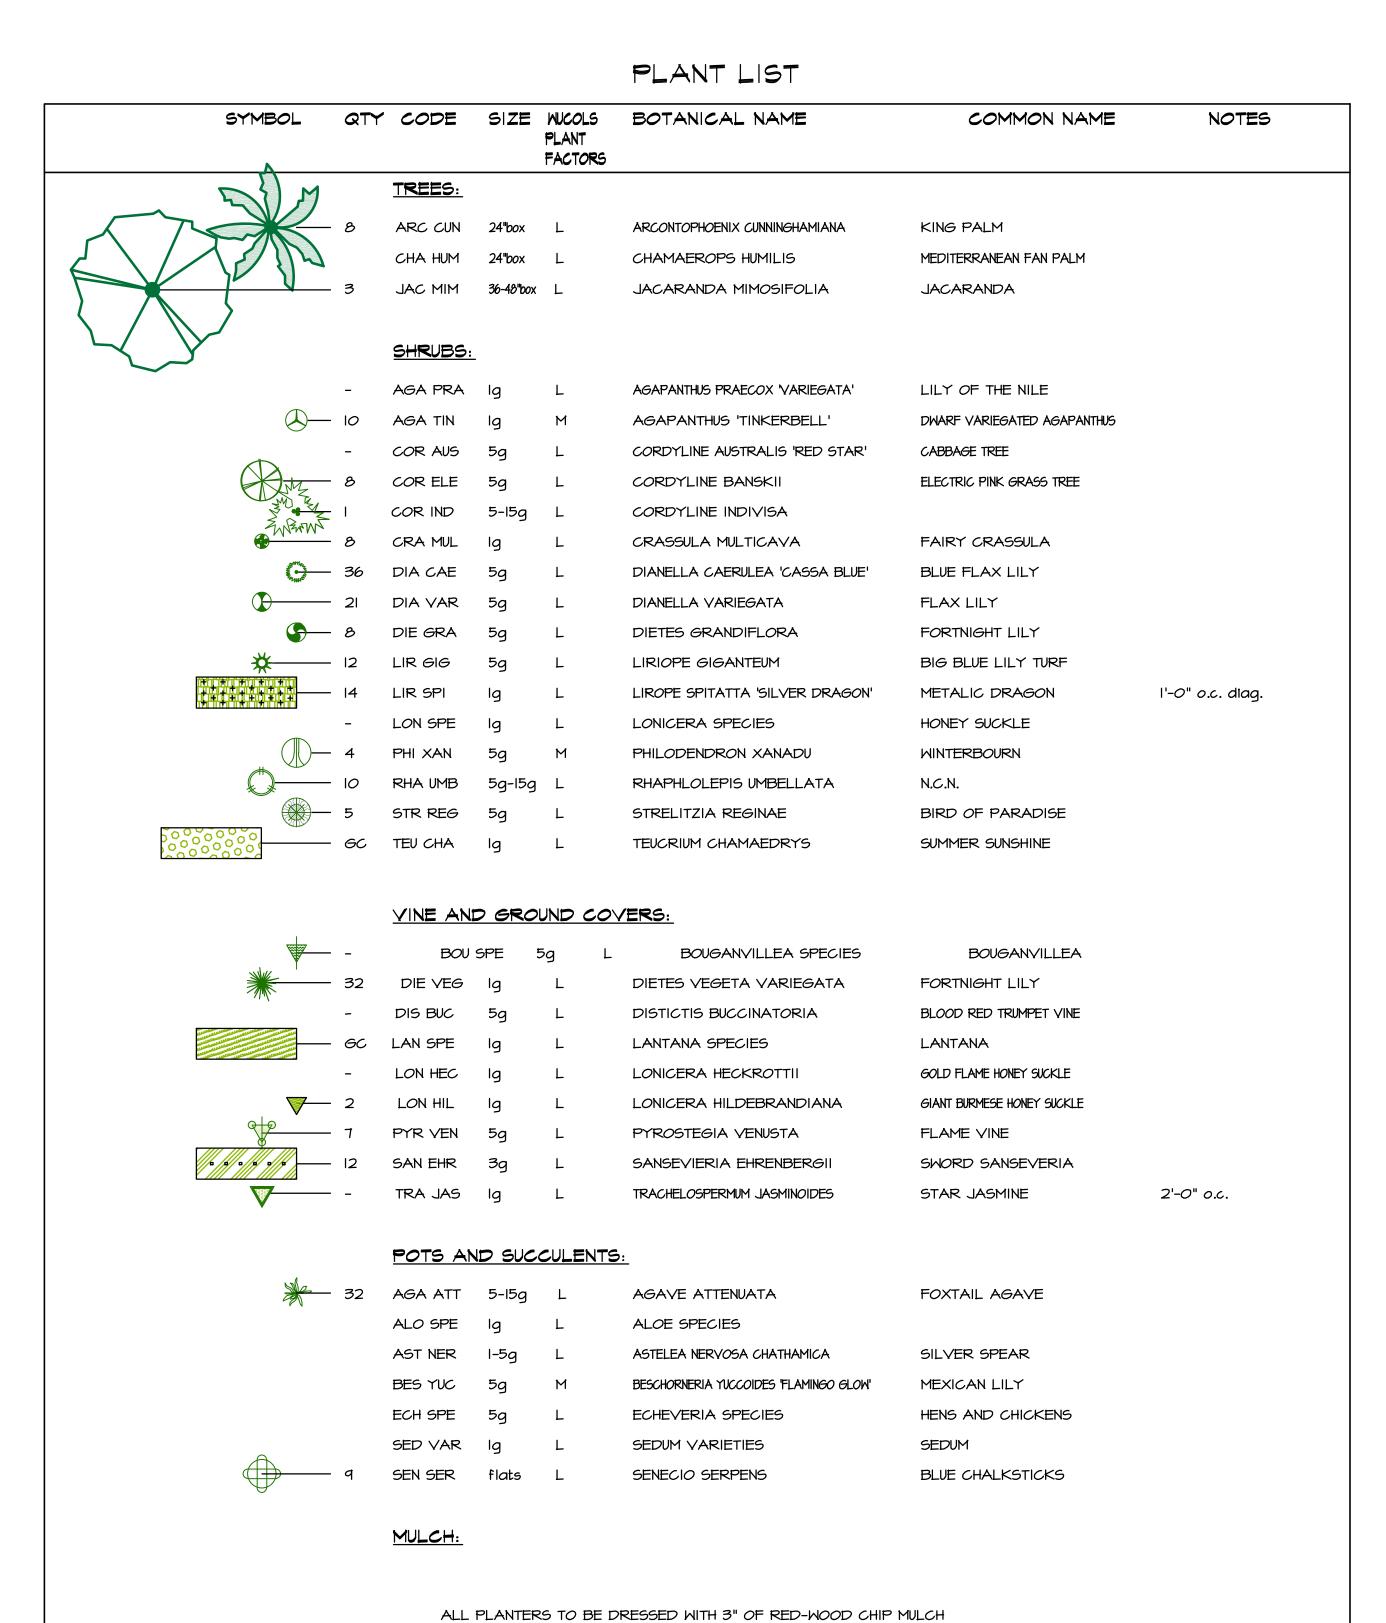


PLANT NOTES

- CONTRACTOR TO BE RESPONSIBLE FOR COORDINATION WITH OWNER FOR LOCATION OF UNDERGROUND UTILITIES.
- 2. PLANT LIST IS FOR CONVENIENCE OF CONTRACTOR. PLAN IS TO PREVAIL AND LANDSCAPE ARCHITECT AND OWNER TO MAKE FINAL ADJUSTMENTS AS NECESSARY.
- 3. CONTRACTOR TO BE RESPONSIBLE FOR FULL IRRIGATION COVERAGE OF ALL PLANTED AREA.

4. IRRIGATION TO BE COORDINATED WITH PLANTING PLAN.


- 5. ALL PLANTER AREAS SHALL BE AMENDED WITH 4 CU. YDS. OF FOREST HUMUS MULCH AND 150 LBS. OF GRO-POWER PLUS, PER 1,000 SQ. FT. OF PLANTED AREA. PLANTER MIX TO BE 50% NATIVE AND 50% PLANTER MIX ABOVE FOR ALL BACK FILL OF NEW PLANTS. ADD NATIVE AND SANDY MIX SOIL FOR POTS AND RAISED PLANTERS.
- 6. PLANT MATERIAL MAY BE SUBJECT TO CHANGE AS PER OWNER OR LANDSCAPE ARCHITECTS DISCRETION.
- 7. ANY CLARIFICATION OR QUESTIONS ON PLANS, SPECIFICATIONS AND DETAILS SHOULD BE BROUGHT TO THE ATTENTION OF THE LANDSCAPE ARCHITECT IMMEDIATELY BEFORE PROCEEDING WITH WORK.
- 8. ALL PLANTER AREAS TO BE TOP DRESSED WITH SHREDDED CEDAR/ REDWOOD MULCH AT A MINIMUM DEPTH OF 3".
- 9. ALL TREES SHALL BE PLANTED WITH DEEP ROOT BARRIERS (TYP.). IF WITHIN 6FT. OF WALL, WALK, PATIO, PARKING CURB ETC.

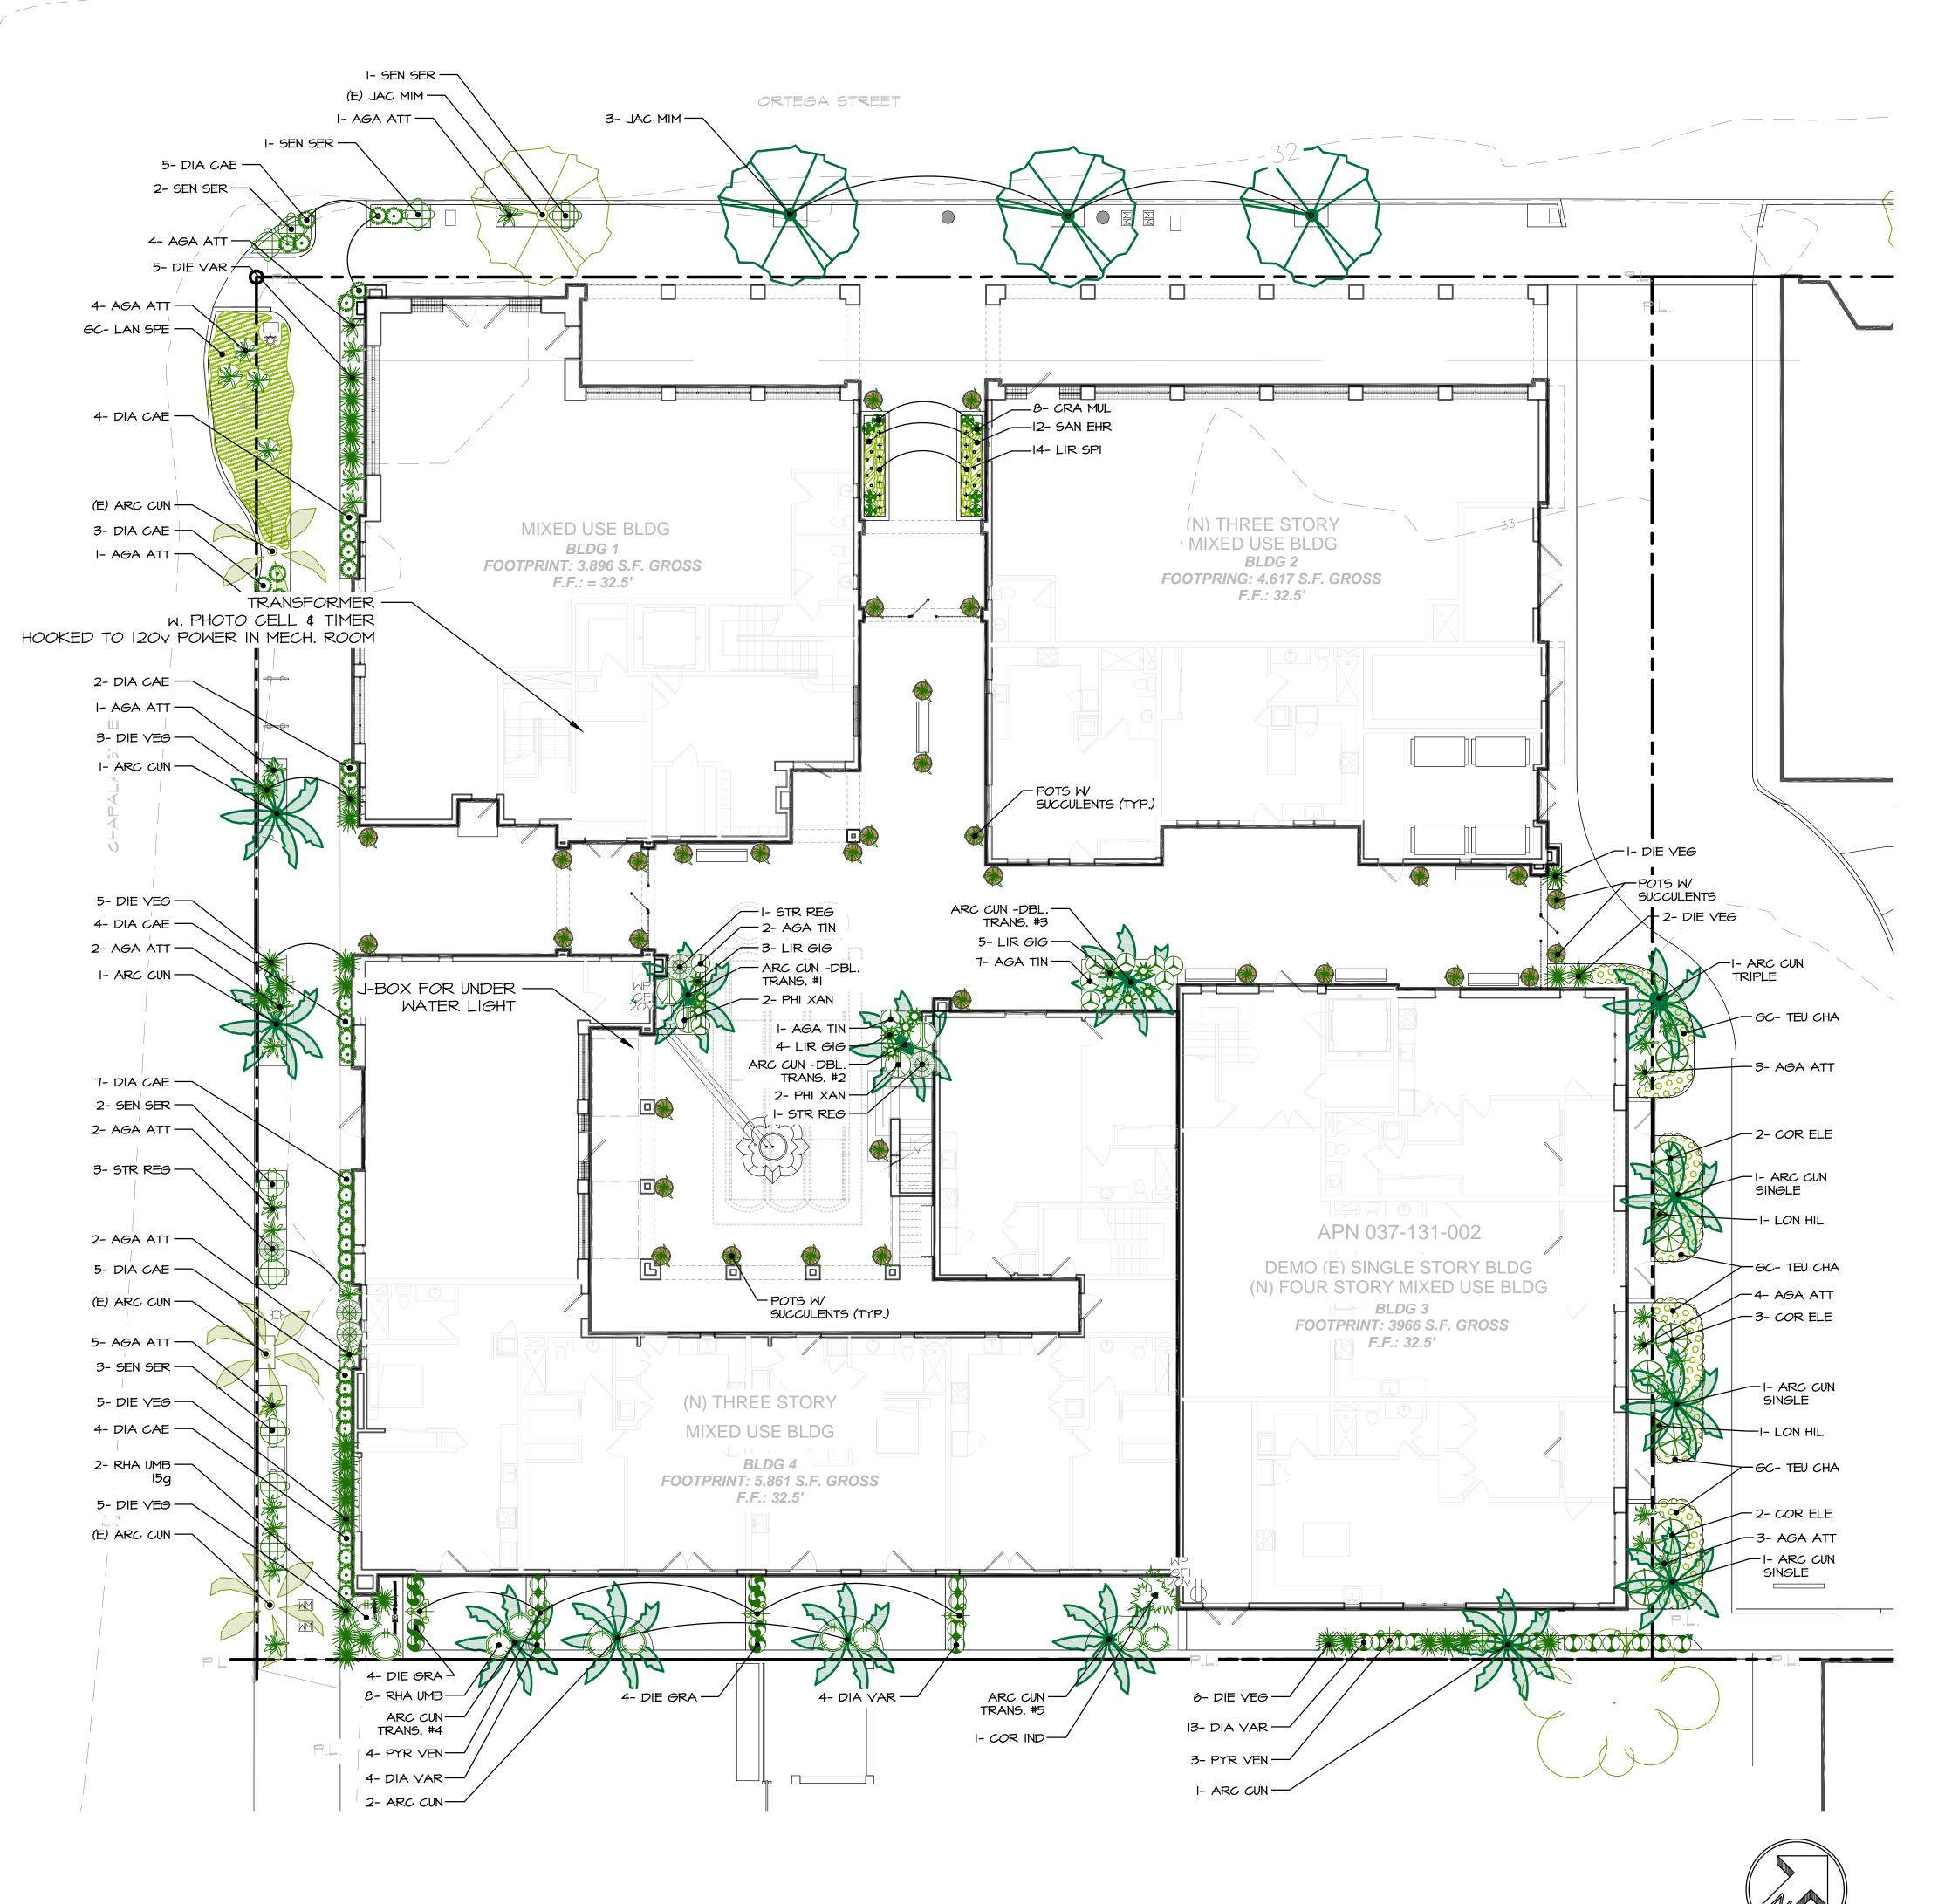

PLANTING PLAN

SCALE: |" = 10'-0"

N.O.T.

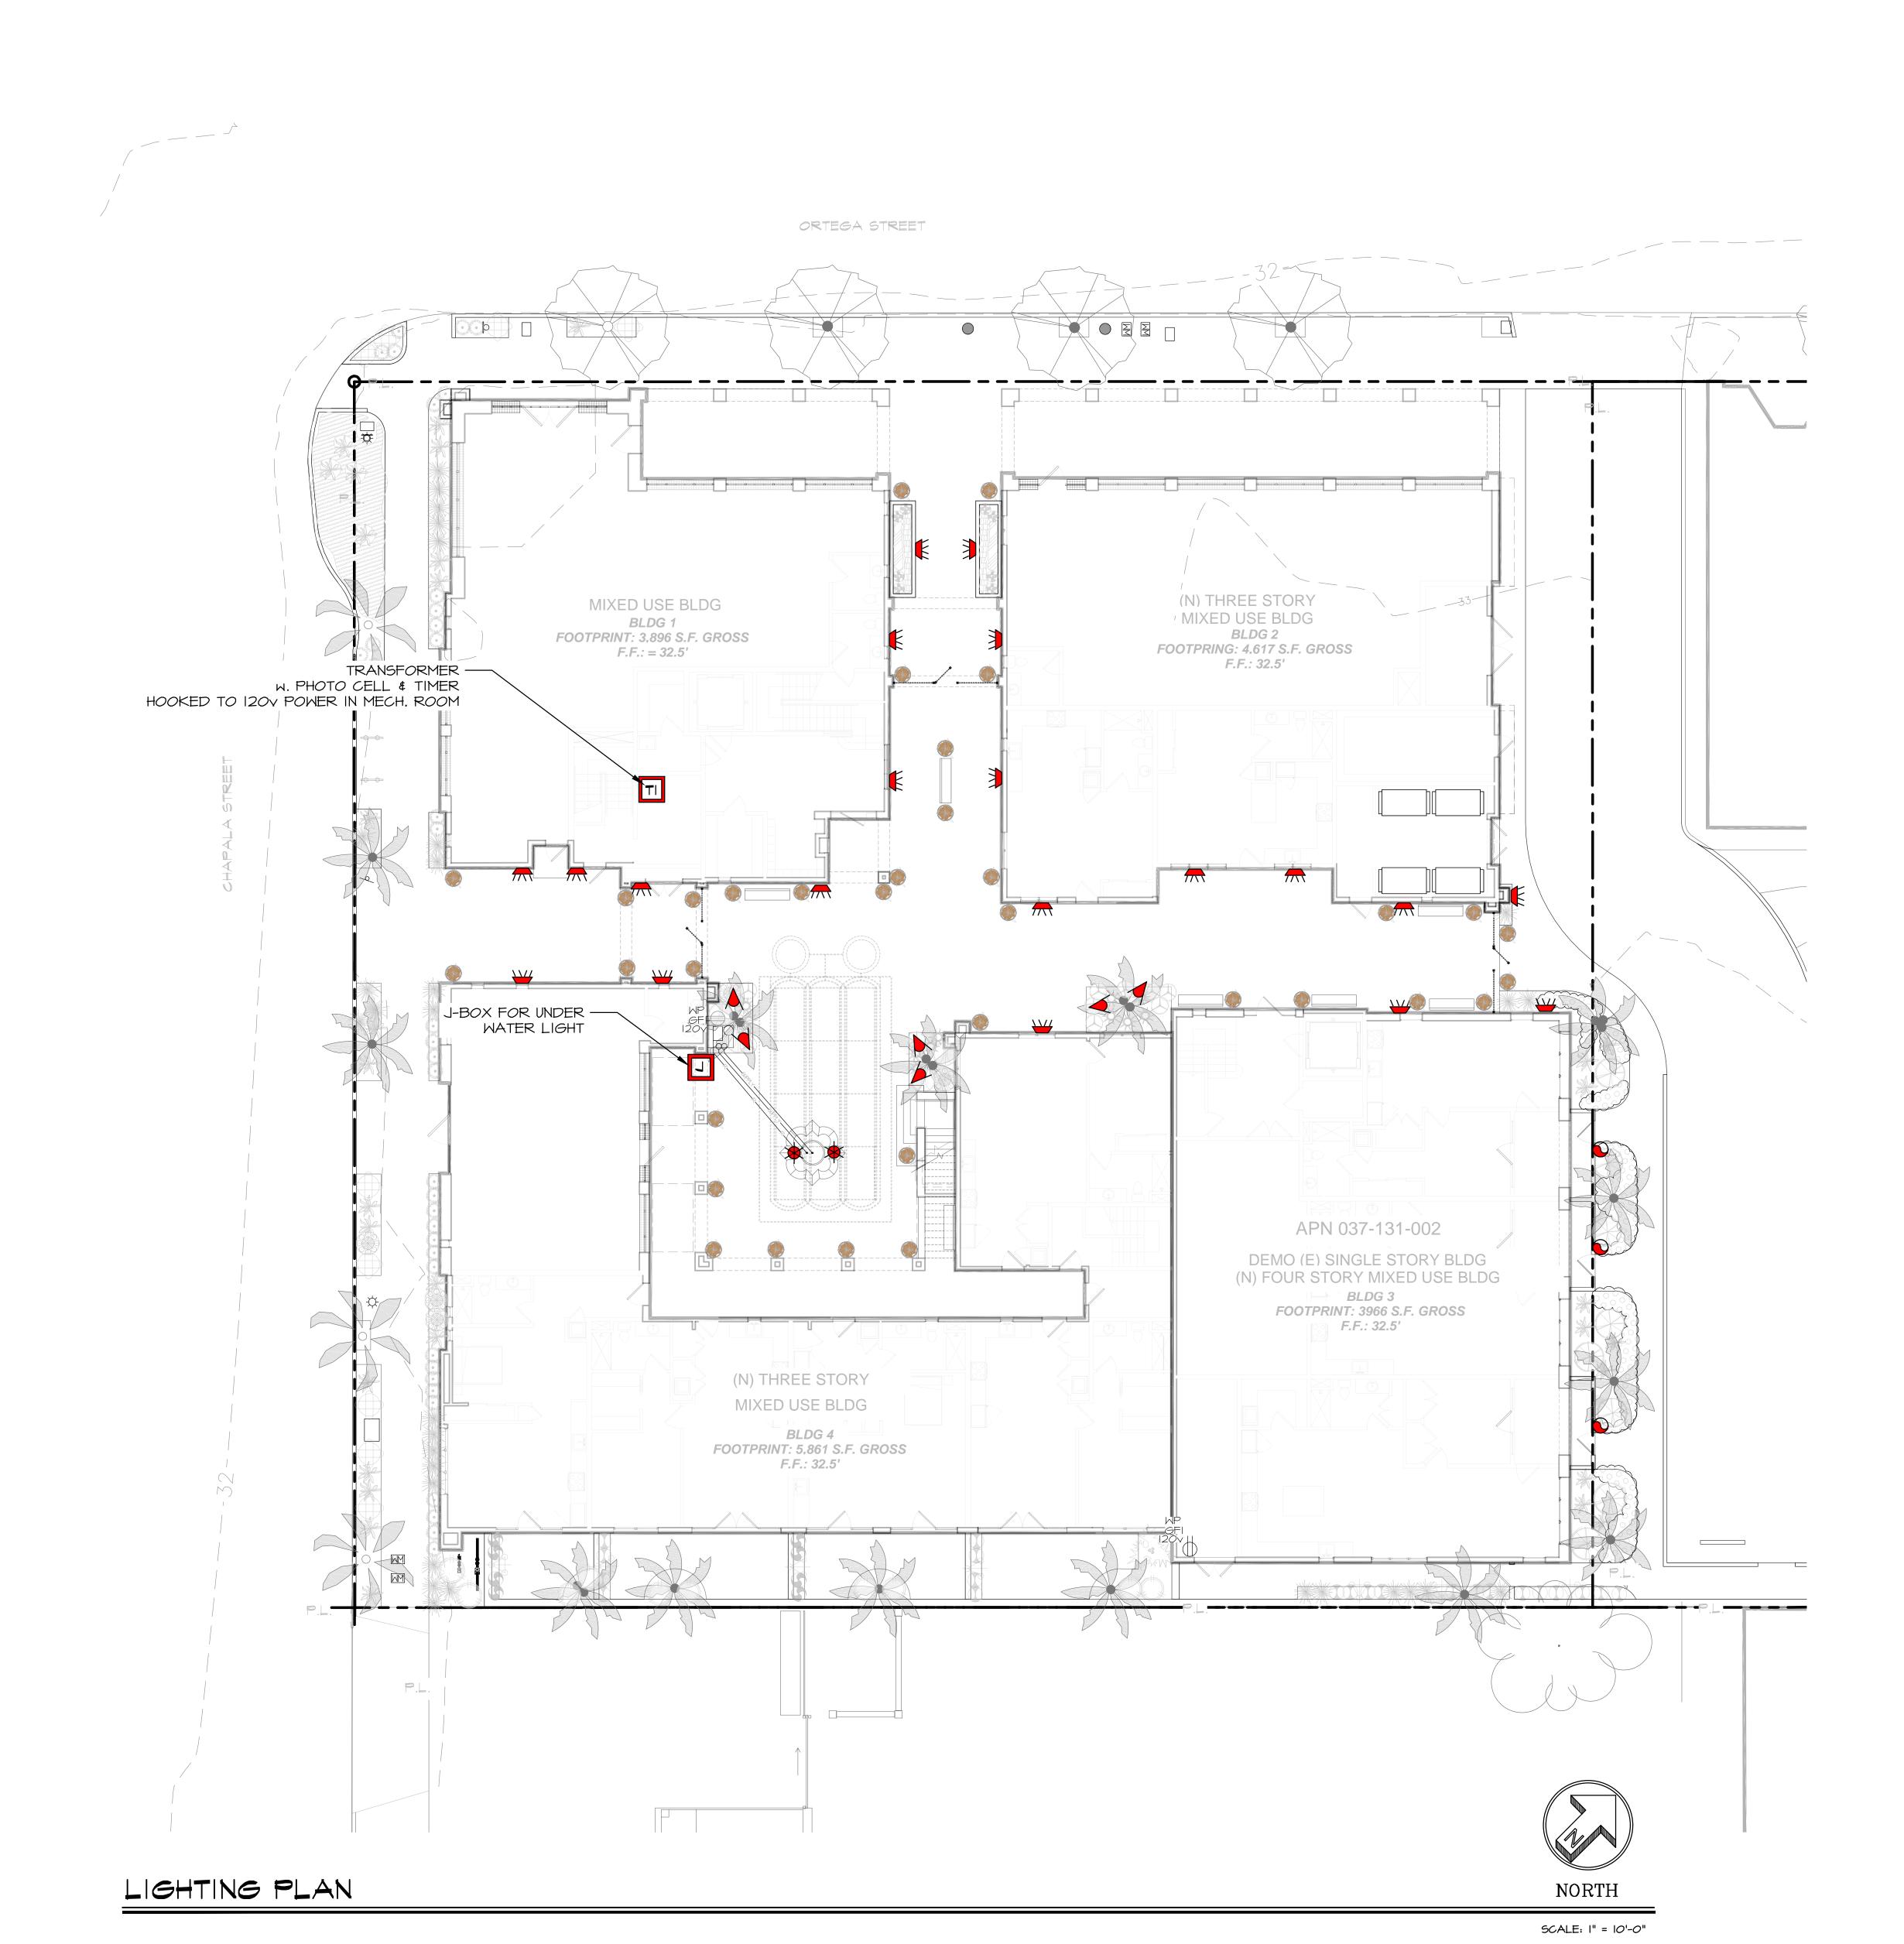


<u>LIGHTING LEGEND</u>

SYMB <i>O</i> L	QTY.	DESCRIPTION
T#	I	NEW TRANSFORMER -FX-PX-600W TRANSFORMER W. PHOTO CELL & TIMER -COLOR TO MATCH
	1	J-BOX -FOR UNDERWATER LIGHT MOUNTED 12" ABOVE WATER LINE OF FOUNTAIN
→ MP GFI	1	120V GFI, WATERPROOF OUTLET
\$	-	LANDSCAPE LIGHT SWITCHES TO BE TIED INTO BUILDING SYSTEM
(A) (6	FX-LUMINAIRE MODEL # NP-3LED-BZ; (4W -3 LED); BRONZE ACCENT LIGHT
(B) W	20	WAC LIGHTING MODEL # WL-LEDIOO-C-BZ; (3.9w -LED); BRONZE LOW WALL LIGHT @ 2'± HT.
(C) *	2	VISTA MODEL # UW-2117-BSO-BAB; (5W -LED); BRONZE -MOUNTED TO BOTTOM OF FOUNTAIN
(D) Q	3	HANDLEMAN STUDIOS MODEL 'BOZEMAN' SMALL OUTDOOR FLUSH MOUNT #S-ZOL-105640.8; (5w -LED); BLACK RUST w. FROSTED CLEAR ACRYLIC
\		SWITCH CONDUIT
=====		ALL WORK UNDER PAVING TO SLEEVED.

LIGHTING INSTALLATION NOTES

- I.) SEE ELECTRICAL ENGINEERING PLANS FOR ALL POWER LINES, CONTROLS, AND CONDUIT FOR THESE EXTERIOR LIGHT FIXTURES.
- 2.) ALL SYSTEMS SHALL HAVE SWITCH OVERRIDE CAPABILITY.
- 3.) LOCATE ALL LOW VOLTAGE WIRES IN CONDUIT. BURY A MIN. OF 3".
- 4.) WELL OR ACCENT LIGHTS TO BE DETERMINED IN FIELD BY LANDSCAPE ARCHITECT BASED ON QUALITY OF LIGHT IN TREE CANOPY.
- 5.) ALL CABLE IS TO BE APPROPRIATELY SIZED PER LENGTH OF RUN & LOAD BY ELECTRICIAN.
- 6.) COORDINATE SWITCHING W. ARCHITECTURAL PLANS & BUILDING COUNTOL SYSTEM.
- 7.) TUN ALL CABLE IN CONDUIT BACK TO TRANSFORMER IN BLDG. #I MECH. ROOM.

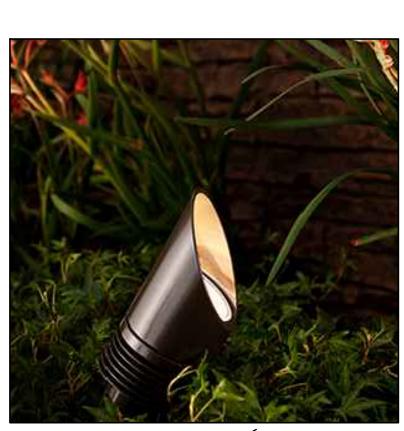

FX-LUMINAIRE MODEL # NP-3LED-BZ; ACCENT LIGHT



(B) ||| WAC LIGHTING MODEL # WL-LEDIOO-C-BZ; LOW WALL LIGHT @ 2'± HT



VISTA MODEL # UW-2117-BSO-BAB; SUBMERSIBLE LI*G*HT



(**D**) HANDLEMAN STUDIOS 'BOZEMAN' SMALL OUTDOOR FLUSH MOUNT LIGHT


PUMP IN PLANTER (TO BE TIED INTO TIMER W/ SWITCH

SCALE: 1/2"=1'-0"

OVER RIDE) SEE PLAN FOR PUMP LOCATION


N.T.S.

4/15/24

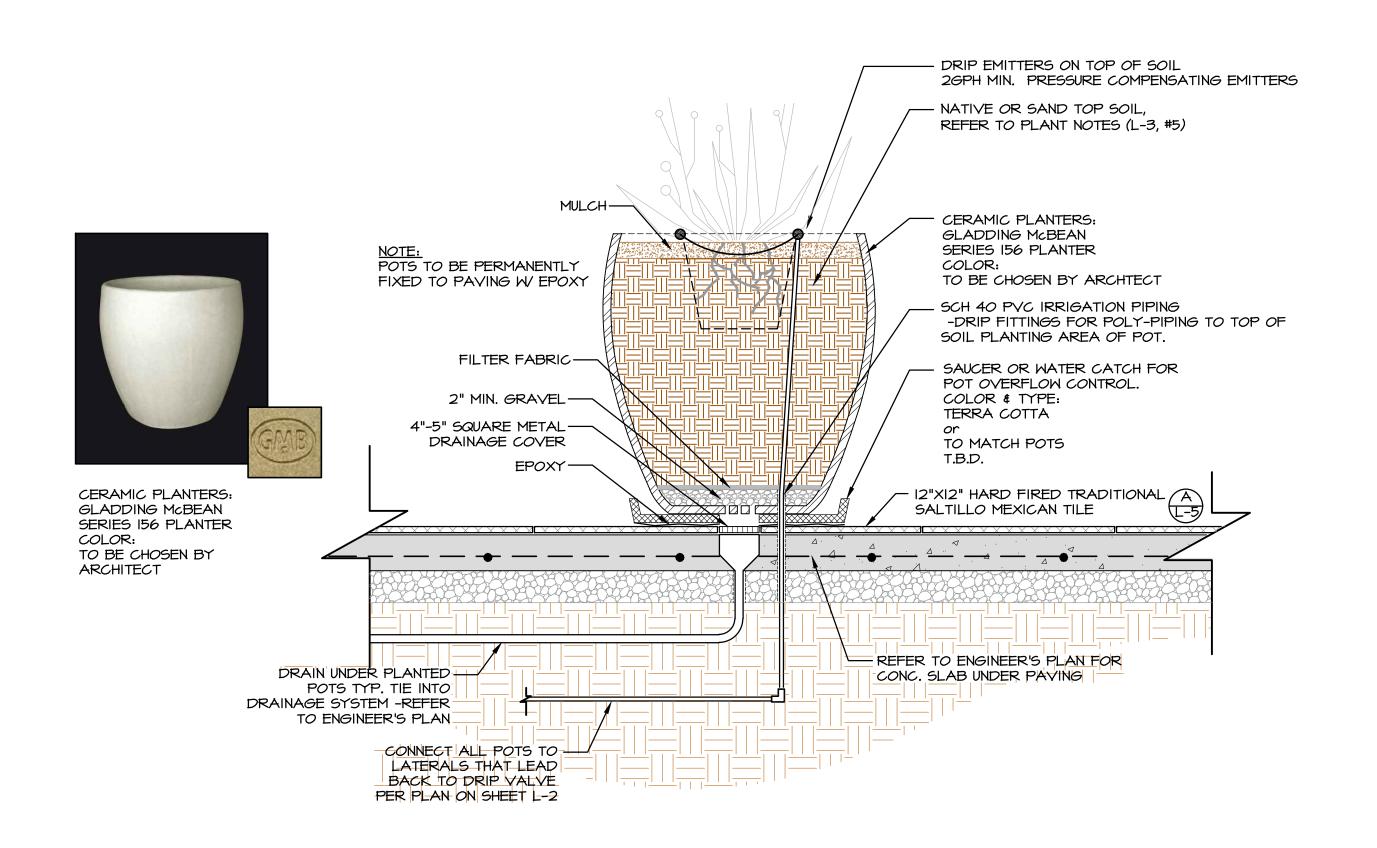


PLANTED POTS W. IRRIGATION

SCALE: |" =1'-0"

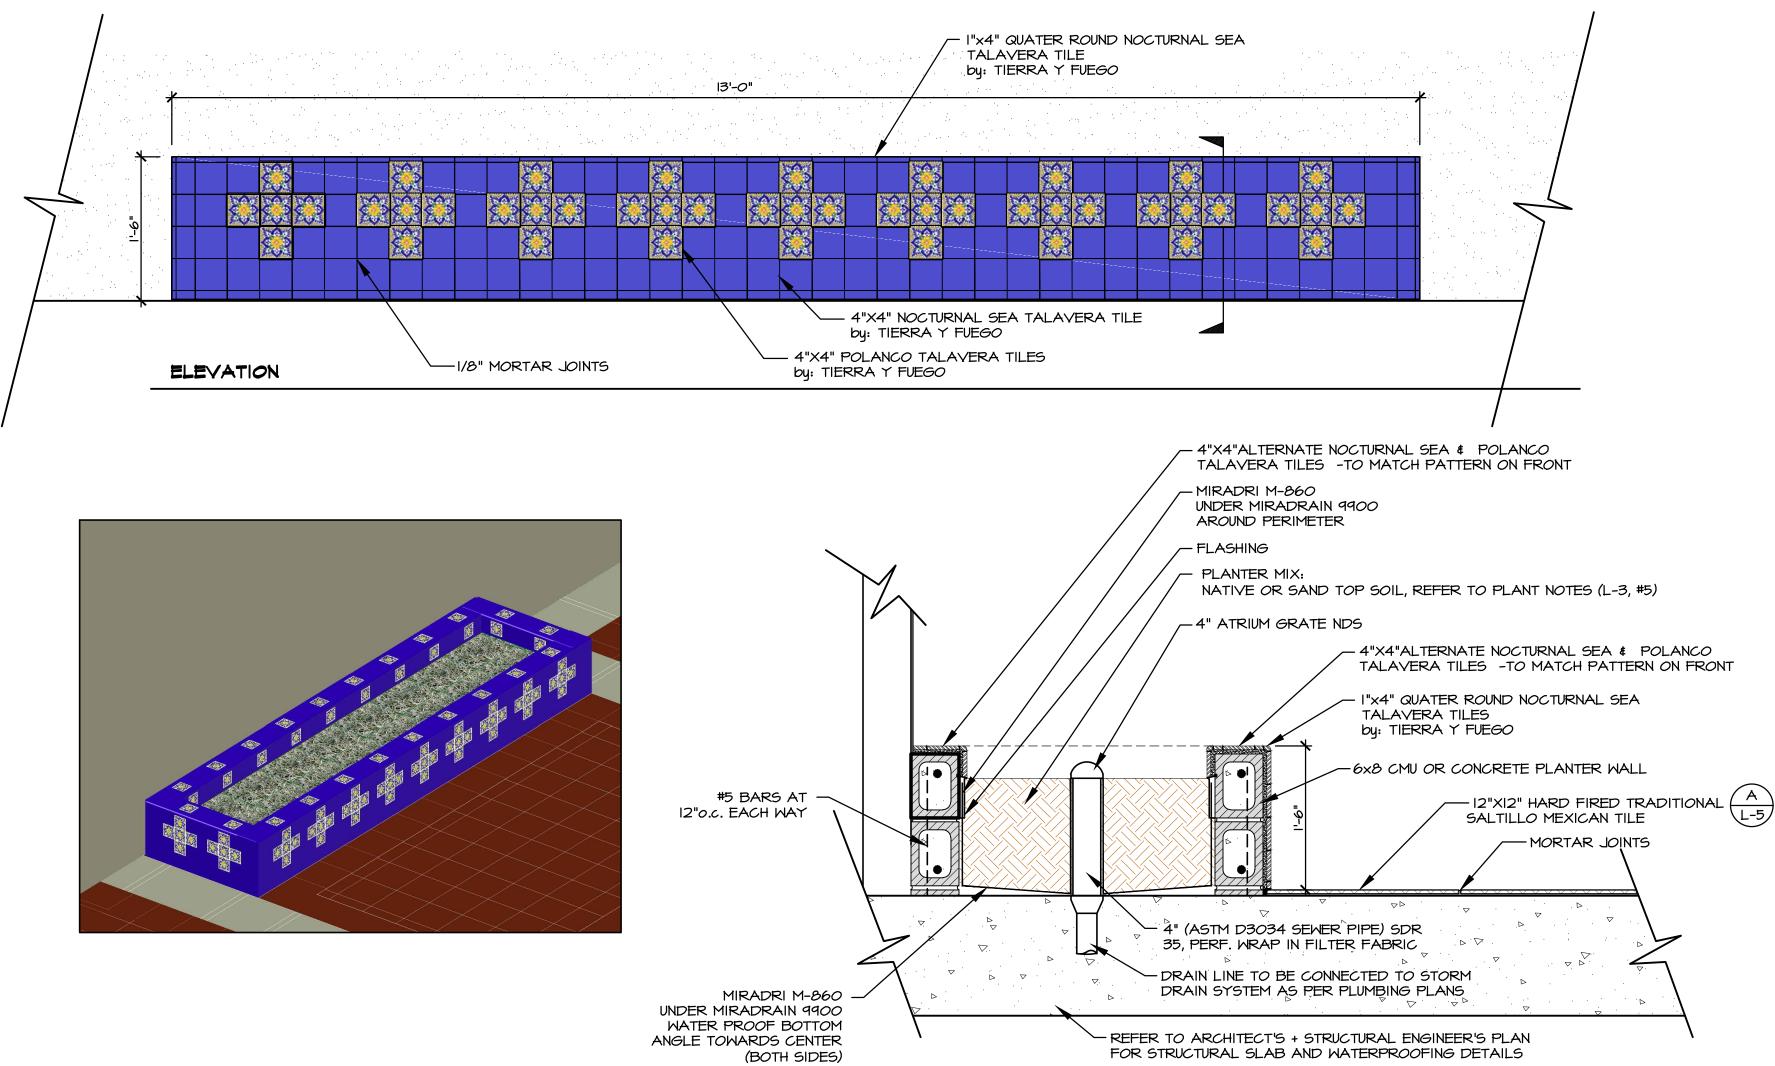


RAISED PLANTER WITH TILE WALLS

SCALE: |"=|'-0"

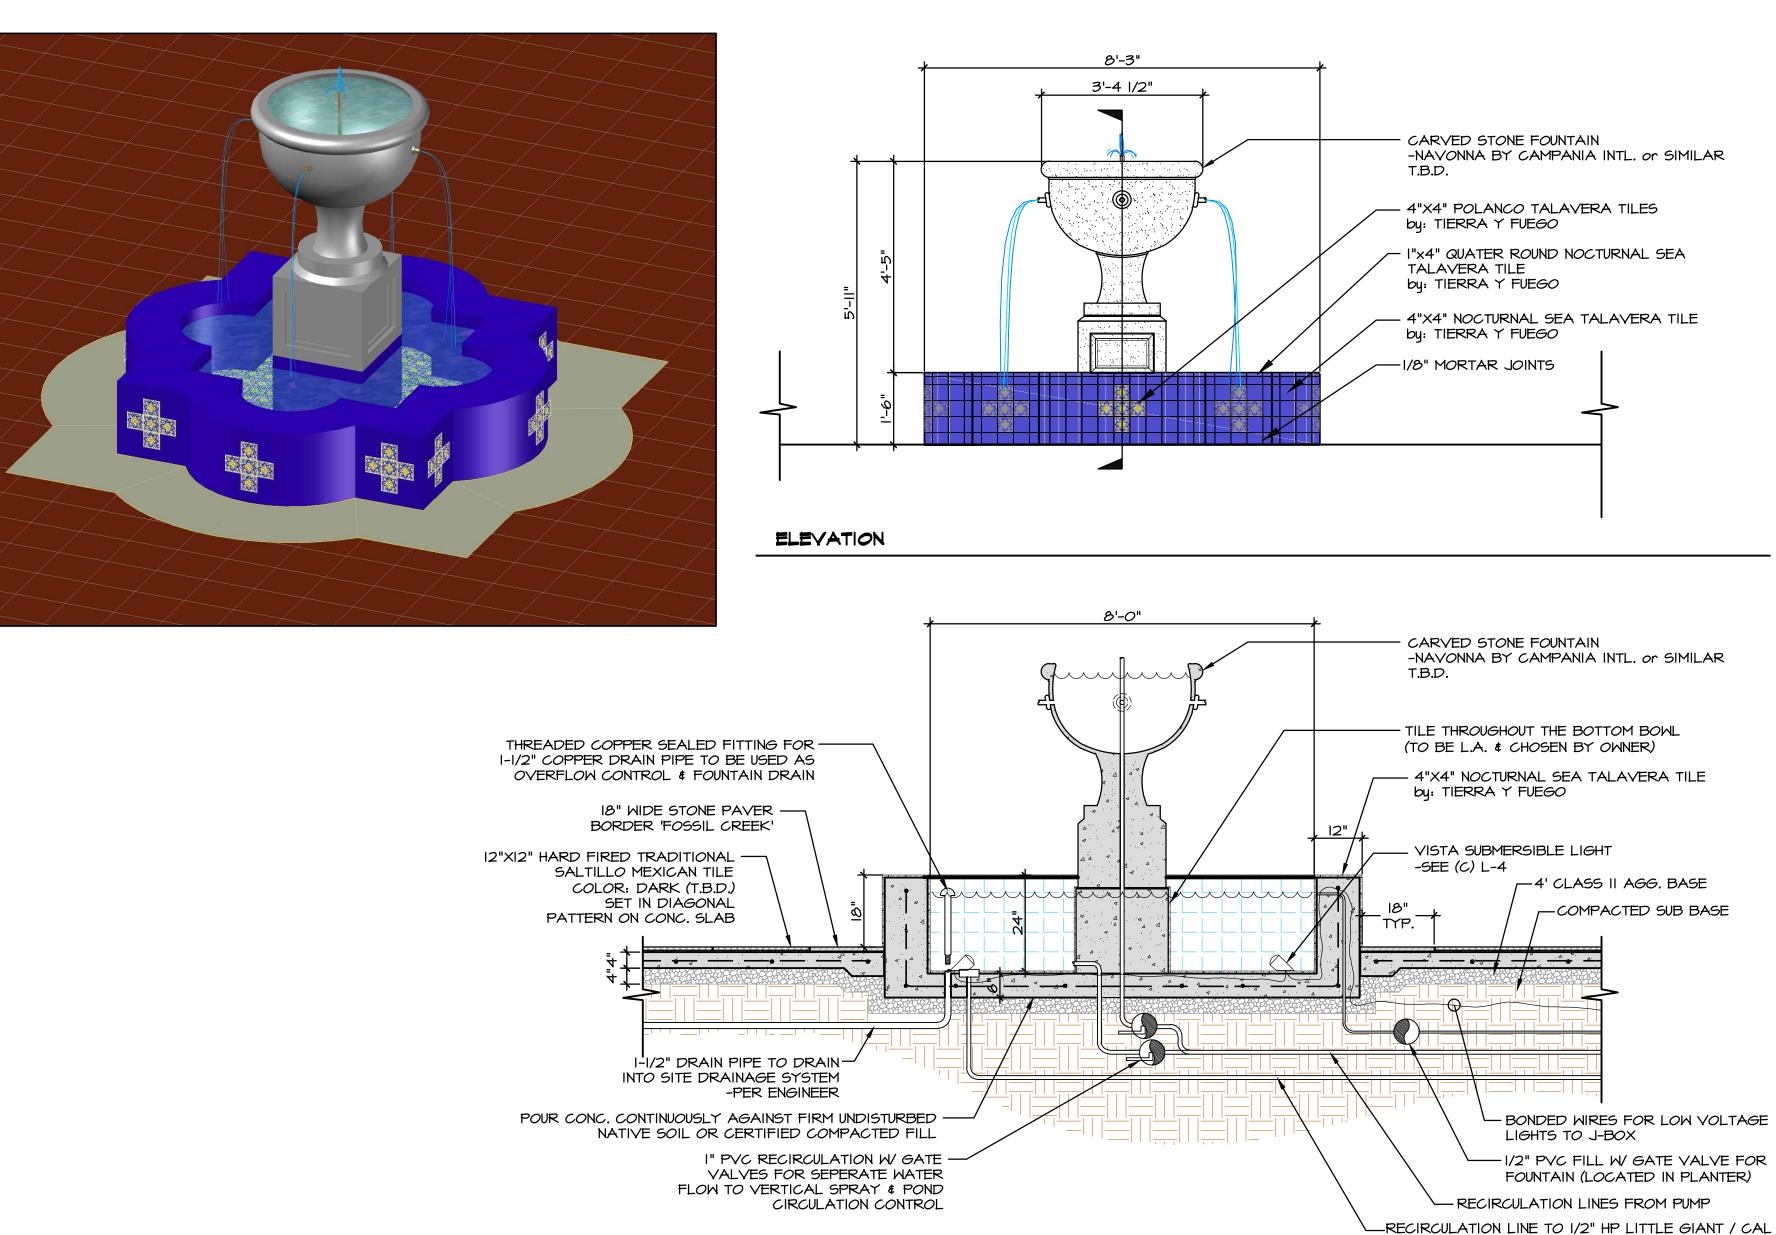



Weight	70 lbs
Dimensions	W 71 x D 25 x H 37 in
Material	A-Grade Teak
Arm Height	27
Seat Height	18
Seat Depth	20

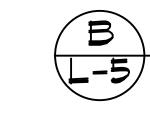

SITE BENCHES

SECTION @ FOUNTAIN

The landscape architect and his consultants do not warrant or guarantee the accuracy and completeness of the work product, the landscape architect shall be promptly notified so that he may have the opportunity to take whatever steps necessary to resolve them. Failure to promptly notify the landscape architect from any responsibility for the consequences of such discrepancies. Actions without the knowledge and consent of the landscape architect from any responsibility for the landscape architect swork product or recommendations shall become the responsibility not of the landscape architect but of the parties responsible taken such action. This plan and design are the exclusive property of Earthform Design and cannot be used or reproduced without the landscape architects written consent.

SECTION

Oate 4/15/24

Scale VARIES


Orawn N.O.T.


Drawn N.O.T.

Job
CHAPAL


Print Date

Sheet

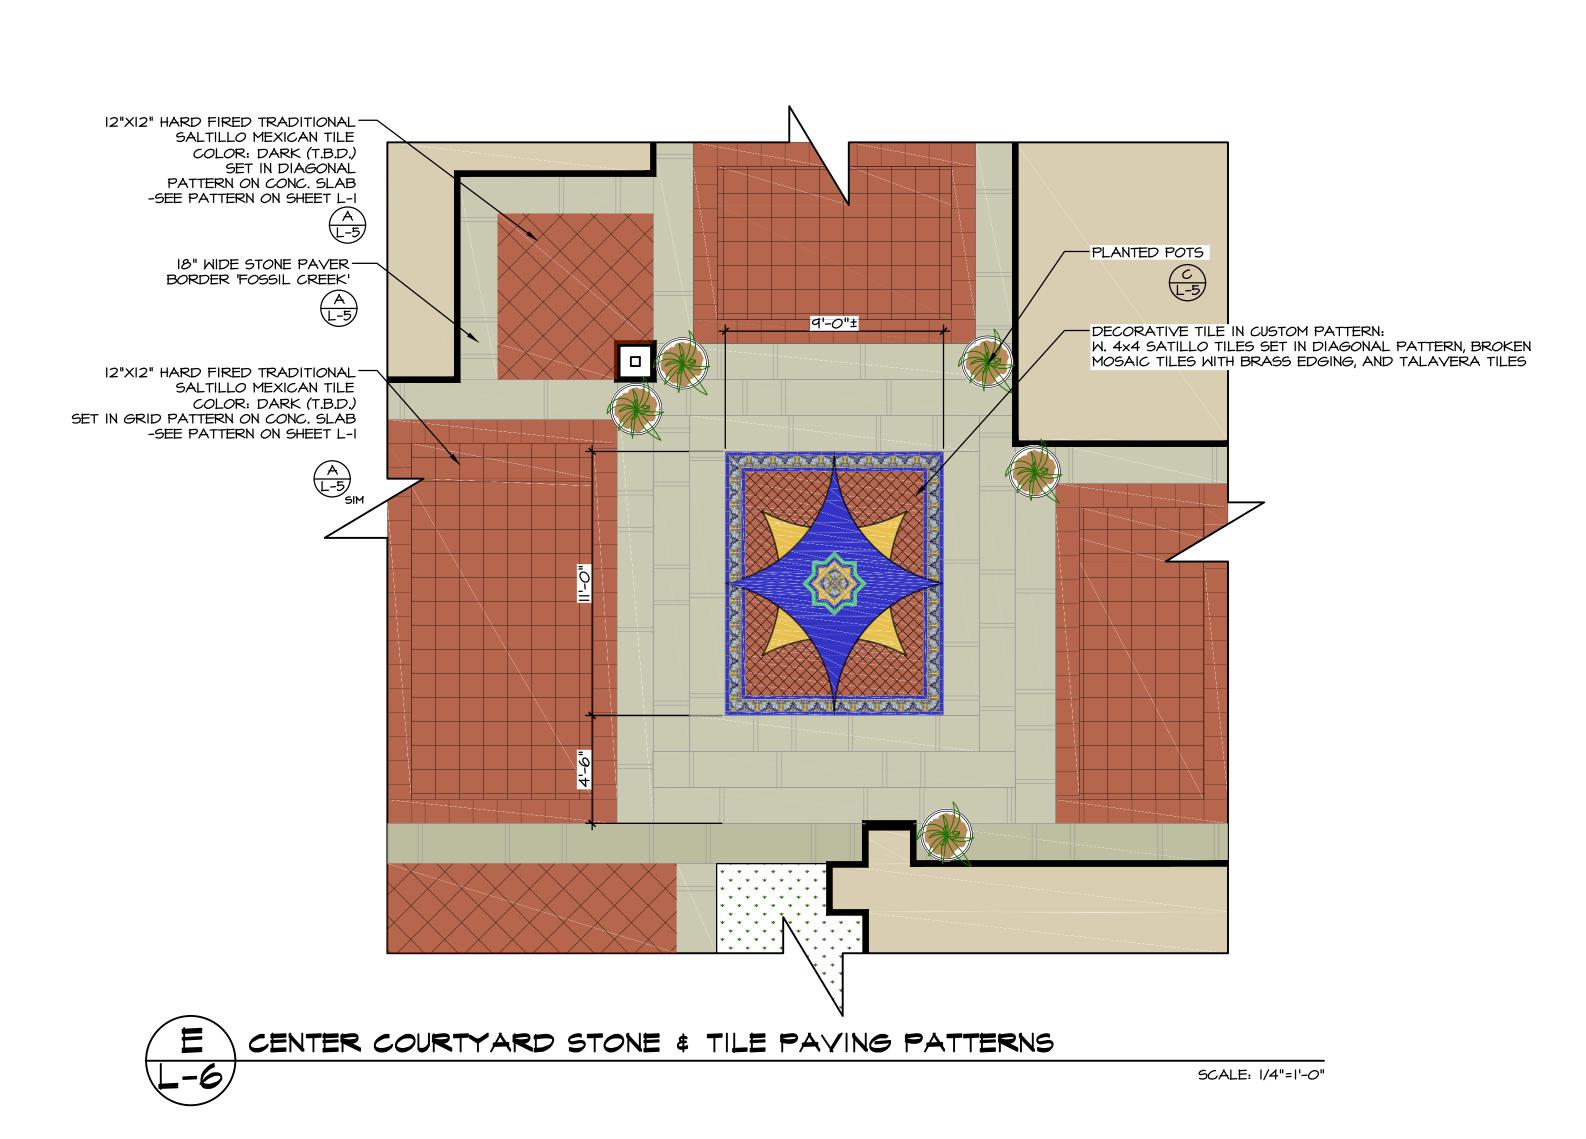

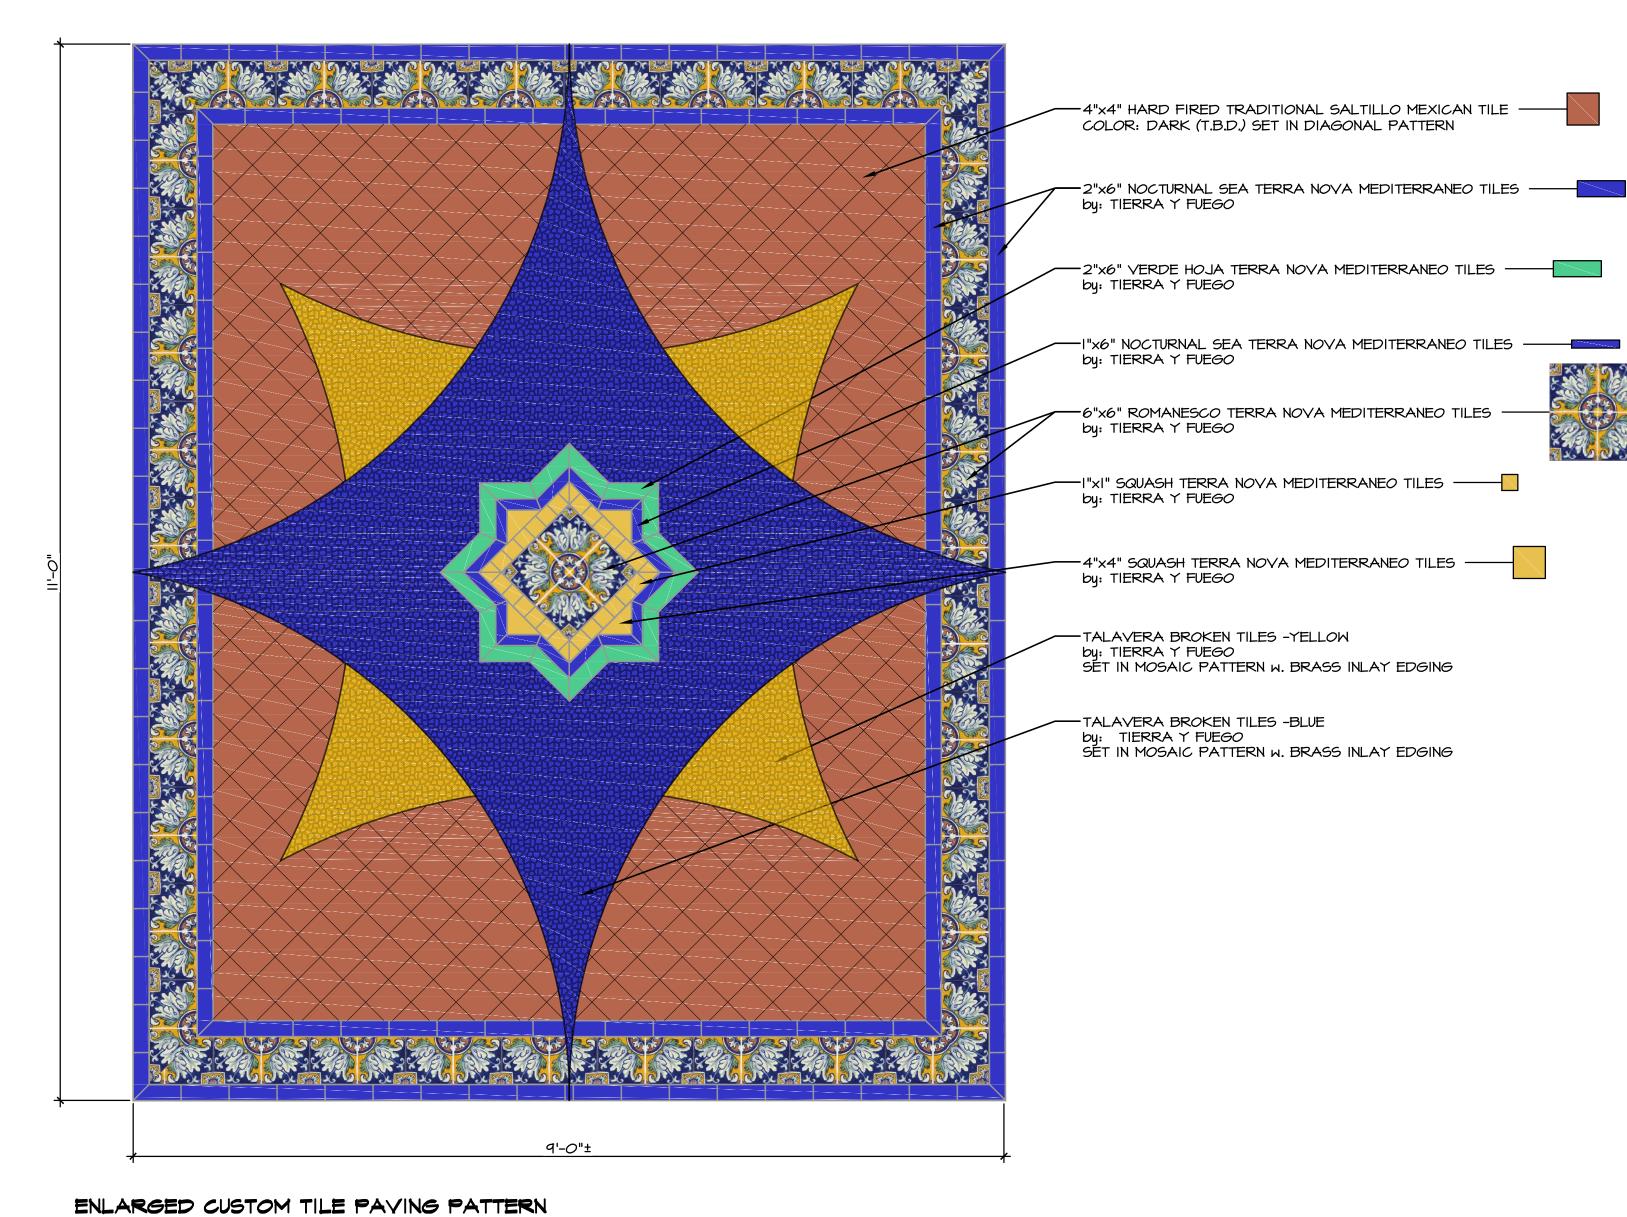

SCALE: |"=1'-0"

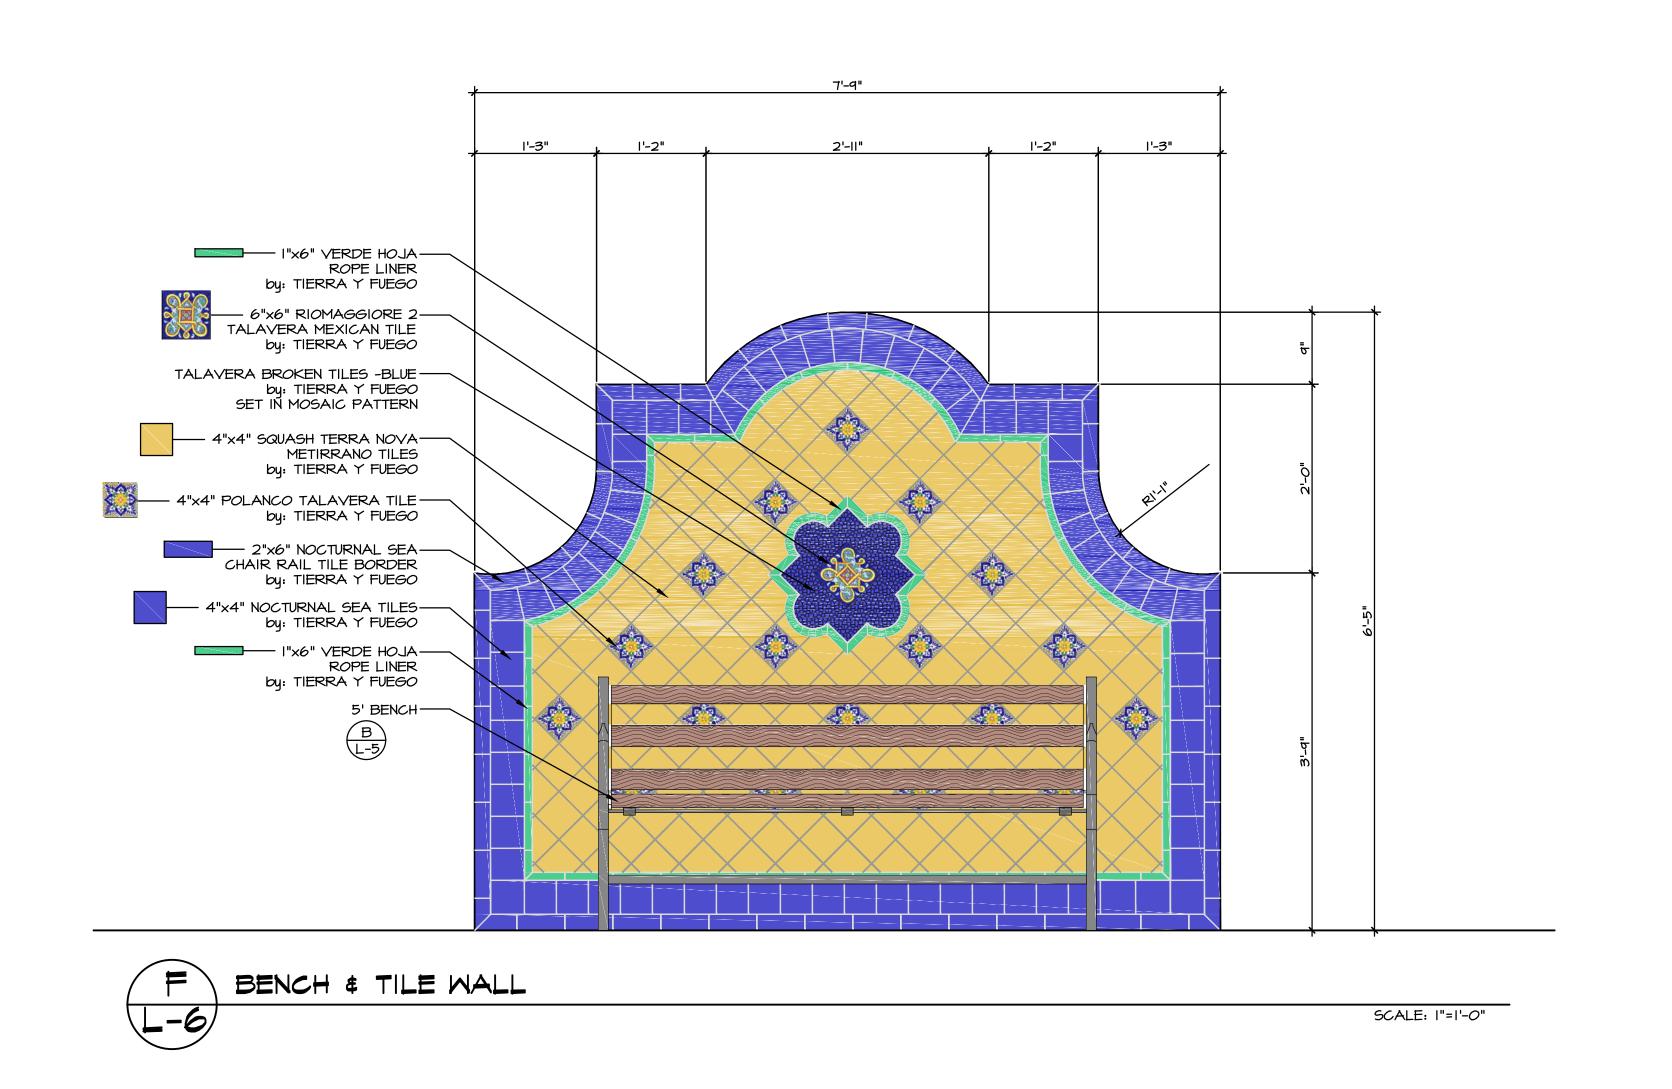

630 CHAPALA STREET MIXED USE

630 CHAPALA ST SANTA BARBARA, CA 93101

LEGEND STORM DRAINAGE SANITARY SEWER POWER ELECTRICAL → DITCH / FLOWLINE GRADE SLOPE ______ SAWCUT

VICINITY MAP

STANDARD ABBREVIATIONS

BLDG

CONC

ECR

ASPHALTIC CONCRETE

BEGIN CURB RETURN

BOTTOM OF PLANTER

BEGIN VERTICAL CURVE

CONCRETE MASONRY UNIT

BOTTOM OF WALL

CATCH BASIN

CENTERLINE

CONCRETE

DRIVEWAY

END CURB RETURN

EDGE OF PAVEMENT

END VERTICAL CURVE

EXISTING GRADE


FINISHED FLOOR

FINISHED GRADE

FINISHED SURFACE

FIRE HYDRANT

FLOW LINE

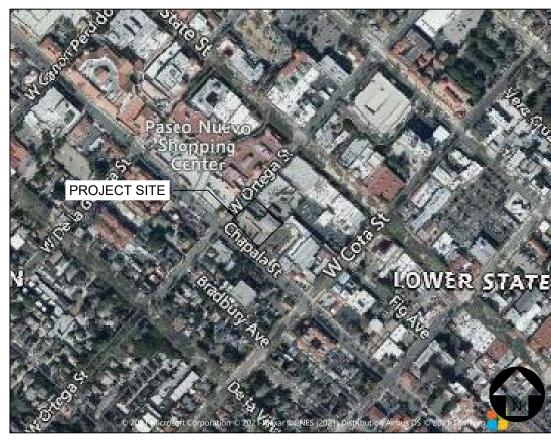

GRADE BREAK

INVERT

INVERT ELEVATION

LANDSCAPE AREA

NATURAL GRADE

PLANTER AREA

PROPERTY LINE

PARKING STRIPE

RIGHT OF WAY

STORM DRAIN

POLYVINYL CHLORIDE

SUB-GRADE ELEVATION

TOP OF CURB, CONCRETE

SANITARY SEWER

TOP OF FOOTING

TOP OF GRATE

TOP OF WALL

VERTICAL CURVE

CONCRETE

POC POINT OF CONNECTION

P/L

PORTLAND CEMENT

SURVEY NOTES

EXISTING TOPOGRAPHIC AND BOUNDARY INFORMATION SHOWN HEREON PER SURVEY BY CHRISTOPHER G. GILMOUR DATED MAY 2020.

BOUNDARY AND EASMENTS SHOWN PER FIDELITY NATIONAL TITLE COMPANY BASIS OF BEARINGS.

BENCHMARK: LOCAL BENCHMARKS SHOWN AS "CP" NAVD 88

FLOOD NOTE: PER FIRM, THE BUILDING FRONTING CHAPALA STREET IS IN THE 0.2% ANNUAL CHANCE FLOOD HAZARD. ZONE X, (06083c1387J EFF. 09/28/2018)

THE PRIOR REVIEW AND APPROVAL BY THE AGENCY HAVING JURISDICTION OVER THE MONUMENT OR BENCHMARK. THE CONTRACTOR SHALL CONTRACT WITH A WITNESS MONUMENTS AND FILE THE REQUIRED DOCUMENTATION WITH THE AUTHORITY HAVING JURISDICTION, PURSUANT TO ALL APPLICABLE BUSINESS AND PROFESSIONAL CODES.

UTILITY PURVEYORS

ELECTRICITY: SOUTHERN CALIFORNIA EDISON

http://www.sce.com/

WATER/SEWER: CITY OF SANTA BARBARA WATER AND WASTEWATER

SANTA BARBARA, CA 93102-1990 (805) 564-5387

NATURAL GAS: SOUTHERN CALIFORNIA GAS COMPANY

P.O. BOX C MONTEREY PARK, CA 91756 (800)-427-2200

COX COMMUNICATIONS 3303 STATE STREET

SANTA BARBARA, CA (805) 681-6600

FRONTIER COMMUNICATIONS

CITY OF SANTA BARBARA SWMP SUMMARY (2013)

•		(2010)
EXIS REM REPI NEW MAIN	ITE IMPROVEMENTS: TING IMPERVIOUS TO REMAIN OVED IMPERVIOUS AREA LACED IMPERVIOUS AREA IMPERVIOUS AREA ITAINED IMPERVIOUS AREA CITY OF SANTA BARBARA TIER 3 (20	616 SF 24,276 SF 658 SF 0 SF
EXIS REM REPI NEW MAIN	HT-OF-WAY IMPROVEMENTS: TING IMPERVIOUS TO REMAIN OVED IMPERVIOUS AREA LACED IMPERVIOUS AREA IMPERVIOUS AREA ITAINED IMPERVIOUS AREA CITY OF SANTA BARBARA TIER 1 (20	245 SF 0 SF 264 SF 2,166 SF
EXIS REM REPI NEW MAIN	EST ORTEGA STREET IMPROVEME TING IMPERVIOUS TO REMAIN OVED IMPERVIOUS AREA LACED IMPERVIOUS AREA IMPERVIOUS AREA ITAINED IMPERVIOUS AREA CITY OF SANTA BARBARA TIER 1 (20	24,276 SF 0 SF 127 SF 0 SF 1,465 SF
CITY ROU FOLL	QSP 72 HOURS PRIOR TO THE NEE TE THE REQUEST TO THE QSP INSF	CTION BY THE CITY BUILDING INSPECTOR EDED INSPECTION. THE CITY WILL THEN PECTOR OR THIRD PARTY COMPANY. THE ECTIONS MUST BE COMPLETED FOR
•	ERGROUND INFILTRATION BMP (DE INSPECTION OF SUBGRADE INSPECTION OF BASE ROCK FINAL INSPECTION OF UNDERGROU	

BACKFILLING WITH LANDSCAPE MATERIAL

CONTRACTOR SHALL CALL FOR INSPECTION BY THE SOILS ENGINEER, GEOSOLUTIONS, 72 HOURS PRIOR TO THE NEEDED INSPECTION. THE FOLLOWING LIST OF MANDATORY INSPECTIONS MUST BE COMPLETED BEFORE AND DURING CONSTRUCTION:

- THE FINAL GRADING AND DRAINAGE PLANS SHALL BE OBSERVED AND APPROVED PRIOR TO THE START OF CONSTRUCTION.
- CONSTRUCTION INSPECTIONS AND TESTING, AS REQUIRED, DURING ALL GRADING AND EXCAVATING OPERATIONS BEGINNING WITH THE STRIPPING OF VEGETATION AT THE SITE, AT WHICH TIME A SITE MEETING OR PRE-JOB MEETING WOULD BE APPROPRIATE.

PROJECT INFORMATION		
CLIENT:	THIRD GENERATION SB, LLC 629 STATE STREET, SUITE 240 SANTA BARBARA, CA 93101	
LANDSCAPE ARCHITECT:	EARTHFORM DESIGN 1227 DE LA VINA STREET SANTA BARBARA, CA 93101 (805) 963-8335	
ARCHITECT:	TOM MEANEY ARCHITECT 629 STATE STREET, SUITE 240 SANTA BARBARA, CA 93101 (805) 895-2836	
GEOTECHNICAL:	GEOSOLUTIONS 201 SOUTH MILPAS, UNIT 103 SANTA BARBARA, CA 93103 (805) 966-2200	
SURVEYOR:	GILMOUR LAND SURVEYING, INC. 7127 HOLLISTER AVENUE, #25A-301 SANTA BARBARA, CA 93117	

(805) 685-4500 037-131-024


SITE AREA: 0.63 AC AREA DISTURBED: 0.63 AC

GRADING INFORMATION*

CUT QUANTITY: 950 CUBIC YARDS 0 CUBIC YARDS FILL QUANTITY: NET QUANTITY: 950 CUBIC YARDS EXPORT

*NOTE: THE ABOVE QUANTITIES ARE FOR PLANNING AND PERMITTING PURPOSES ONLY. SHRINKAGE; CONSOLIDATION AND SUBSIDENCE FACTORS; LOSSES DUE TO CLEARING AND DEMOLITION OPERATIONS; AND TRENCHING FOR UTILITIES AND FOUNDATIONS ARE NOT INCLUDED. ESTIMATED EARTHWORK QUANTITIES ARE BASED ON THE APPROXIMATE DIFFERENCE BETWEEN EXISTING GRADES AND PROPOSED FINISHED GRADES OR PAVEMENT SUBGRADES. AS INDICATED ON THE PLANS, AND SHOULD VARY ACCORDING TO THESE FACTORS AND LOSSES. THE CONTRACTOR SHALL PERFORM AN EARTHWORK ESTIMATE FOR THE PURPOSE OF PREPARING A LUMP SUM BID PRICE FOR EARTHWORK. THE BID PRICE SHALL INCLUDE COSTS FOR ANY NECESSARY IMPORT AND PLACEMENT OF EARTH MATERIALS OR THE EXPORT AND PROPER DISPOSAL OF EXCESS EARTH MATERIALS.

DIG ALERT

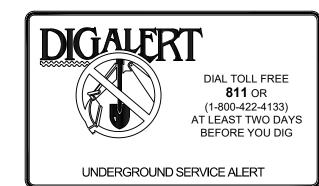

PRIOR TO COMMENCING OF ANY EXCAVATION, DIGGING, POT HOLING, ETC. CALL DIG ALERT FOR ASSIGNMENT OF AN INQUIRY ID NUMBER, BECAUSE NO EARTH WORK SHALL COMMENCE UNLESS THE CONTRACTOR HAS OBTAINED THIS AND EACH UTILITY OR OWNER OF SUBSURFACE FACILITIES HAS LOCATED AND MARKED THEIR SUBSURFACE FACILITIES IN THE AREA

SHEET INDEX

SHEET	SHEET TITLE
C-0.1	TITLE SHEET

C-0.2 NOTES SHEET C-1.1 GRADING AND DRAINAGE PLAN

C-2.1 UTILITY SHEET

C-3.1 DETAIL SHEET

The use of these plans and specifications shall be restricted to the original site for which they were prepared and publication thereof is expressly limited to specifications remain with Ashley & Vance Engineering Inc. without prejudice. Visual contact with these plans and specifications shall constitute prima facie evidence of the acceptance of these restrictions



Project Manager: JJG Date: 02/21/2024 Scale: PER PLAN AV Job No: 211359 Sheet Size: 30" x 42"


Project Engineer: ECR

TITLE SHEET

OTHERWISE DAMAGED BEFORE NEW PAVEMENT IS PLACED. CONTRACTOR SHALL SAWCUT A NEW CONFORM LINE PARALLEL WITH FULL LENGTH OF AND SUFFICIENT DISTANCE BEHIND ORIGINAL SAWCUT SO AS TO REMOVE DAMAGED PAVEMENT AND/OR IRREGULARITY ALONG THE CONFORM

The use of these plans and specifications shall be restricted to the original site for which they were prepared and publication thereof is expressly limited to such use. Reproduction or publication by any method, in whole or in part, is prohibited. Title to these plans and specifications remain with Ashlev & Vance Engineering Inc. without prejudice. Visual contact with these plans and specifications shall constitute prima facie evidence of the acceptance of these restrictions

Engineer of Record:

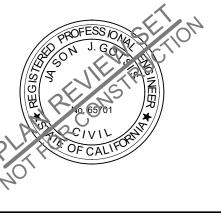

Project Engineer: ECR Ext: 152

AV Job No: 211359 | Sheet Size: 30" x 42"

02/21/2024 | Scale: PER PLAN

Project Manager: JJG

NOTES SHEET

GENERAL NOTES:

- 1. SEE DEMOLITION AND PROTECTION PLAN FOR ADDITIONAL INFORMATION.
- 2. SEE LANDSCAPE PLANS FOR TREE REMOVALS AND RELOCATIONS.
- 3. CITY OF PUBLIC WORKS ENGINEERING CIP IS CURRENTLY STUDYING THE STORM WATER TRANSPORTATION ALONG WEST ORTEGA AND CHAPALA STREETS AT THE PROJECT LOCATION. SEE PLANS FROM CITY PROJECT NO. XX.

CONTACT: XX, PE PHONE: (805) XXX-XXXX

- 4. CONNECTION FROM DRAIN INLETS TO STORM DRAIN SYSTEM NOT SHOWN FOR PLANNING REVIEW FOR PLAN CLARITY. ALL WATER THAT ENTER STORM DRAIN INLETS ARE TREATED BY THE ADS STORMTECH CHAMBERS.
- 5. ALL DEMOLITION AND GRADING SHALL BE IN COMPLIANCE WITH THE RECOMMENDATIONS CONTAINED IN THE SOILS REPORT PREPARED BY GEO SOLUTIONS , FILE NO. SB01323-1, DATED MAY 4, 2021 AND ALL ADDENDA TO THE REPORT SHALL BE CONSIDERED PART OF THESE PLANS. CONTRACTOR SHALL CONTACT SOILS ENGINEER PRIOR TO START OF DEMOLITION WORK.

CONTACT: BRAD BUCHER, PE PHONE: (805) 235-2239

6. TIER 3 (2013) BMP COMPLIANCE REQUIREMENT:

BEFORE THE BUILDING INSPECTOR WILL GRANT CERTIFICATE OF OCCUPANCY AND FINALIZE THE BUILDING PERMIT, THE CONTRACTOR IS TO HAVE THE BUILDING AND SAFETY DIVISION CERTIFY POST-CONSTRUCTION BMP'S WERE INSTALLED AS APPROVED AND THAT THEY COMPLY WITH THE CITY OF SANTA BARBARA'S TIER 3 STORM WATER REQUIREMENTS.


- **RIGHT OF WAY CONSTRUCTION NOTES:** CONSTRUCT CONCRETE CURB AND GUTTER WITH 8" CONCRETE CURB AND 18" GUTTER PER CITY OF SANTA BARBARA STANDARD DETAILS H-01.0 AND H-02.0.
- (2) CONSTRUCT PLANTER AREA PER LANDSCAPE PLANS.
- CONSTRUCT COMMERCIAL DRIVEWAY PER CITY OF SANTA BARBARA STANDARD DETAILS H-01.0 AND H-03.1.
- CONSTRUCT CONCRETE SIDEWALK PER CITY OF SANTA BARBARA STANDARD DETAILS H-01.0, H-06.0 AND H-06.1.
- CONSTRUCT CONCRETE BLENDED TRANSITION ACCESS RAMP PER CITY OF SANTA BARBARA 5 CONSTRUCT CONCRETE BLEIDED 110.11.C....S. STANDARD DETAILS H-01.0, H-07.0 AND H-07.4.
- 6 CONSTRUCT TYPE B CURB OUTLET PER CITY OF SANTA BARBARA STANDARD DETAIL D-05.2.
- 7 PROTECT EXISTING STREET LIGHT.
- 8 PROTECT EXISTING TRAFFIC LIGHT.
- 9 PROTECT EXISTING STREET SIGN.
- (10) PROTECT EXISTING PLANTER.
- (11) PROTECT EXISTING SIDEWALK.


SITE CONSTRUCTION NOTES:

- (1) CONSTRUCT ASPHALT DRIVEWAY SECTION.
- 2 CONSTRUCT IMPERVIOUS WALKWAY PER LANDSCAPE ARCHITECT.
- (3) CONSTRUCT PLANTER PER LANDSCAPE ARCHITECT.

STORM DRAIN CONSTRUCTION NOTES:

- (SD1) CONSTRUCT ROOF DRAIN CONNECTION PER DETAIL 2, SHEET C-3.1.
- CONSTRUCT 12-INCH PEDESTRIAN RATED FLAT GRATE DRAIN WITH 12" CATCH BASIN FILTER PER DETAIL 4, SHEET C-3.1.
- CONSTRUCT 4-INCH CLASS 100 PVC STORM DRAIN LINE PER MANUFACTURERS SPECIFICATIONS AND RECOMMENDATIONS AND DETAIL 1, SHEET C-3.1.
- CONSTRCT 6-INCH CLASS 100 PVC STORM DRAIN LINE PER MANUFACTURERS SPECIFICATIONS AND RECOMMENDATIONS AND DETAIL 1, SHEET C-3.1.
- (SD5) CONSTRUCT TRENCH DRAIN.
- CONSTRUCT ADS STORMTECH SC-740 CHAMBERS PER MANUFACTURERS SPECIFICATIONS AND RECOMMENDATIONS AND DETAIL 3, SHEET C-3.1. CHAMBERS TO BE SET UP IN A 4X4 SETUP.
- CONSTRUCT 9-INCH PEDESTRIAN RATED FLAT GRATE DRAIN WITH 9" CATCH BASIN FILTER PER
- CONSTRUCT 12-INCH TRAFFIC RATED FLAT GRATE DRAIN WITH 12" CATCH BASIN FILTER PER DETAIL 4, SHEET C-3.1.

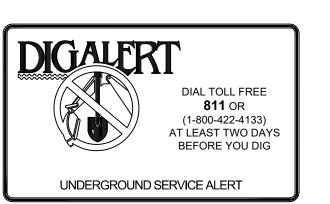

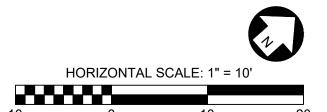

K

Project Engineer: ECR Ext: 152 Project Manager: JJG 02/21/2024 | Scale: PER PLAN AV Job No: 211359 Sheet Size: 30" x 42"


DRAINAGE PLAN

GRADING AND

C-1.1

The use of these plans and specifications shall be restricted to the original site for which they were prepared and publication thereof is expressly limited to such use. Reproduction or publication by any method, in whole or in part, is prohibited. Title to these plans and specifications remain with Ashley & Vance Engineering, Inc. without prejudice. Visual contact with these plans and specifications shall constitute prima facie evidence of the acceptance of these restrictions.

Engineer of Record:

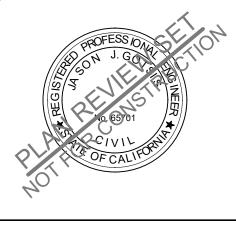

ALL EXISTING UTILITIES SHOWN ARE BASED ON THE BEST AVAILABLE INFORMATION. CONTRACTOR TO POTHOLE ALL POINTS OF CONNECTION AND VERIFY ALL CLEARANCES. MATERIAL DEPTH AND LOCATION SHALL BE IDENTIFIED BY CONTRACTOR. IF THERE ARE ANY DIFFERENCES FROM PLAN WITH ANY OF THESE ITEMS, ENGINEER OF WORK SHALL BE NOTIFIED IMMEDIATELY.

ELECTRICAL NOTES:

E1 INSTALL ELECTRICAL SERVICE PER OTHERS.

GAS NOTES:

G1 CONSTRUCT GAS SERVICE PER OTHERS.

SANITARY SEWER CONSTRUCTION NOTES:

- (SS1) INSTALL SANITARY SEWER LATERAL PER OTHERS.
- (SS2) INSTALL SEWER CLEANOUT PER OTHERS.
- (SS4) INSTALL GREASE INTERCEPTOR PER OTHERS.

SS3 SEWER POINT OF CONNECTION AT BUILDING.

WATER CONSTRUCTION NOTES:

W1 INSTALL FIRE HYDRANT PER CITY OF SANTA BARBARA STANDARD DETAIL W-01.0, W-01.1, W-02.0, AND W-03.0.

W2 INSTALL FIRELINE PER OTHERS.

W3 INSTALL PRIVATE WATER MAIN PER OTHERS.

W4 INSTALL COMMERCIAL WATER METERS PER OTHERS.


W5 INSTALL PRIVATE WATER METER PER OTHERS.

W6 INSTALL LANDSCAPE METER PER OTHERS.

GENERAL NOTES:

The use of these plans and specifications shall be restricted to the original site for which they were prepared and publication thereof is expressly limited to such use. Reproduction or publication by any method, in whole or in part, is prohibited. Title to these plans and specifications remain with Ashley & Vance Engineering, Inc. without prejudice. Visual contact with these plans and specifications shall constitute prima facie evidence of the acceptance of these restrictions.

Engineer of Record:

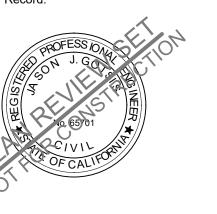

Project Engineer: ECR Project Manager: JJG Date: 02/21/2024 Scale: PER PLAN

AV Job No: 211359 Sheet Size: 30" x 42"


UTILITY SHEET

HORIZONTAL SCALE: 1" = 10'

K


DIAL TOLL FREE **811** OR (1-800-422-4133) AT LEAST TWO DAYS BEFORE YOU DIG

UNDERGROUND SERVICE ALERT

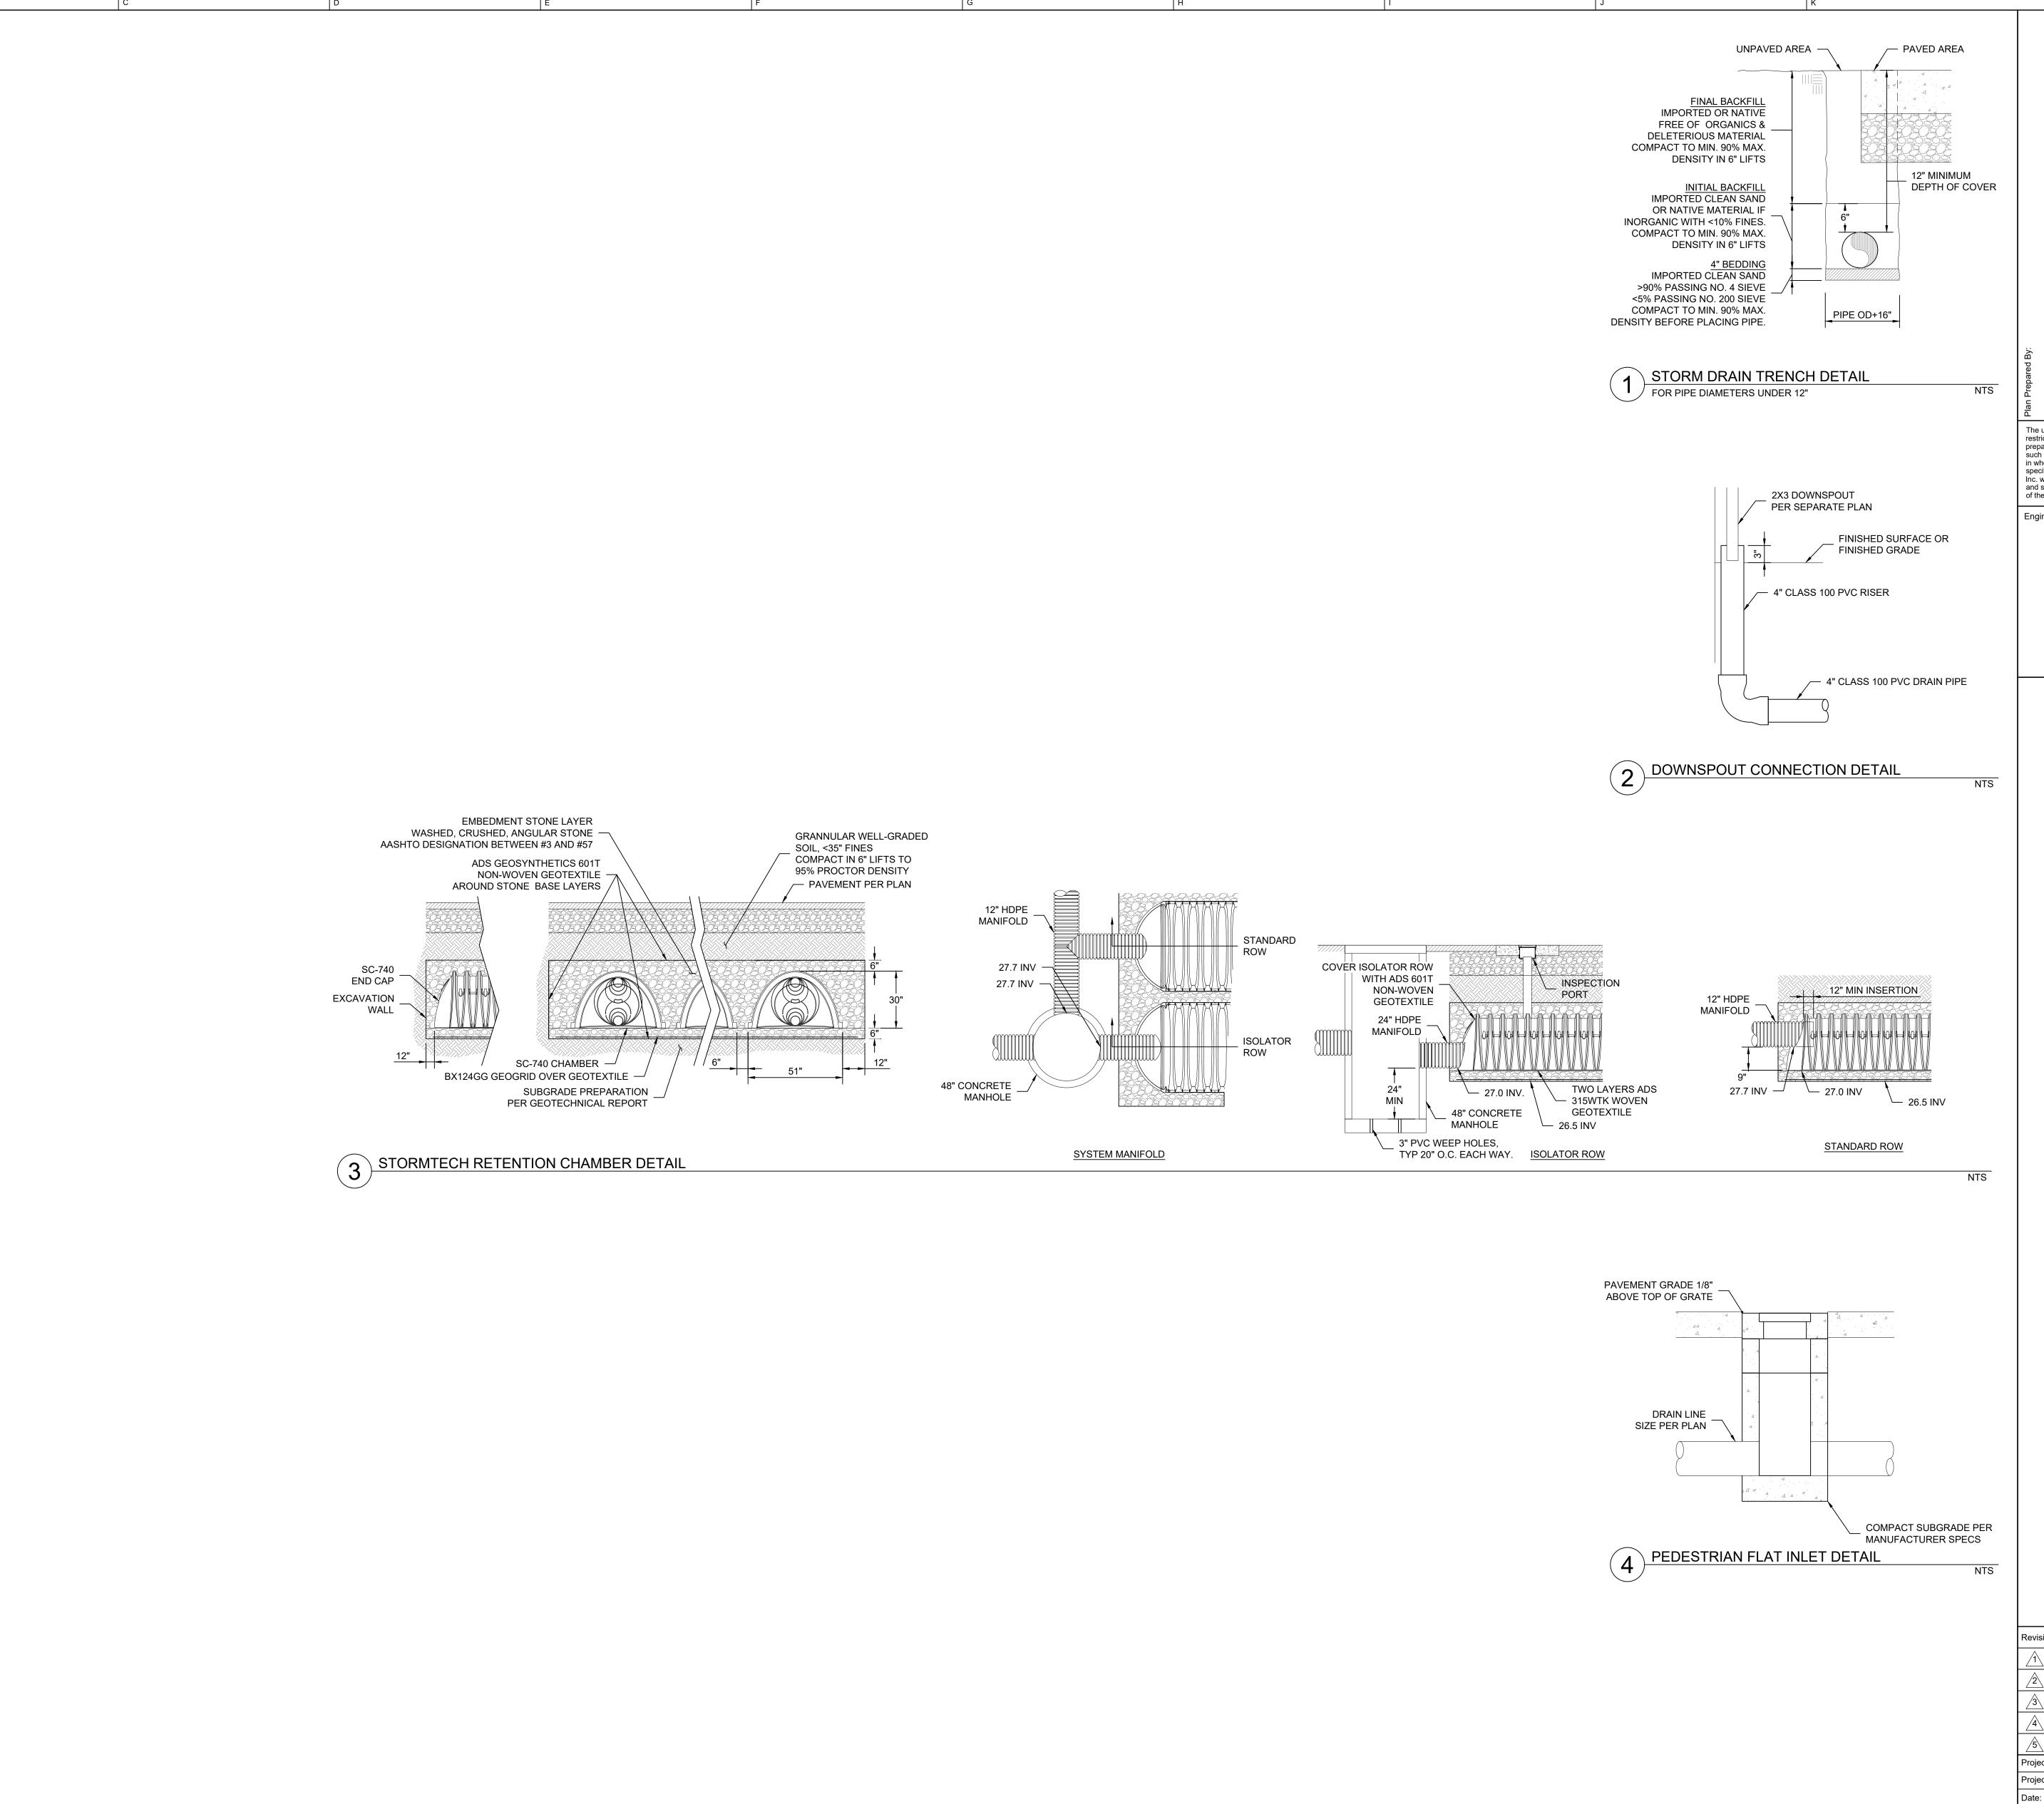

The use of these plans and specifications shall be restricted to the original site for which they were prepared and publication thereof is expressly limited to such use. Reproduction or publication by any method, in whole or in part, is prohibited. Title to these plans and specifications remain with Ashley & Vance Engineering, Inc. without prejudice. Visual contact with these plans and specifications shall constitute prima facie evidence of the acceptance of these restrictions.

Engineer of Record:

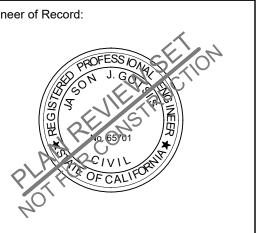

93101 630

Project Engineer: ECR Ext: 152 Project Manager: JJG Date: 02/21/2024 Scale: PER PLAN AV Job No: 211359 Sheet Size: 30" x 42"

DETAIL SHEET